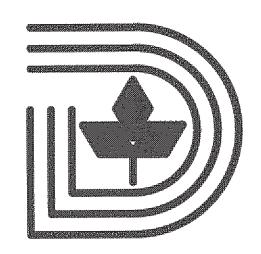
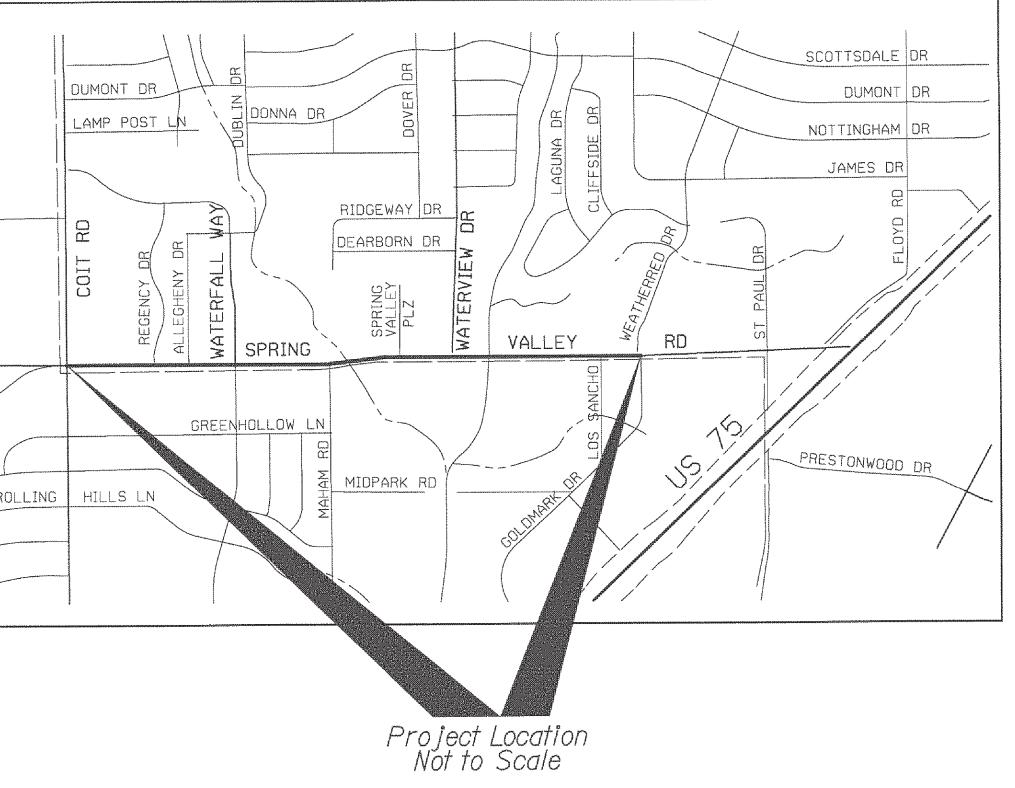
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from	CO
GENERAL	
 All existing utilities are shown at approximate locations and depths are based on the best available records and limited field data. The Engineer does not certify that all utilities are shown. The Contractor shall verify exact locations.sizes and depths of existing utilities before begining construction (including ordering pre-cast manholes and concrete pipe if applicable). NO SEPARATE PAY ITEM The Contractor shall coordinate all tie-Ins with the on-site City of Dallas Inspector. The Contractor shall ensure that existing fire hydrants are accessible to fire trucks at all times. CAUTIONII Existing underground utilities Involved. Call DIG TESS at I-800-344-8377.48 hours prior to construction for the location of any underground utilities Involved in the area. NO SEPARATE PAY ITEM. The Contractor is responsible for the protection of ALL existing utilities and utility structures. Power poles may have to be braced at Contractor's expense. Contractor shall support underground utilities when excavating or constructing under such utilities. NO SEPARATE PAY ITEM. Reference to Standard Drawings shall mean those shown in the Dallas Water Utilities Standard Drawings for Water & Wastewater Construction (latest edition). All items of work required to complete the work as shown or implied by the plans and specified in the Contract Documents which are not listed as a pay item in the proposal shall be considered incidental. 	Ds (
WATER DESIGN	Cor
The existing water line is to be used as a service line until the proposed main has been tested, approved and placed in service.	
 Abandon all valves on abandoned water mains as per DWU Standard Drawing 219. NO SEPARATE PAY ITEM. The contractor shall salvage fire hydrants and deliver them to 2901 Municipal Street, Monday thru Friday 	
 All bends, tees, fire hydrants and plugs shall be restrained type fittings. Compact fittings shall not be used. All bends shall be blocked with Class "B" concrete as per DWU Standard Drawing pp.229-234. All fire hydrants shall be installed per DWU Standard Drawing 224. Polywrap shall be used on all cast iron fittings and fire hydrant bases. 	
5. All water services are to be replaced from the proposed water main to the meter clearing all existing and proposed utilities and pavement. Relocate and reset all water meters as required and reconnect to existing house services. Install water deadheads to unimproved lots.	
6. Fire hydrant leads and barrels shall be set to grade established for the proposed paving. If the hydrant is not accessible because of existing ground conditions,the hydrant shall be raised with extension (s) as directed by the owner.	
7. All R.C.C.P.water mains shall be installed with bonded joints. All D.I.pipe and fittings shall be polywrapped. All flanged connections are to be insulated as per DWU Standard Drawing 223.	
8. The Contractor shall sequence his construction such that no more than one fire hydrant is out of service at any given time.	DR DR
9 Backfill made on break repairs to existing water mains may have been made with crushed rock. This could present	
a cave-in danger to a new ditch; therefore precautions should be taken by the Contractor.NO SEPARATE PAY ITEM.	EDGECRE
a cave-in danger to a new ditch; therefore precautions should be taken by the Contractor.NU SEPARALE PARTIEM.	
a cave-in danger to a new ditch; therefore precautions should be taken by the Contractor.NU SEPARALE PAY ILEM. 10. If required by the City of Dallas Inspector, the Contractor shall install temporary water lines until the new water mains have been completed, tested, approved, and accepted by DWU.NO SEPARALE PAY ITEM.	-8-
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 a cave-in danger to a new ditch; therefore precautions should be taken by the Contractor.NU SEPARALE PAY ITEM. 10. If required by the City of Dallas Inspector, the Contractor shall install temporary water lines until the new water mains have been completed, tested, approved, and accepted by DWU.NO SEPARATE PAY ITEM. 11. Water services greater than 30 feet shall be a minimum of Linch in diameter. 12. The Contractor shall verify the location of all wastewater laterals and construct new laterals from the wastewater main to the property line with cleanouts and reconnect to the existing laterals for all existing buildings. Deep cut connections may be required. 2. The Contractor shall mantain existing wastewater service and flow at all times. NO SEPARATE PAY ITEM. 3. Prior to reconnection of wastewater laterals, the Contractor shall verify whether the existing lateral is active or inactive. The Contractor is required, as a minimum, to include T.V. survey and perform dye testing. All laterals determined to be inactive shall not be reconnected. The DWU Construction 	PENTON DB

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ASTEWATER MAIN REPLACEMENT PRING VALLEY ROAD T ROAD to GOLDMARK DRIVE



llas Water Utilities ity of Dallas, Texas ract Number: 15 - 029/030F JUNE, 2015





PAVING REPLACEMENT

- I. For proposed paving, bridge and drainage plans in Spring Valley Road from Colt Road to Goldmark Drive, see County Of Dallas 15801-Sheets I to 34 and attachments.
- 2. Temporary paving shall be used over all street, drive and sidewalk cuts (AND TRENCH) within proposed paving limits. Permanent paving shall be used outside proposed paving limits.
- 3. For all construction performed outside paving limits, the contractor will be required to make paving repairs in strict accordance with the City of Dallas Pavement Cut and Repair Standards Manual (latest edition) and the City of Richardson Requirements.

TRAFFIC CONTROL

- I. The Contractor shall provide for the diversion of pedestrians and vehicles during the progress of work In a satisfactory manner to the on-site City of Dallas Inspector and In accordance with the City of Dallas Traffic Barricade Manual, latest edition. NO SEPARATE PAY ITEM.
- 2. The Contractor is responsible for coordinating all new water and wastewater construction with the traffic control plan. Suplemental traffic control needed for the water and wastewater construction shall meet TxDOT traffic control standards.NO SEPARATE PAY ITEM.
- 3. The Contractor shall mantaln vehicular traffic ingress and egress property at all times.
- 4. The Contractor shall replace any pavement markings and signs that are removed or damaged during construction. NO SEPÁRATE PÁY ITEM.

EXTRA NOTES

- I. Shut down of water mains 20" and larger shall ONLY be done during winter months of October 1 st thru April I st. Actual time shall be determined by the DWU Construction Engineer.
- 2. Construct wastewater lateral cleanouts and water meter boxes in the proposed sidewalks where applicable.
- 3. All existing culverts and ditches are to be restored satisfactory to the construction engineer. NO SEPARATE PAY ITEM.
- 4. The Contractor shall provide water services with deadheads and wastewater laterals with cleanouts to all unimproved lots.
- 5. All proposed water mains shall be PVC C900 (DR-14) Class C+ Embedment, except as noted on the plans. 6. All water mains with no profile shall have a minimum cover as follows: 6", 8", 10", and 12" - 48" below finished street grade or 72" below unimproved grade.
- 7. Abandon all manholes on abandoned wastewater mains per DWU Standard Drawing 316.
- 8. Construction ditches in the traffic lanes are to be backfilled or plated after each construction period.
- 9. The Contractor shall not damage or remove any trees or landscaping unless otherwise authorized by the City of Dallas Inspector. Any trees or landscaping that are damaged or removed during the construction shall be replaced by the contractor at his expense.
- IO. Contractor to coordinate the tie ins to the transmission mains with the City of Dallas on-site inspector and Distribution Division 48 hours in advance.
- II. Contractor to verify the position of the transmission main flange outlets before tying in. Reference Drawigns #63-186-L and 63-57-V.
- 12. Contractor to backfill the space between the proposed water and wastewater lines and the existing storm sewer laterals with flowable backfill. No Separate Pay Item.

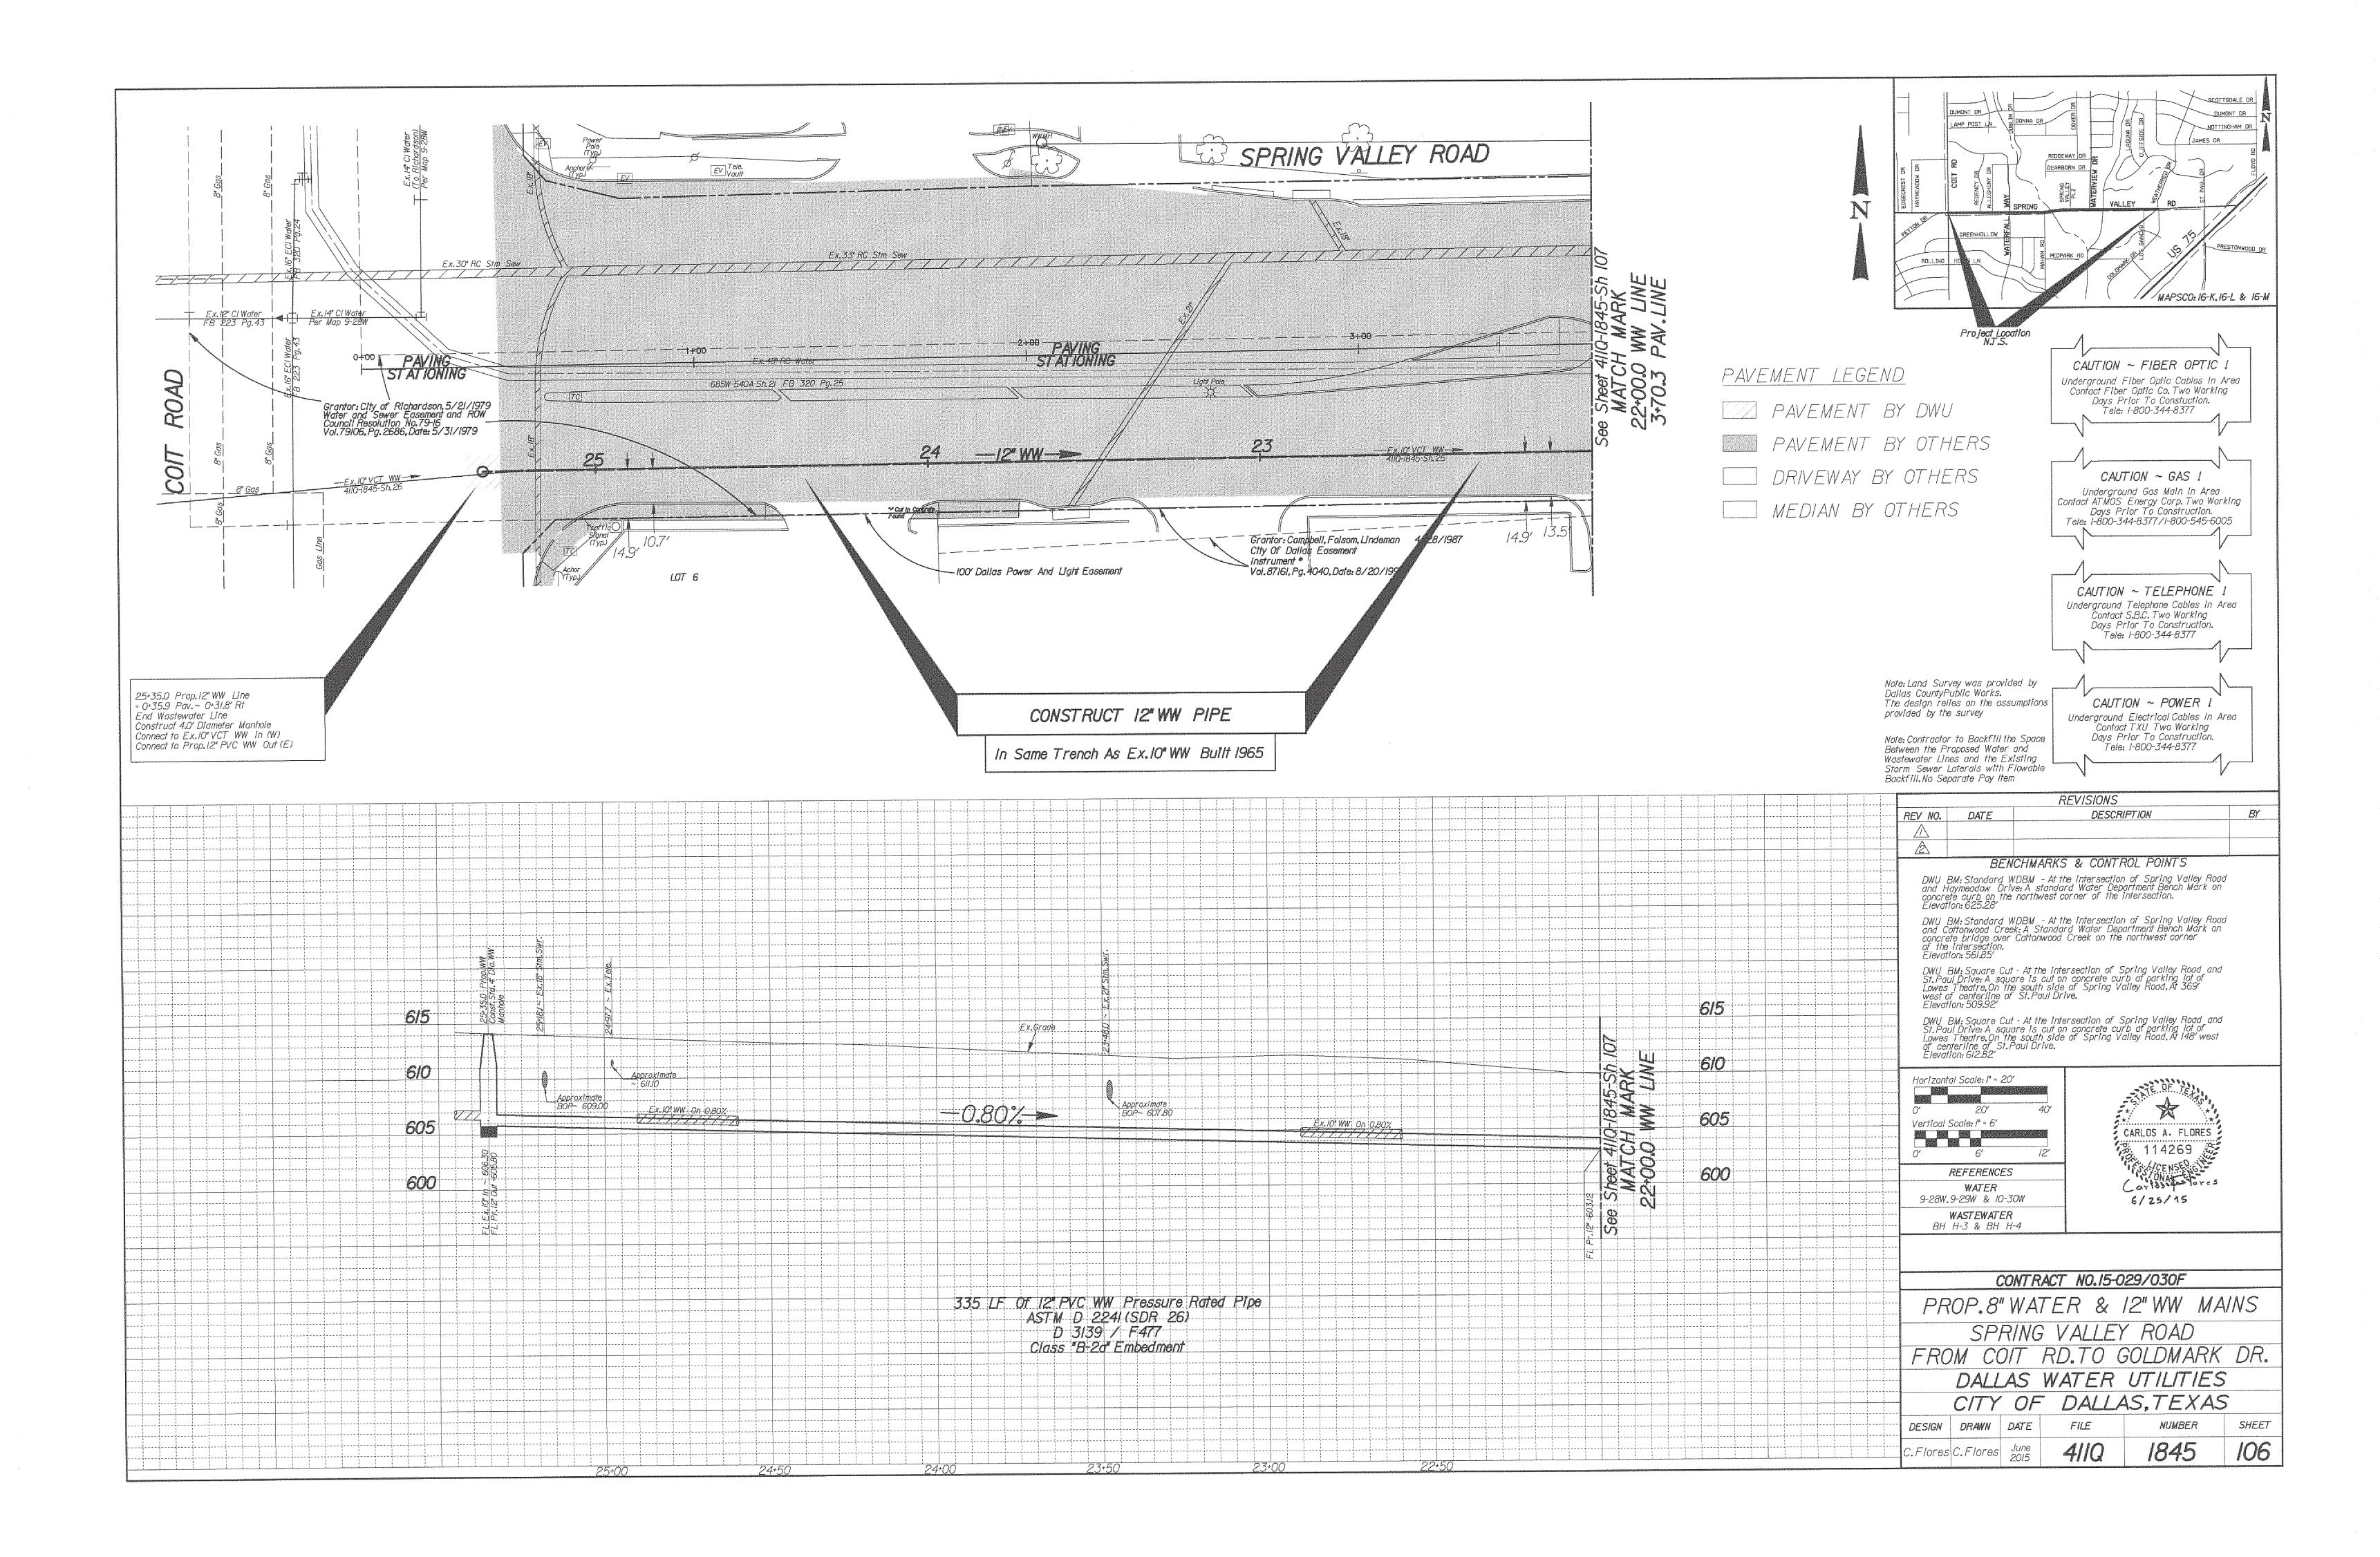
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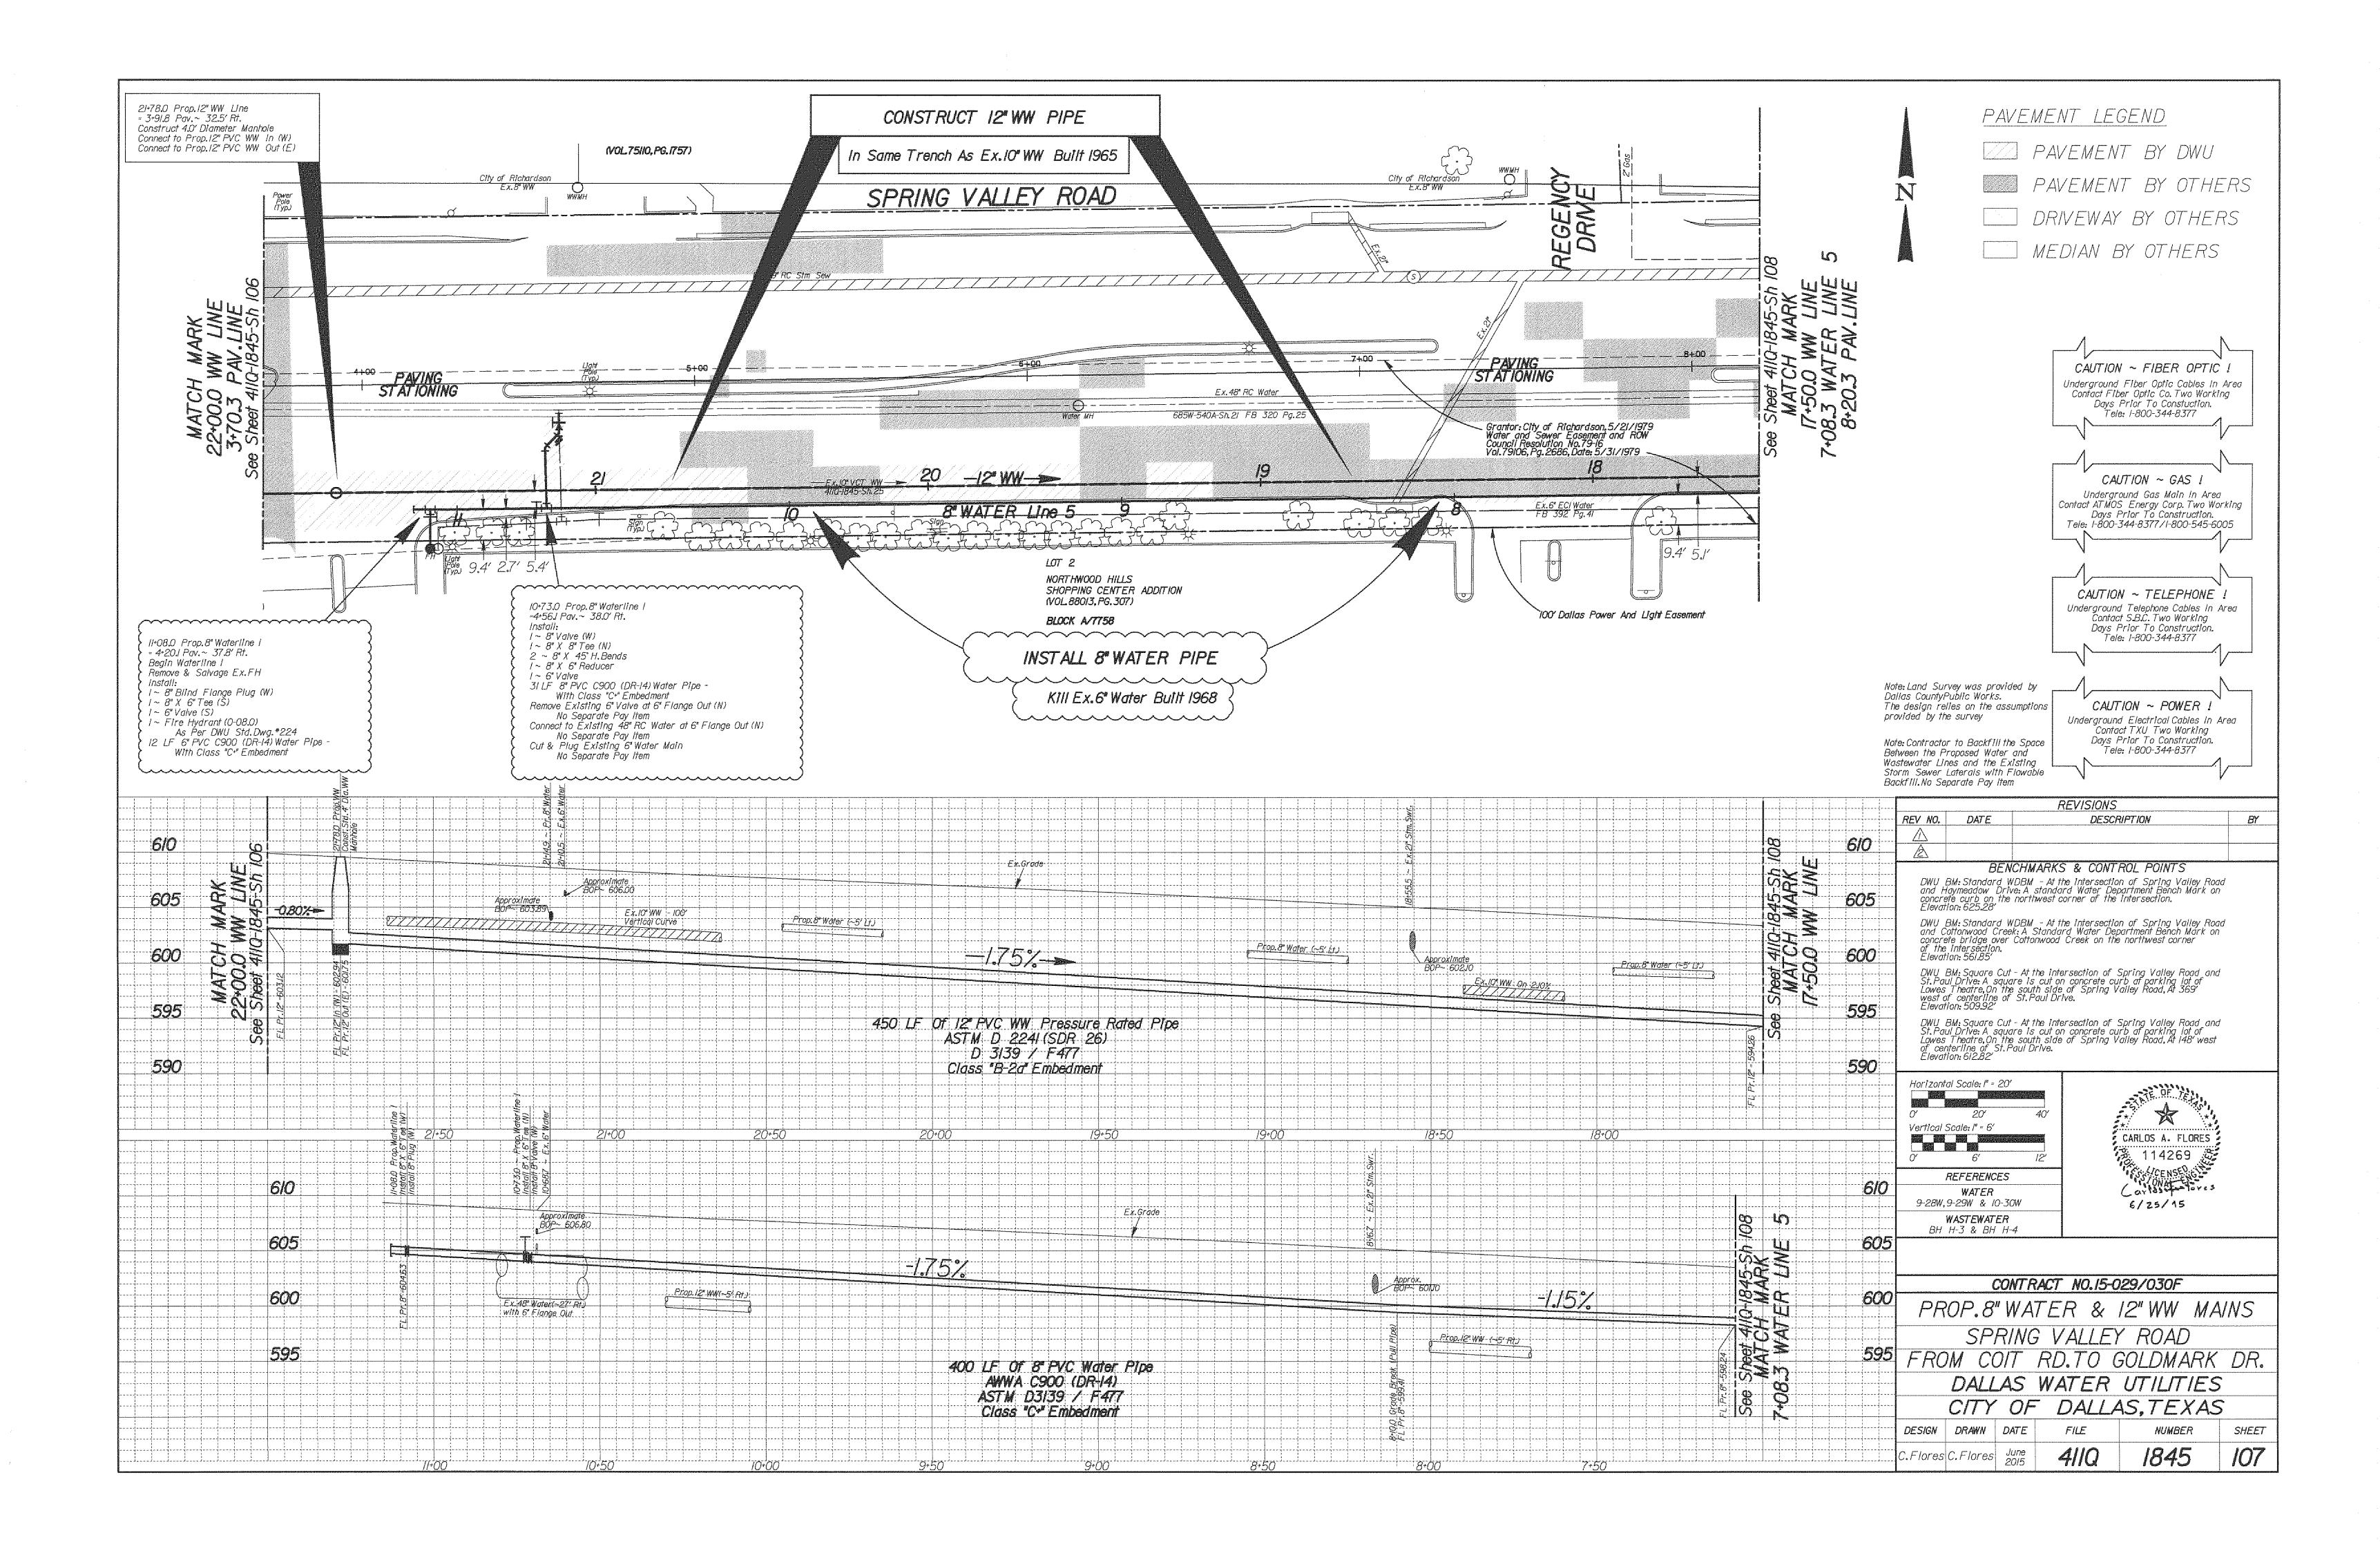
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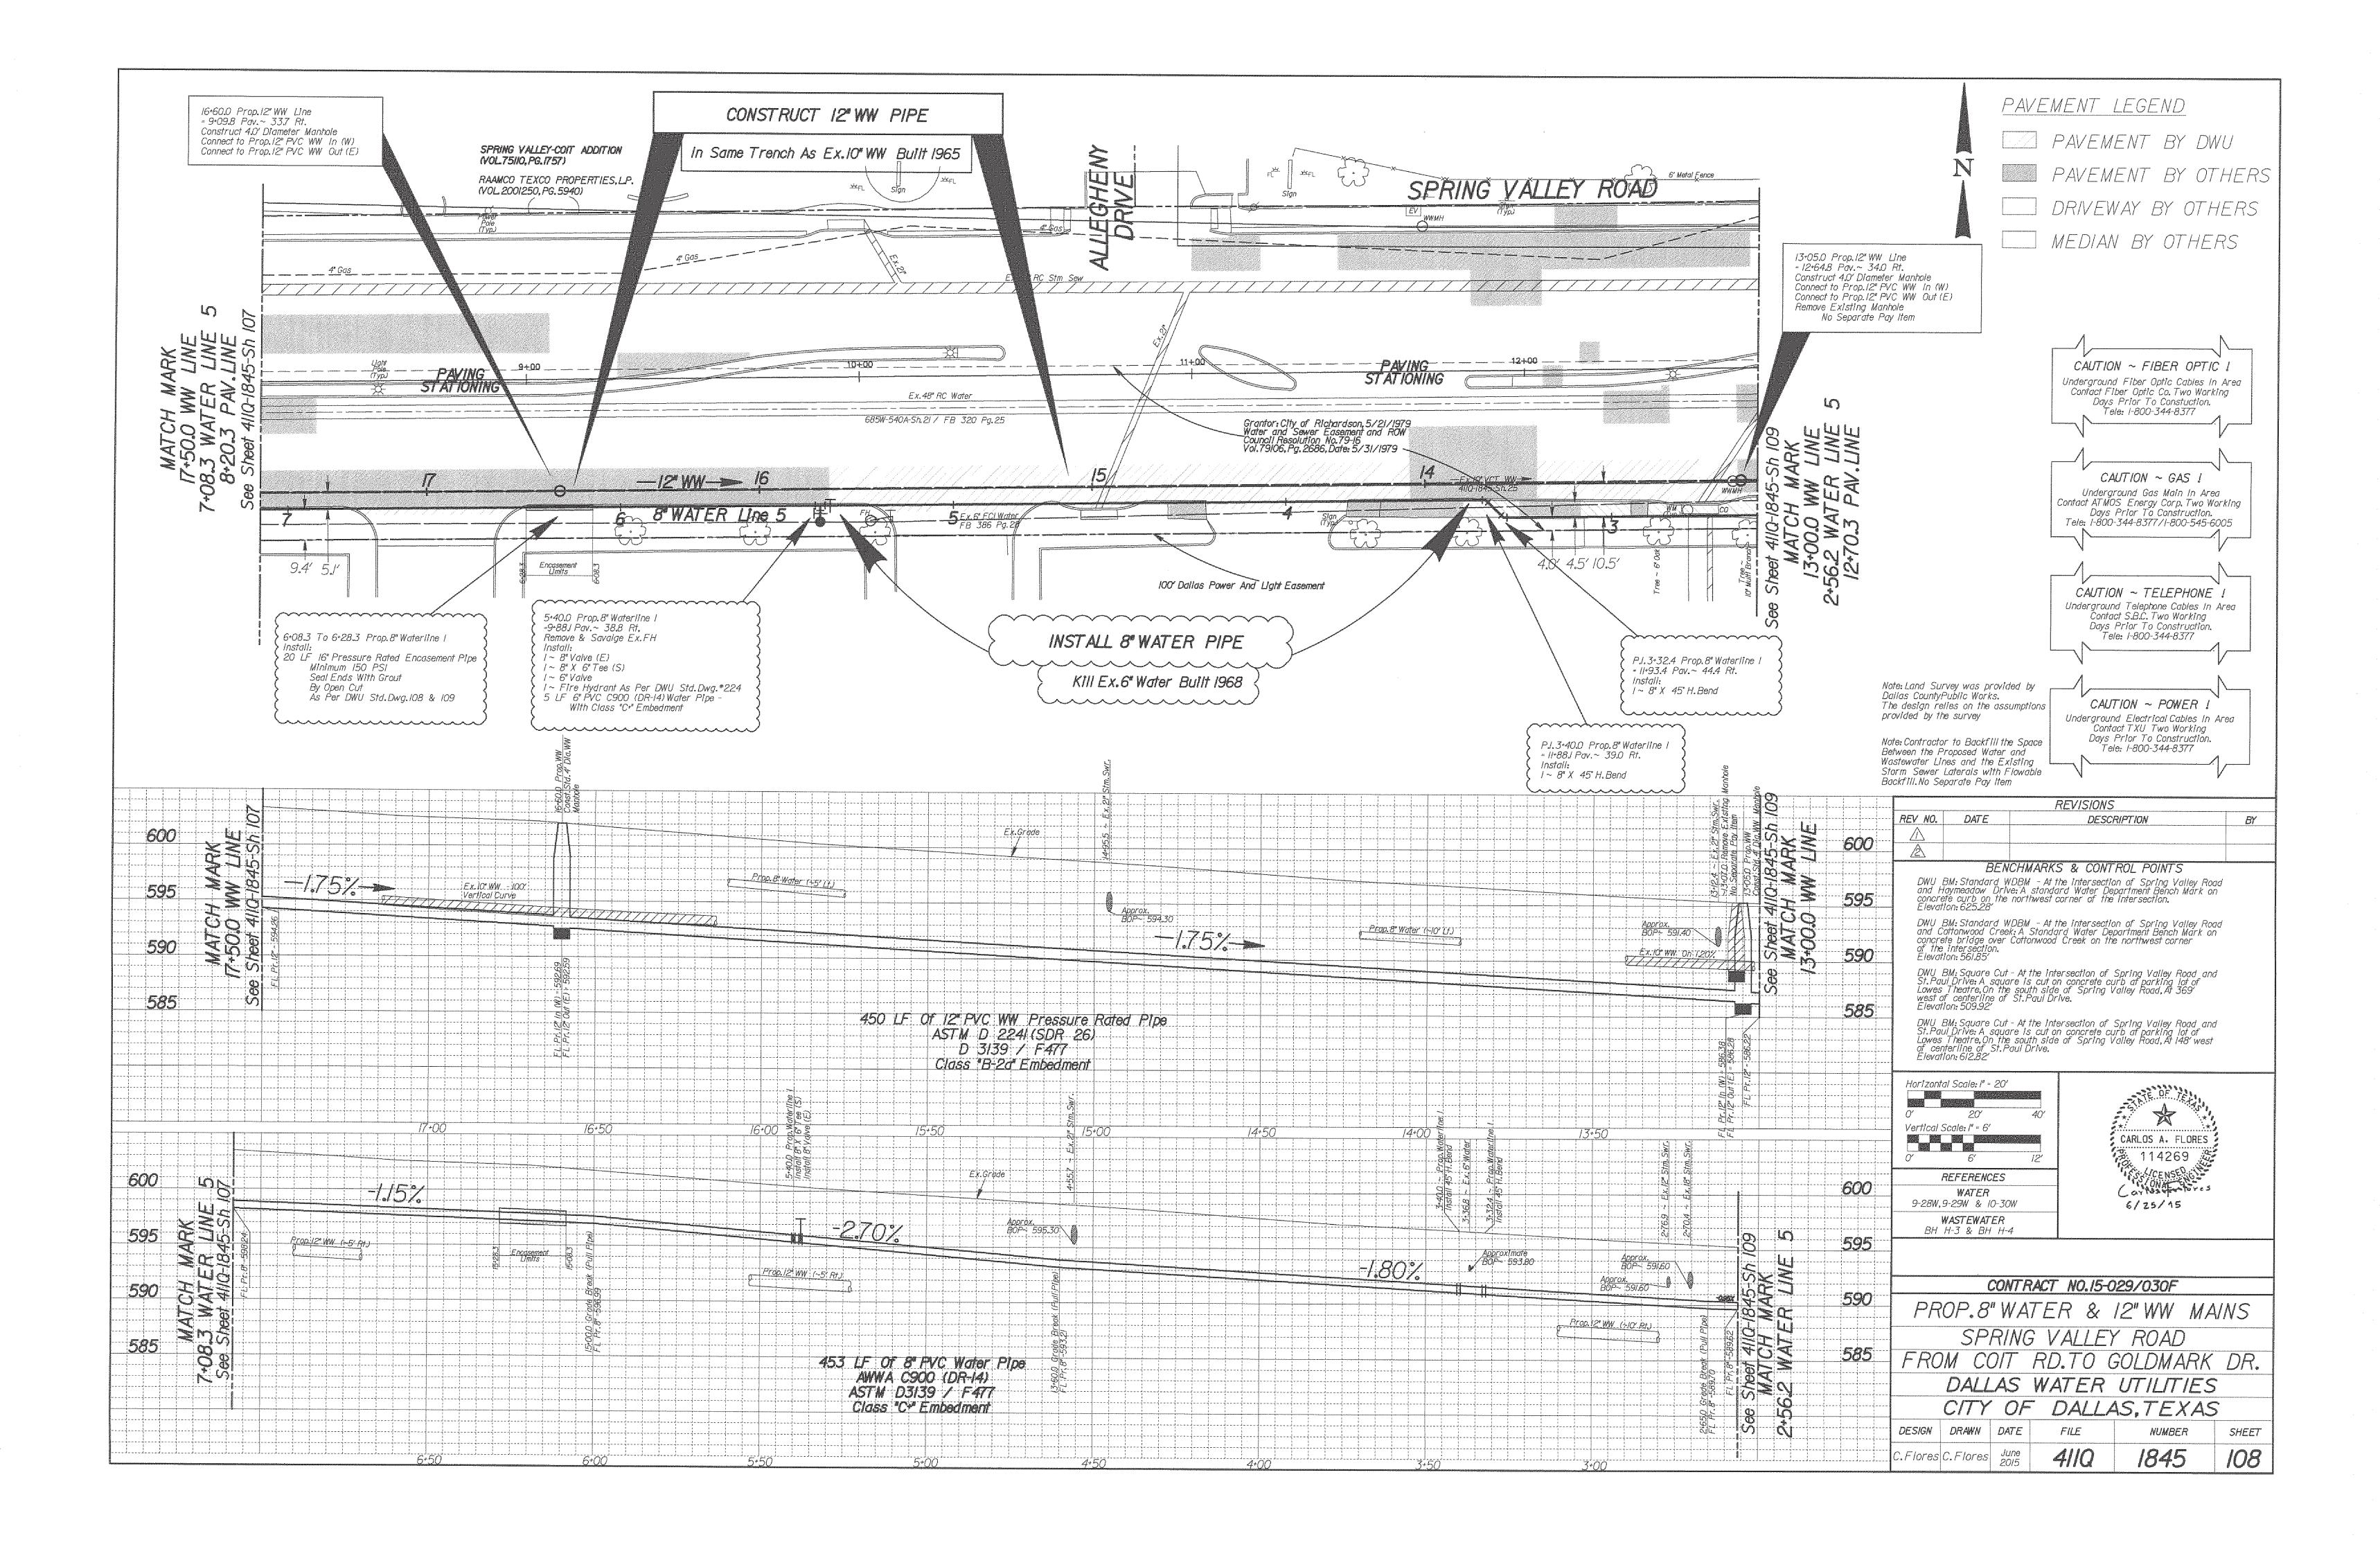
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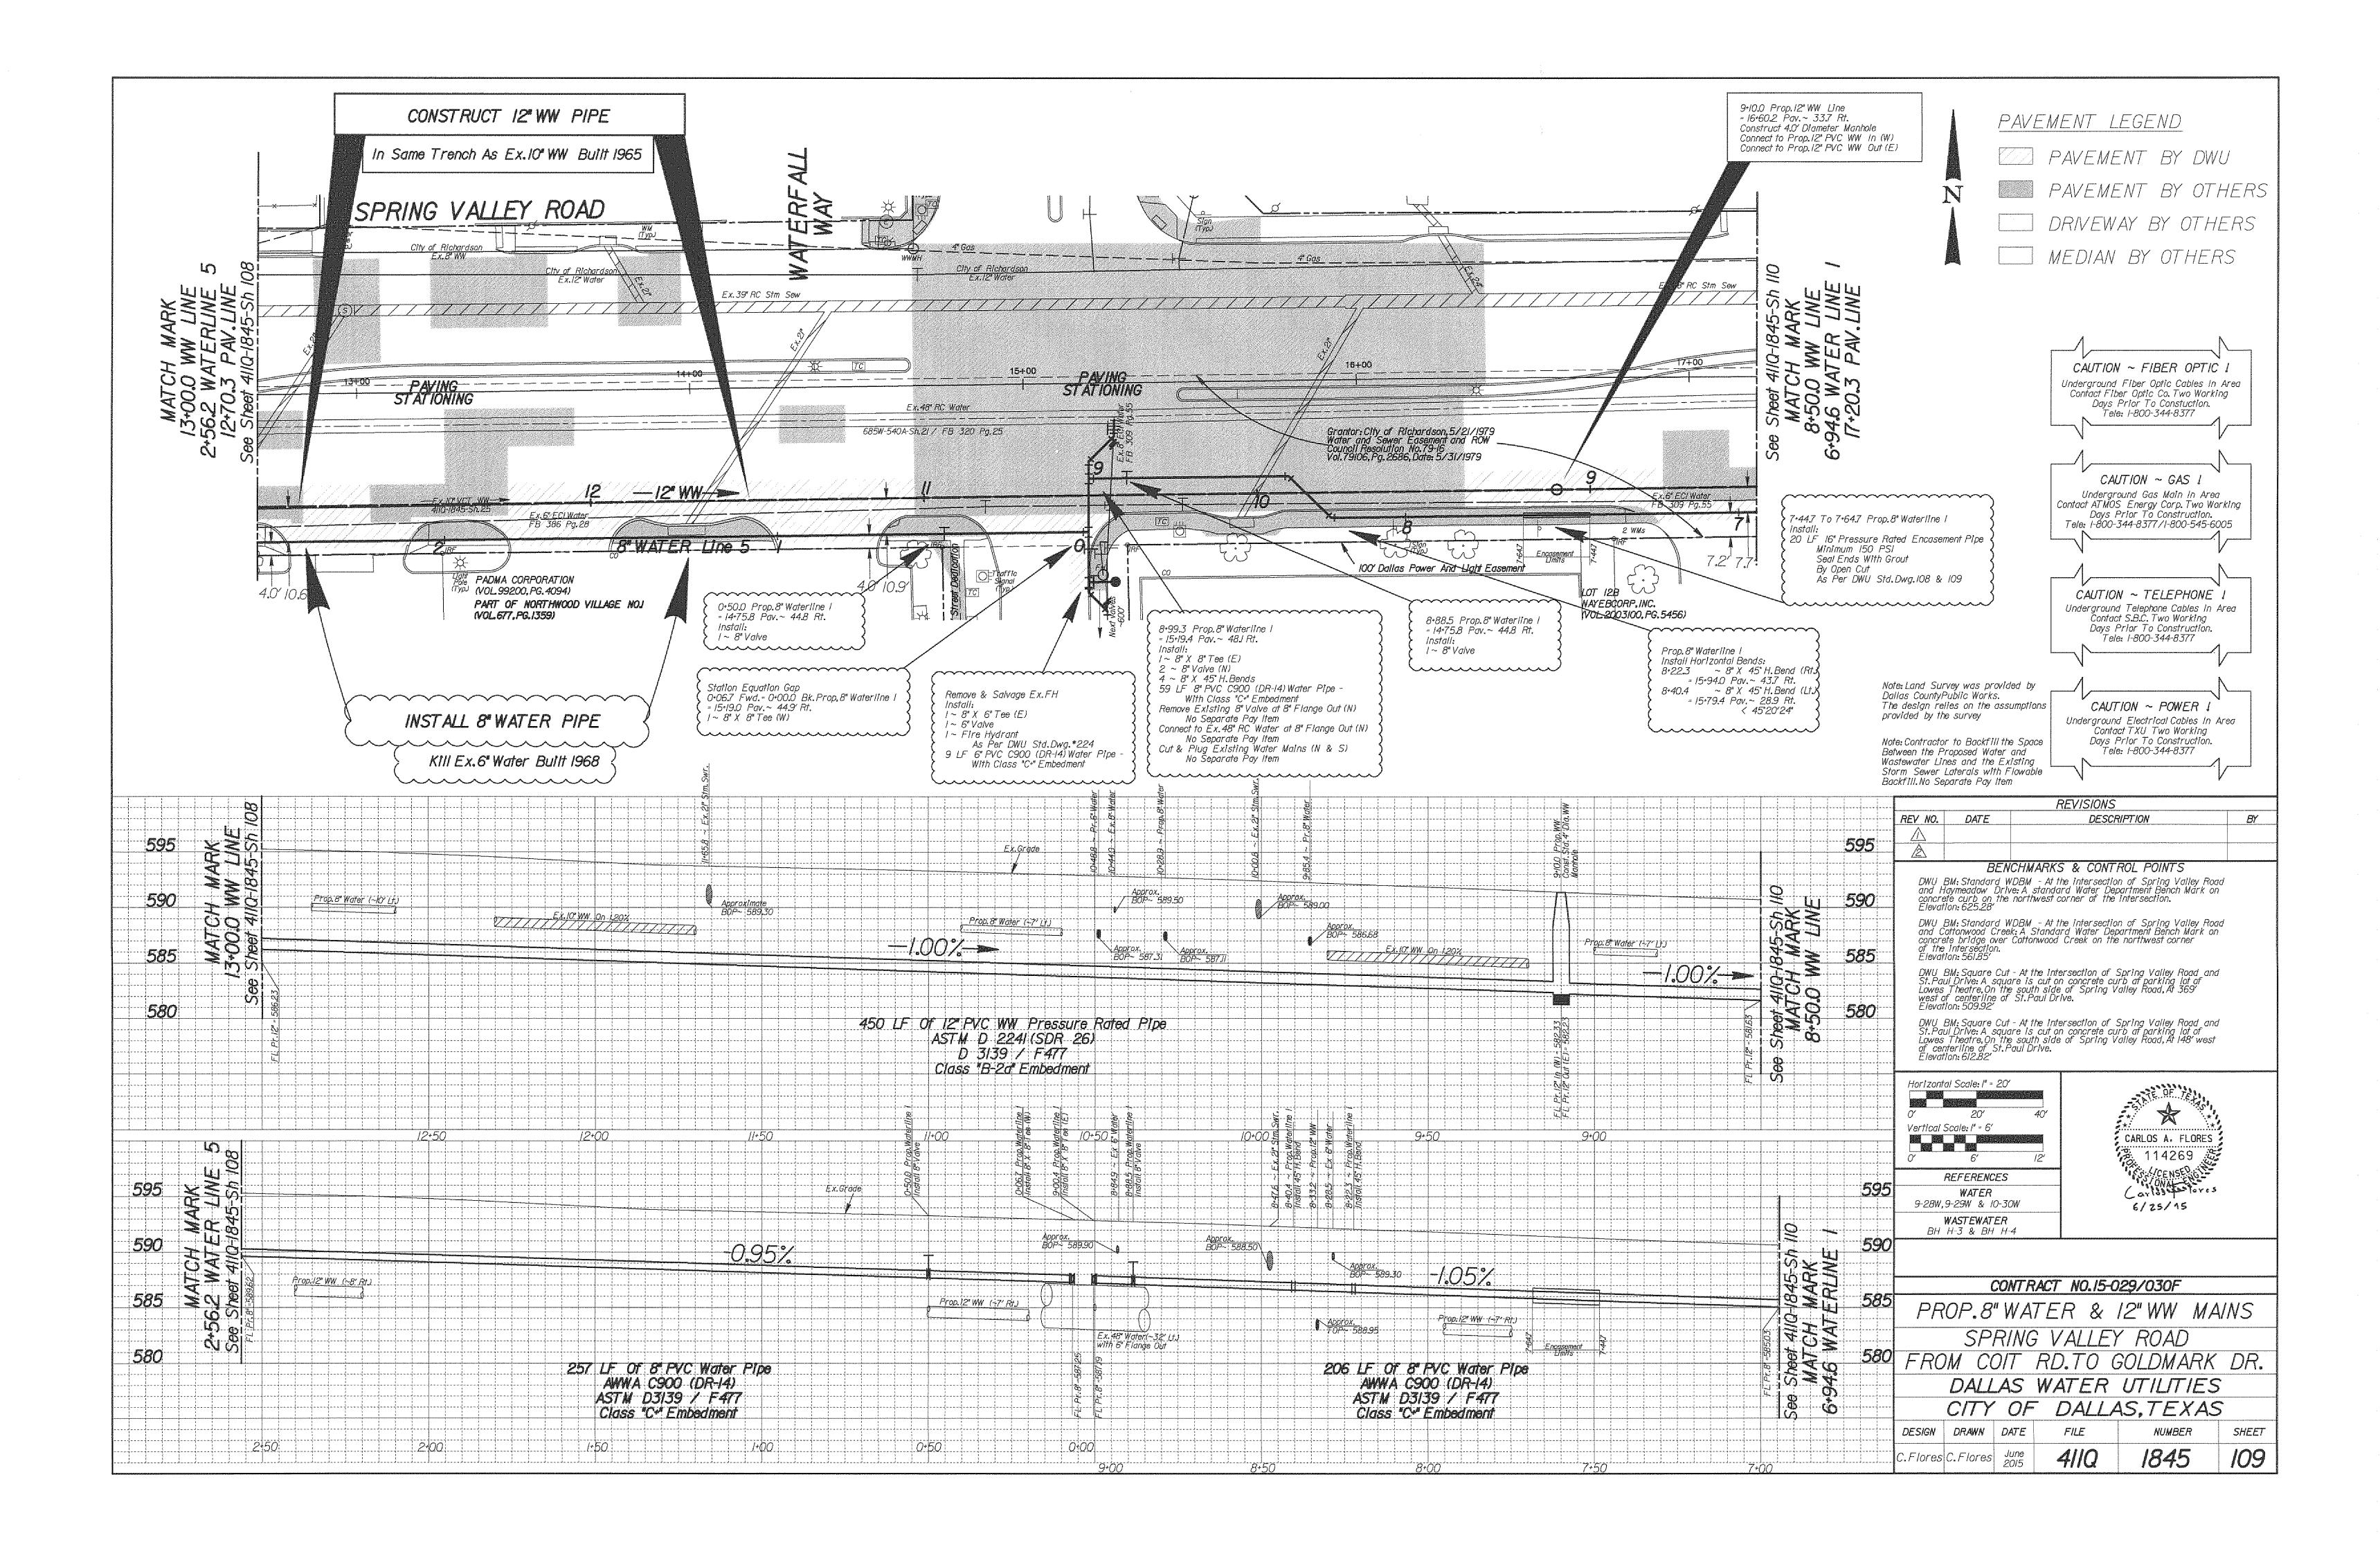
- 13. When a proposed wastewater main crosses a water main, the wastewater main shall be centered between the Joints of the water main. The wastewater main shall be embedded in cement stabilized sand for the total of one lenght of one pipe segment plus 12 inches beyond the joint on each end.
- 14. Contractor to relocate the blow off pipe from the 48-inch RC Water Main at Hunt Branch and/or any of its air valves along its alignment in case they conflict with proposed improvments. No Separate Pay Item.

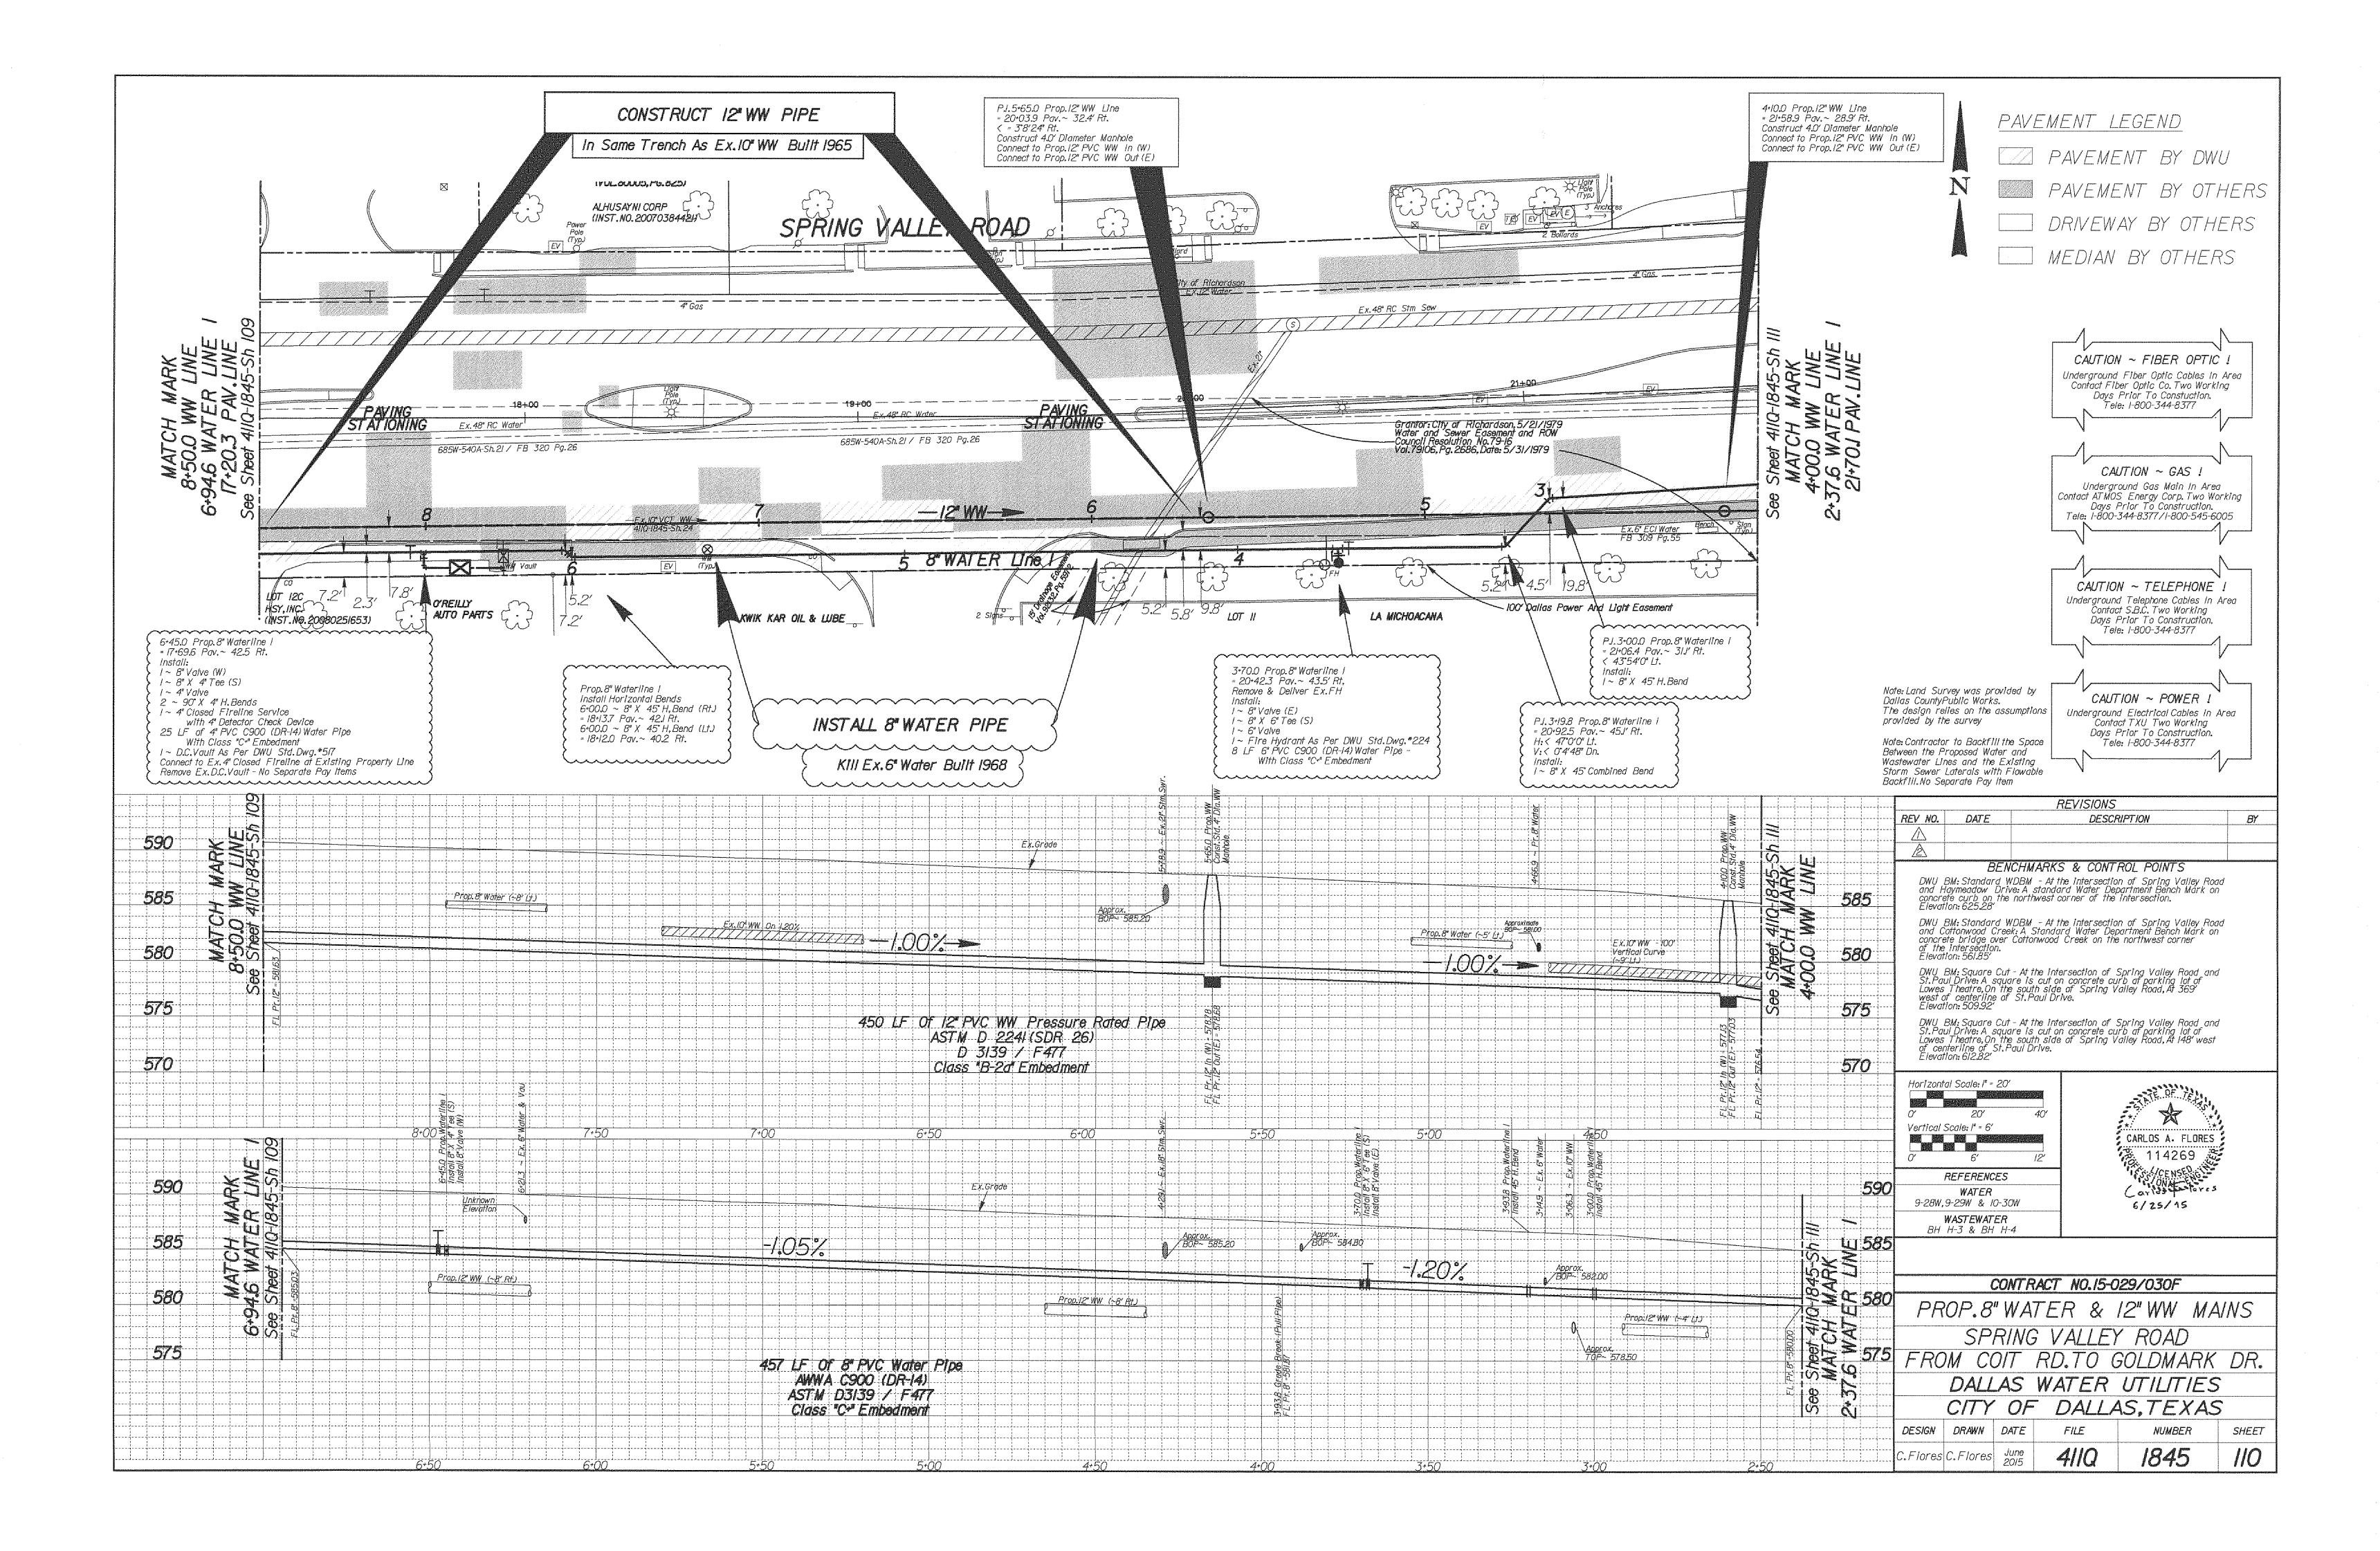
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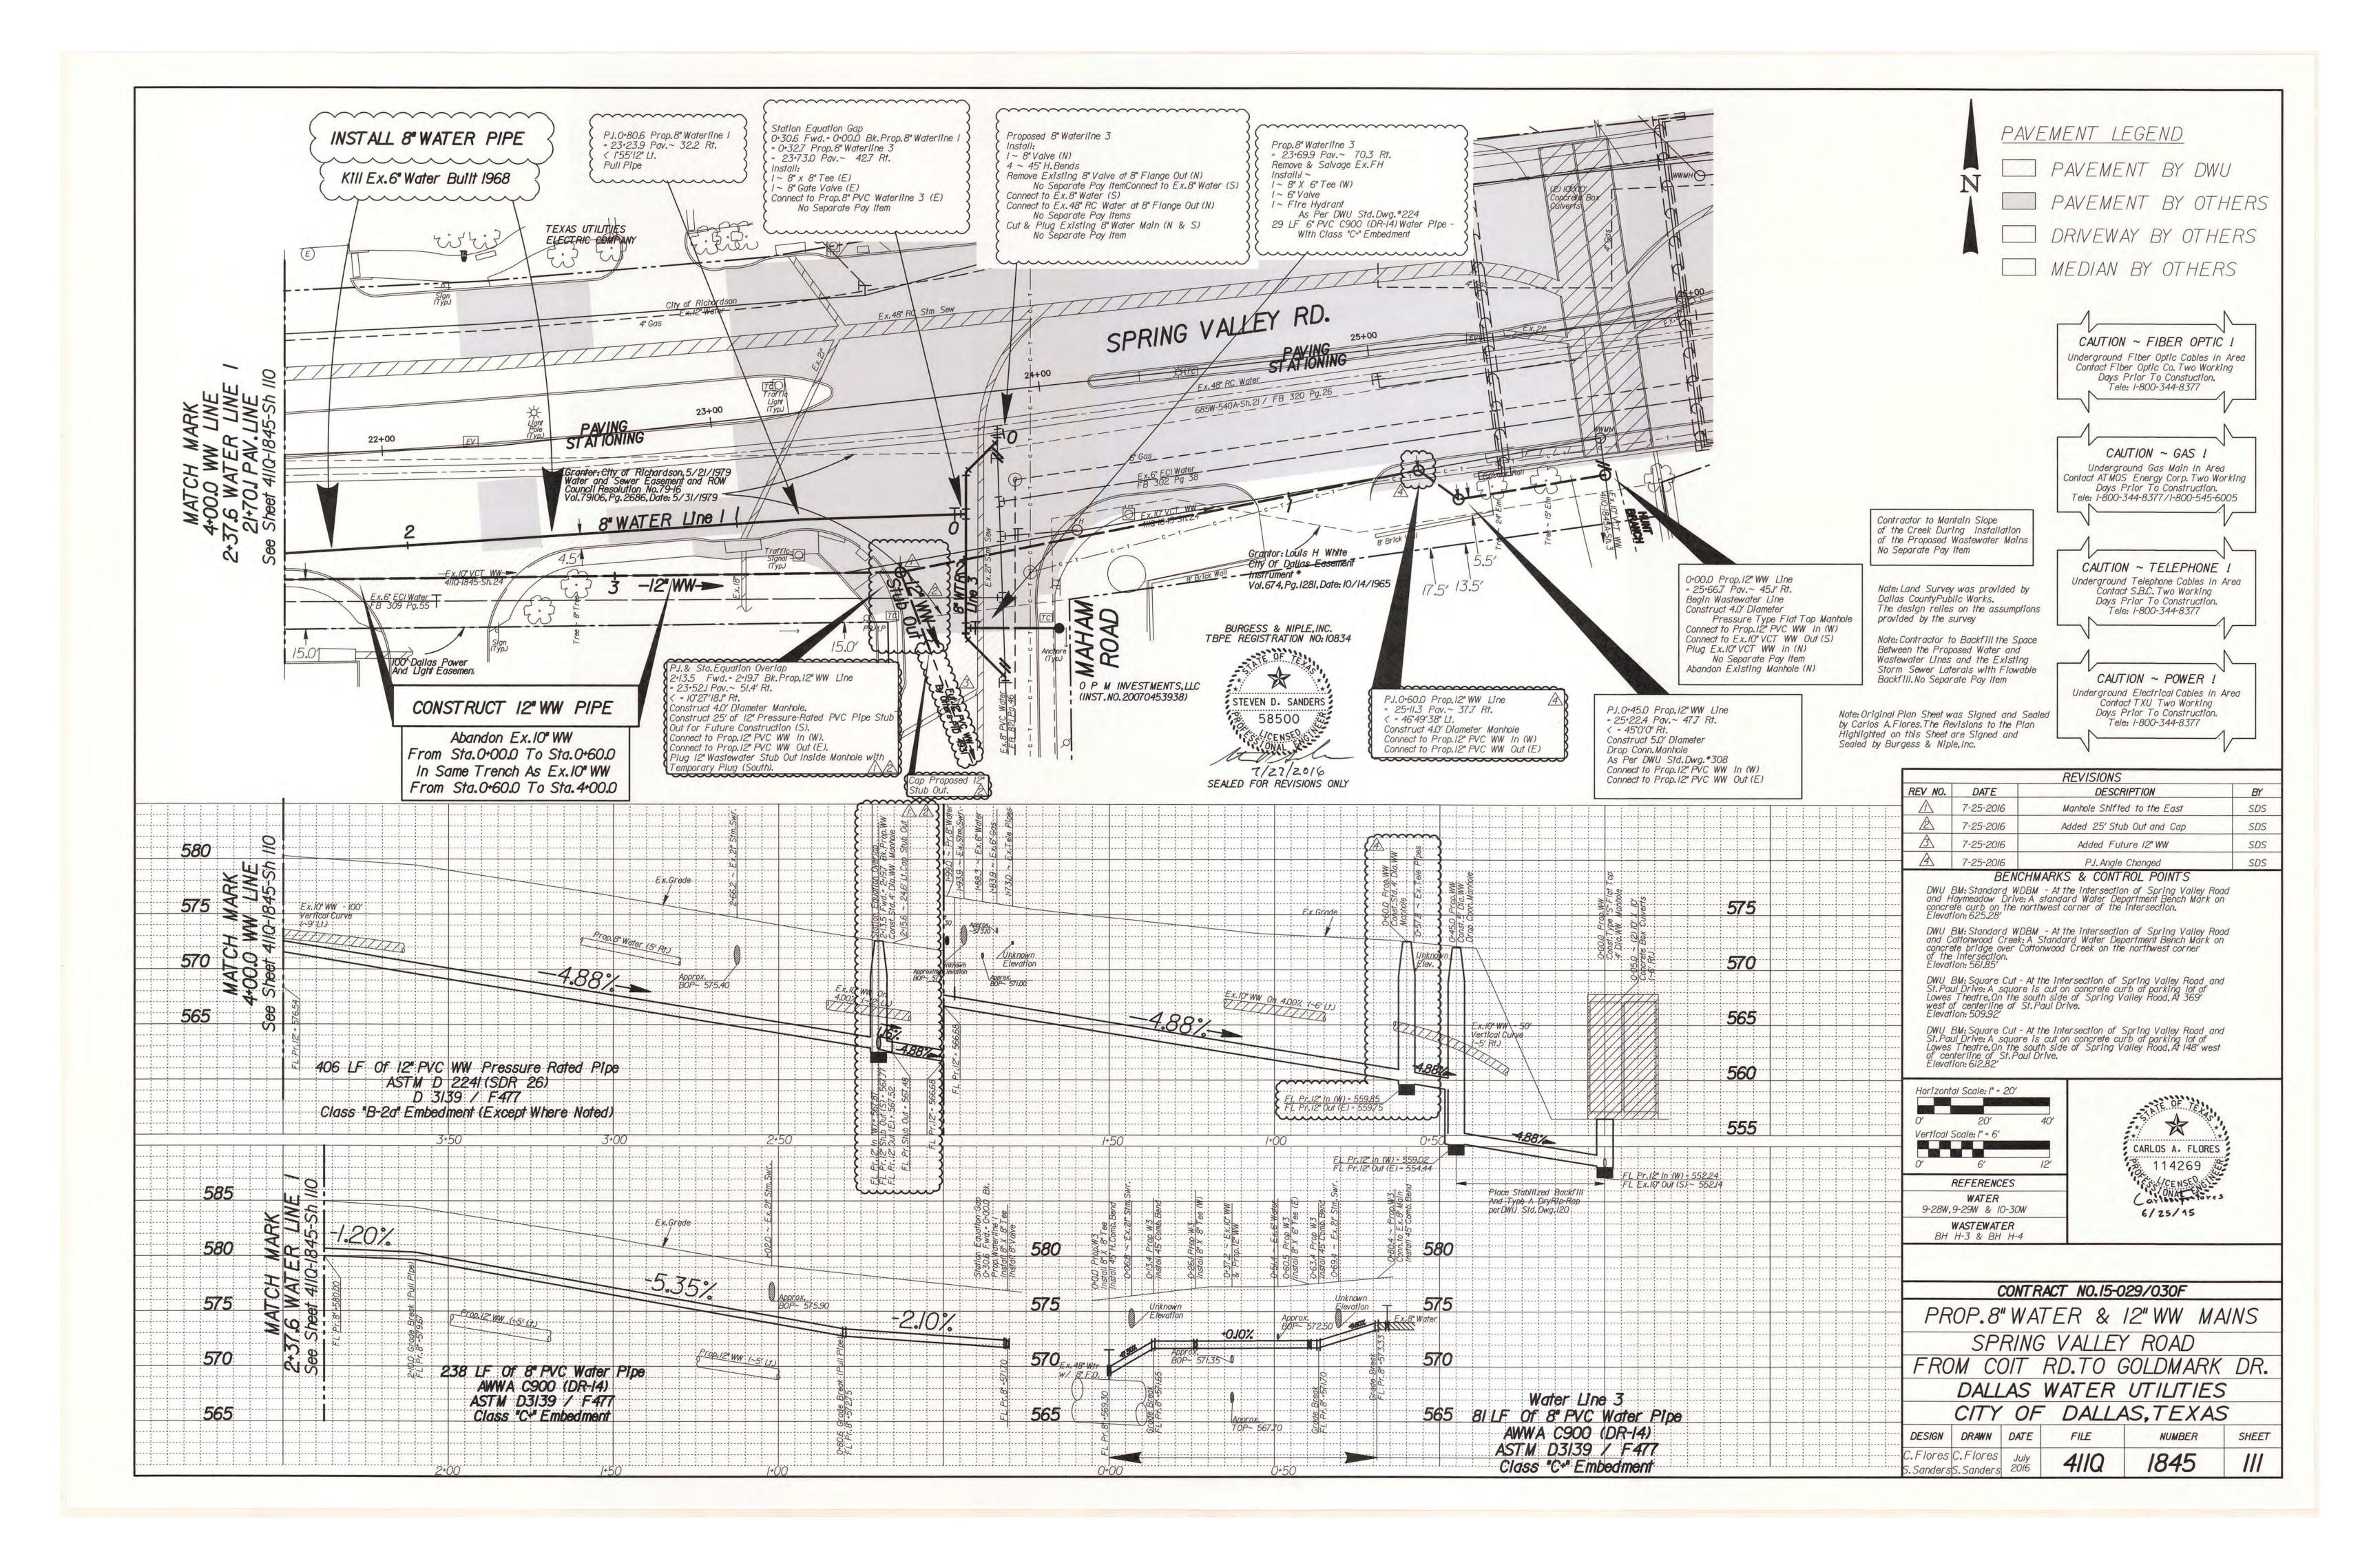


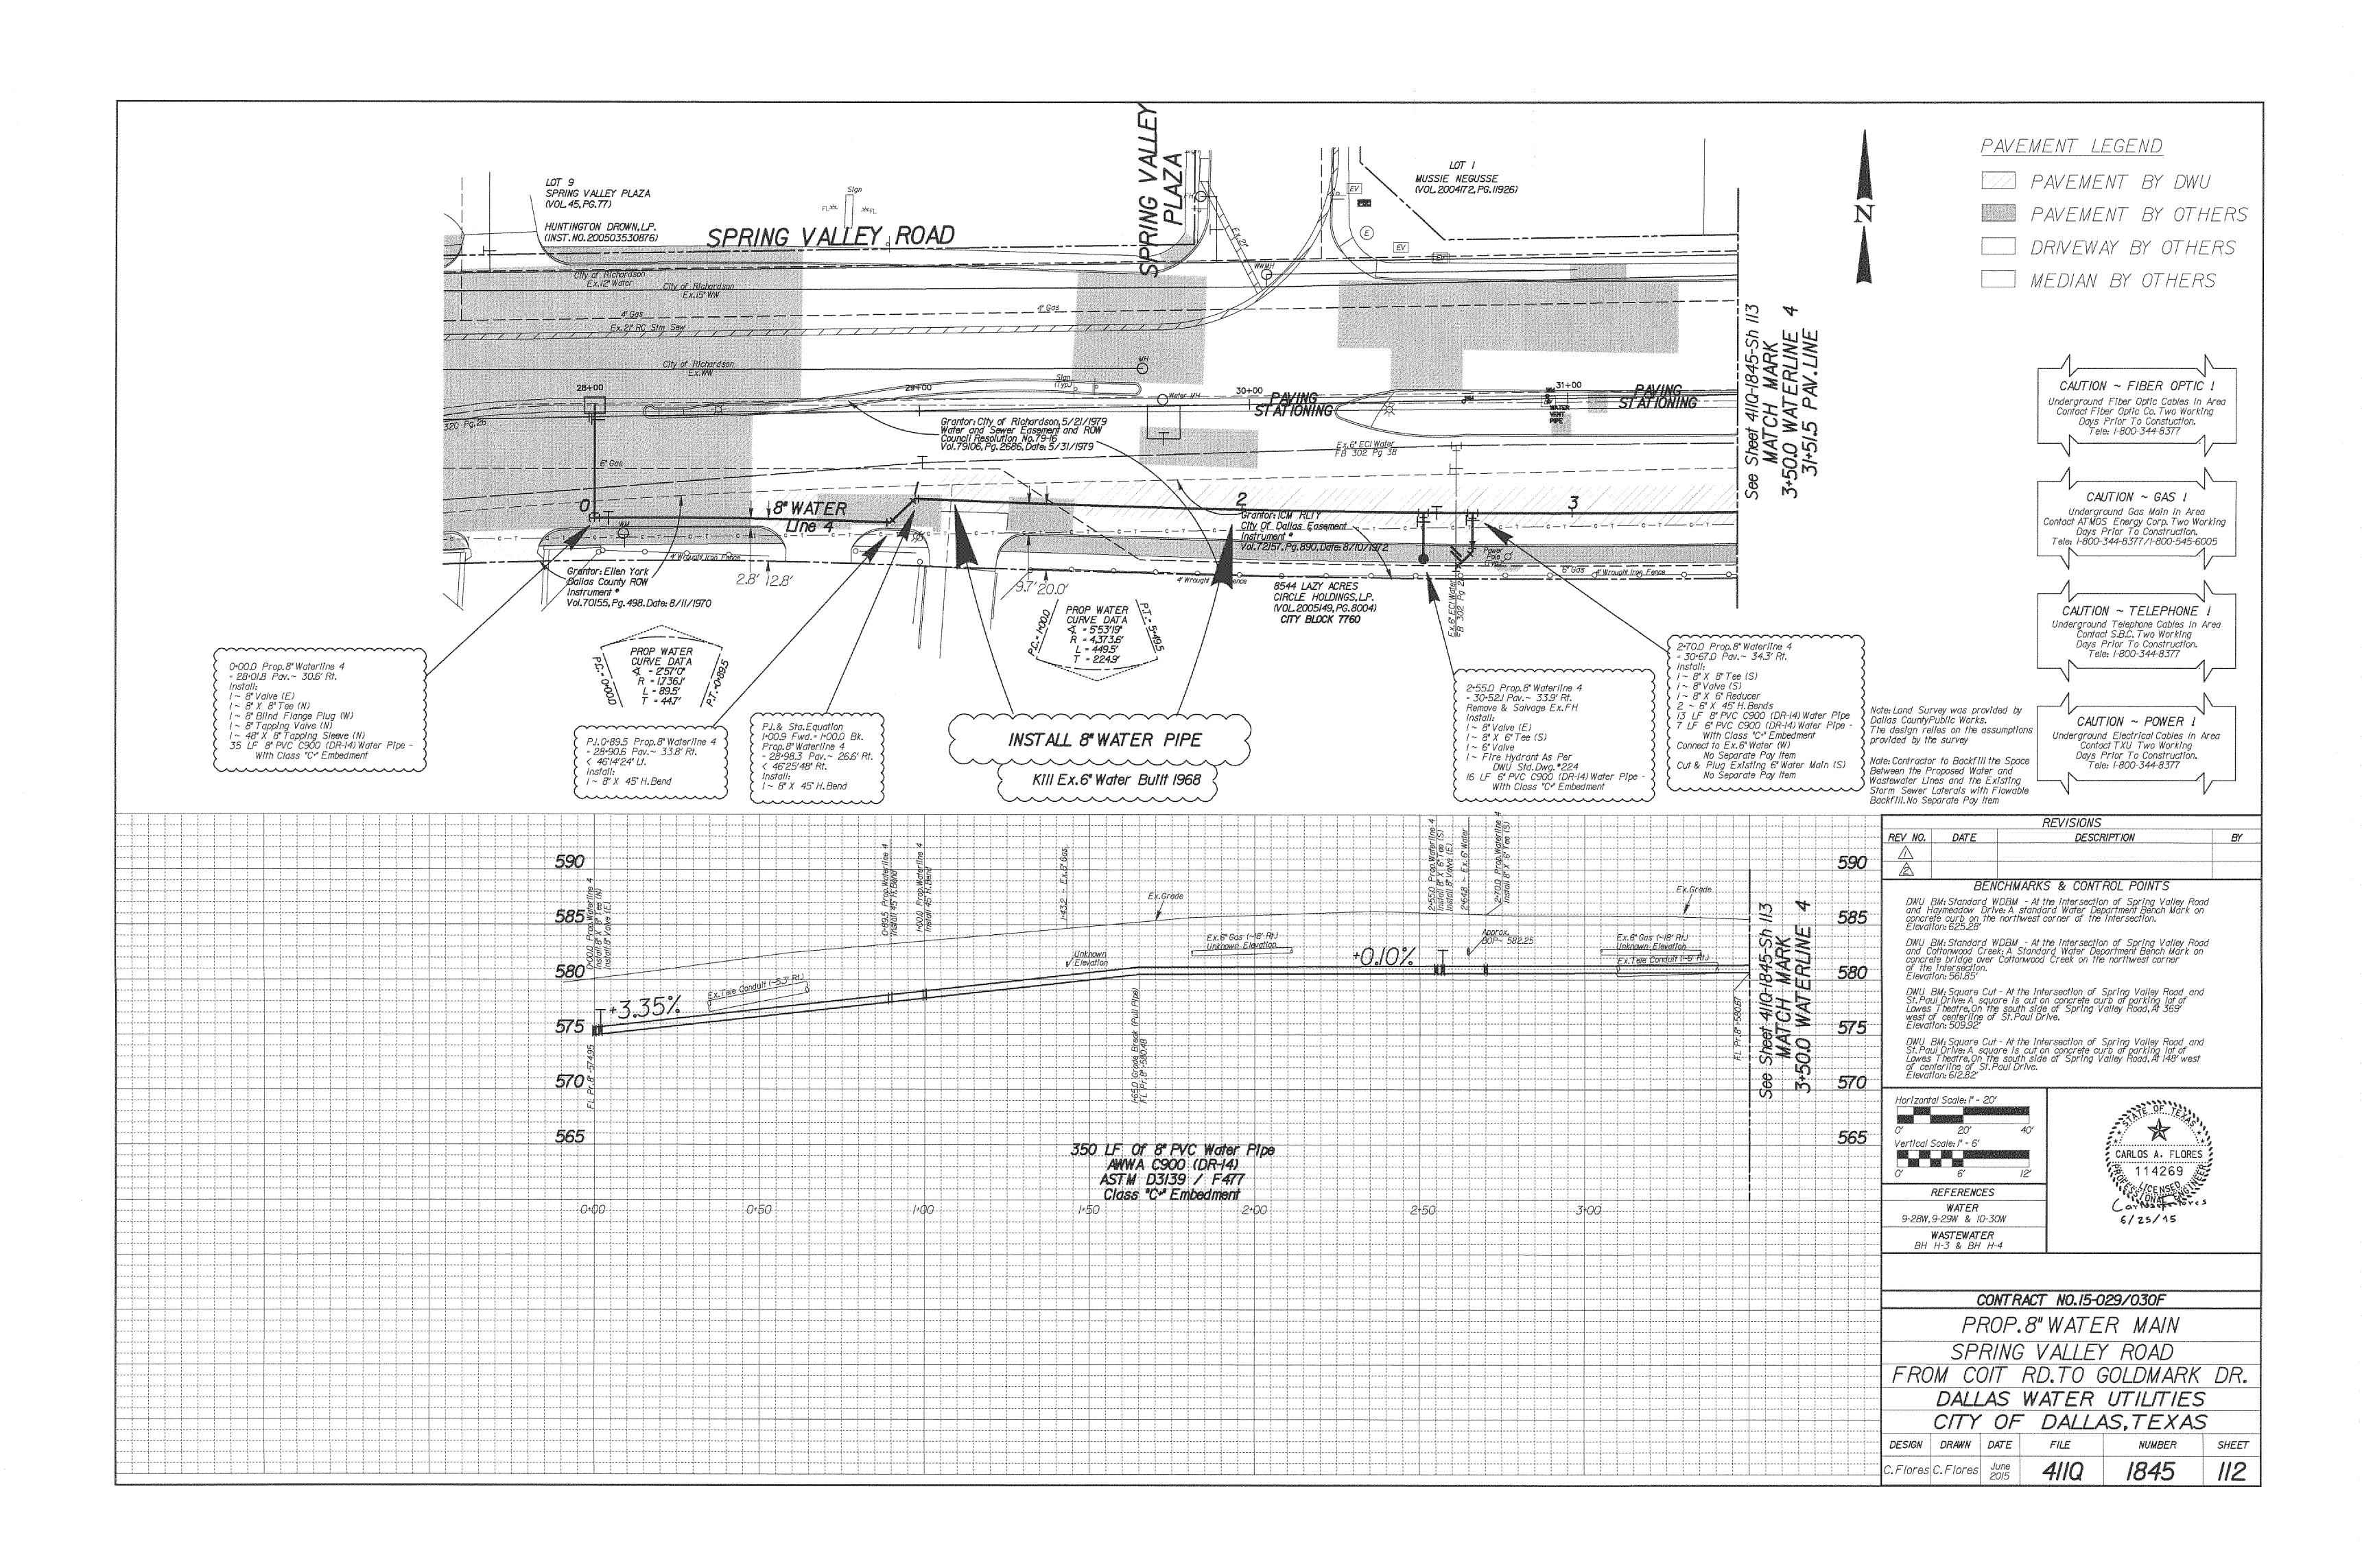


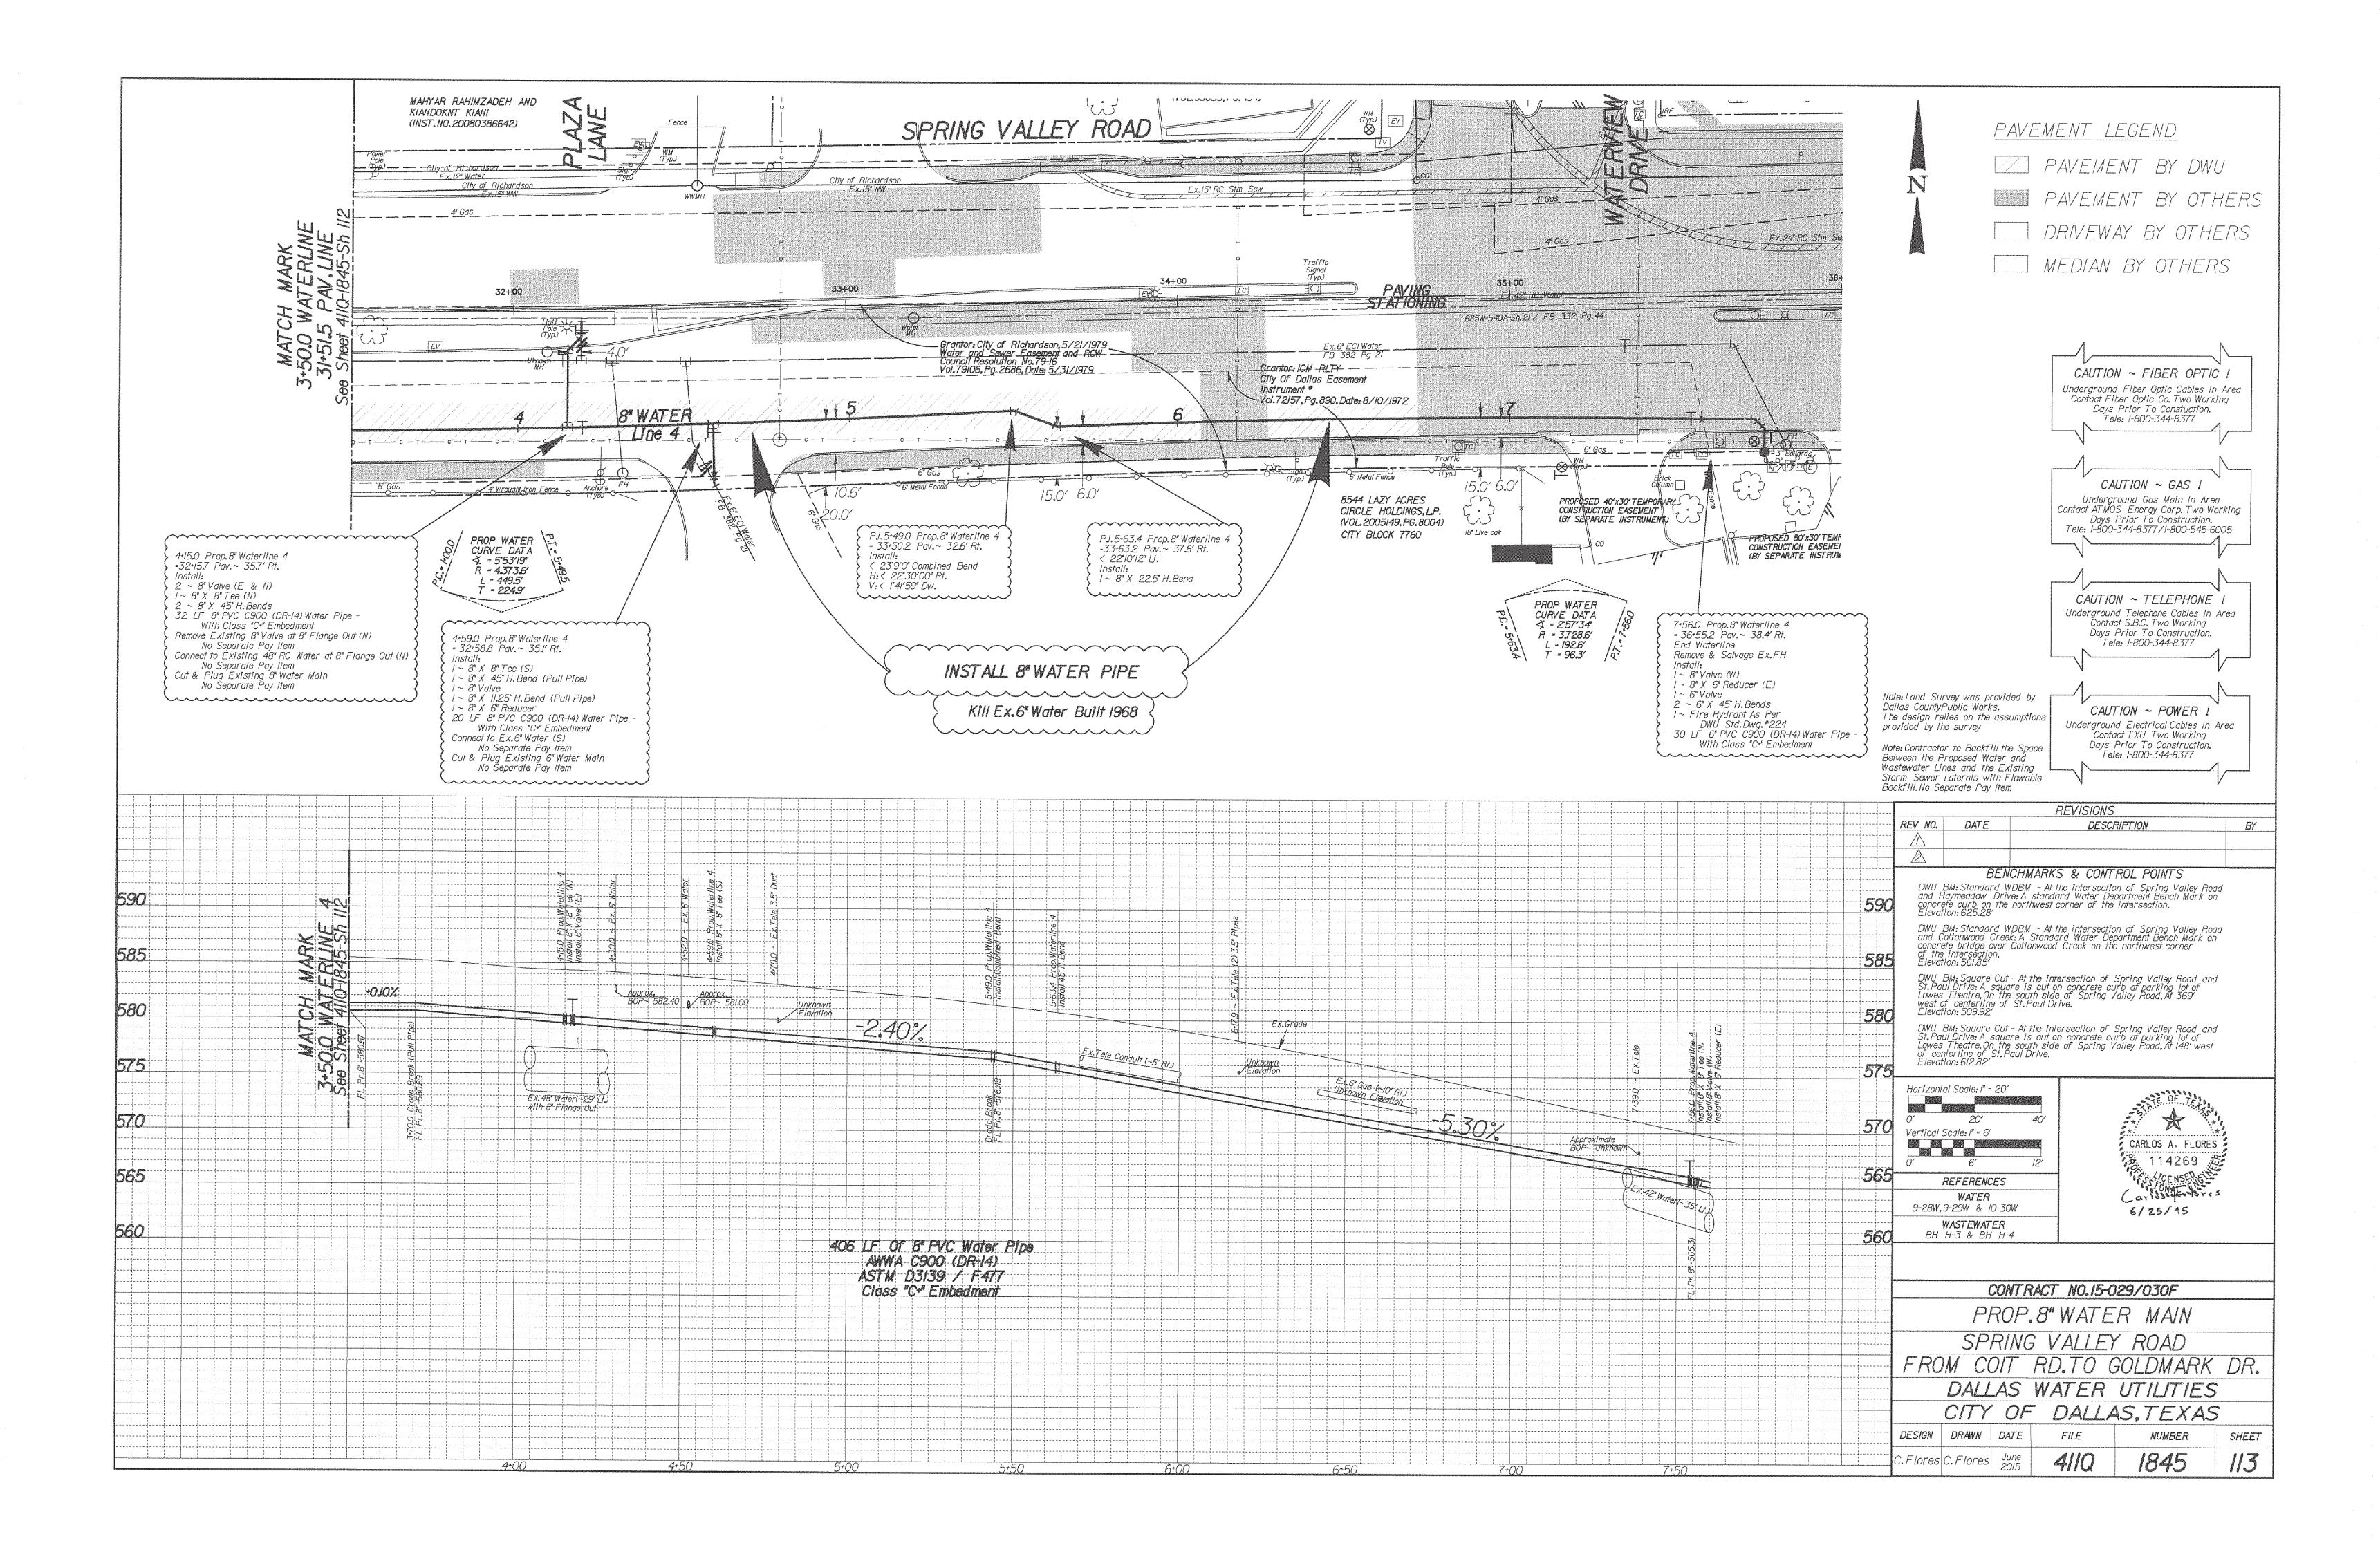


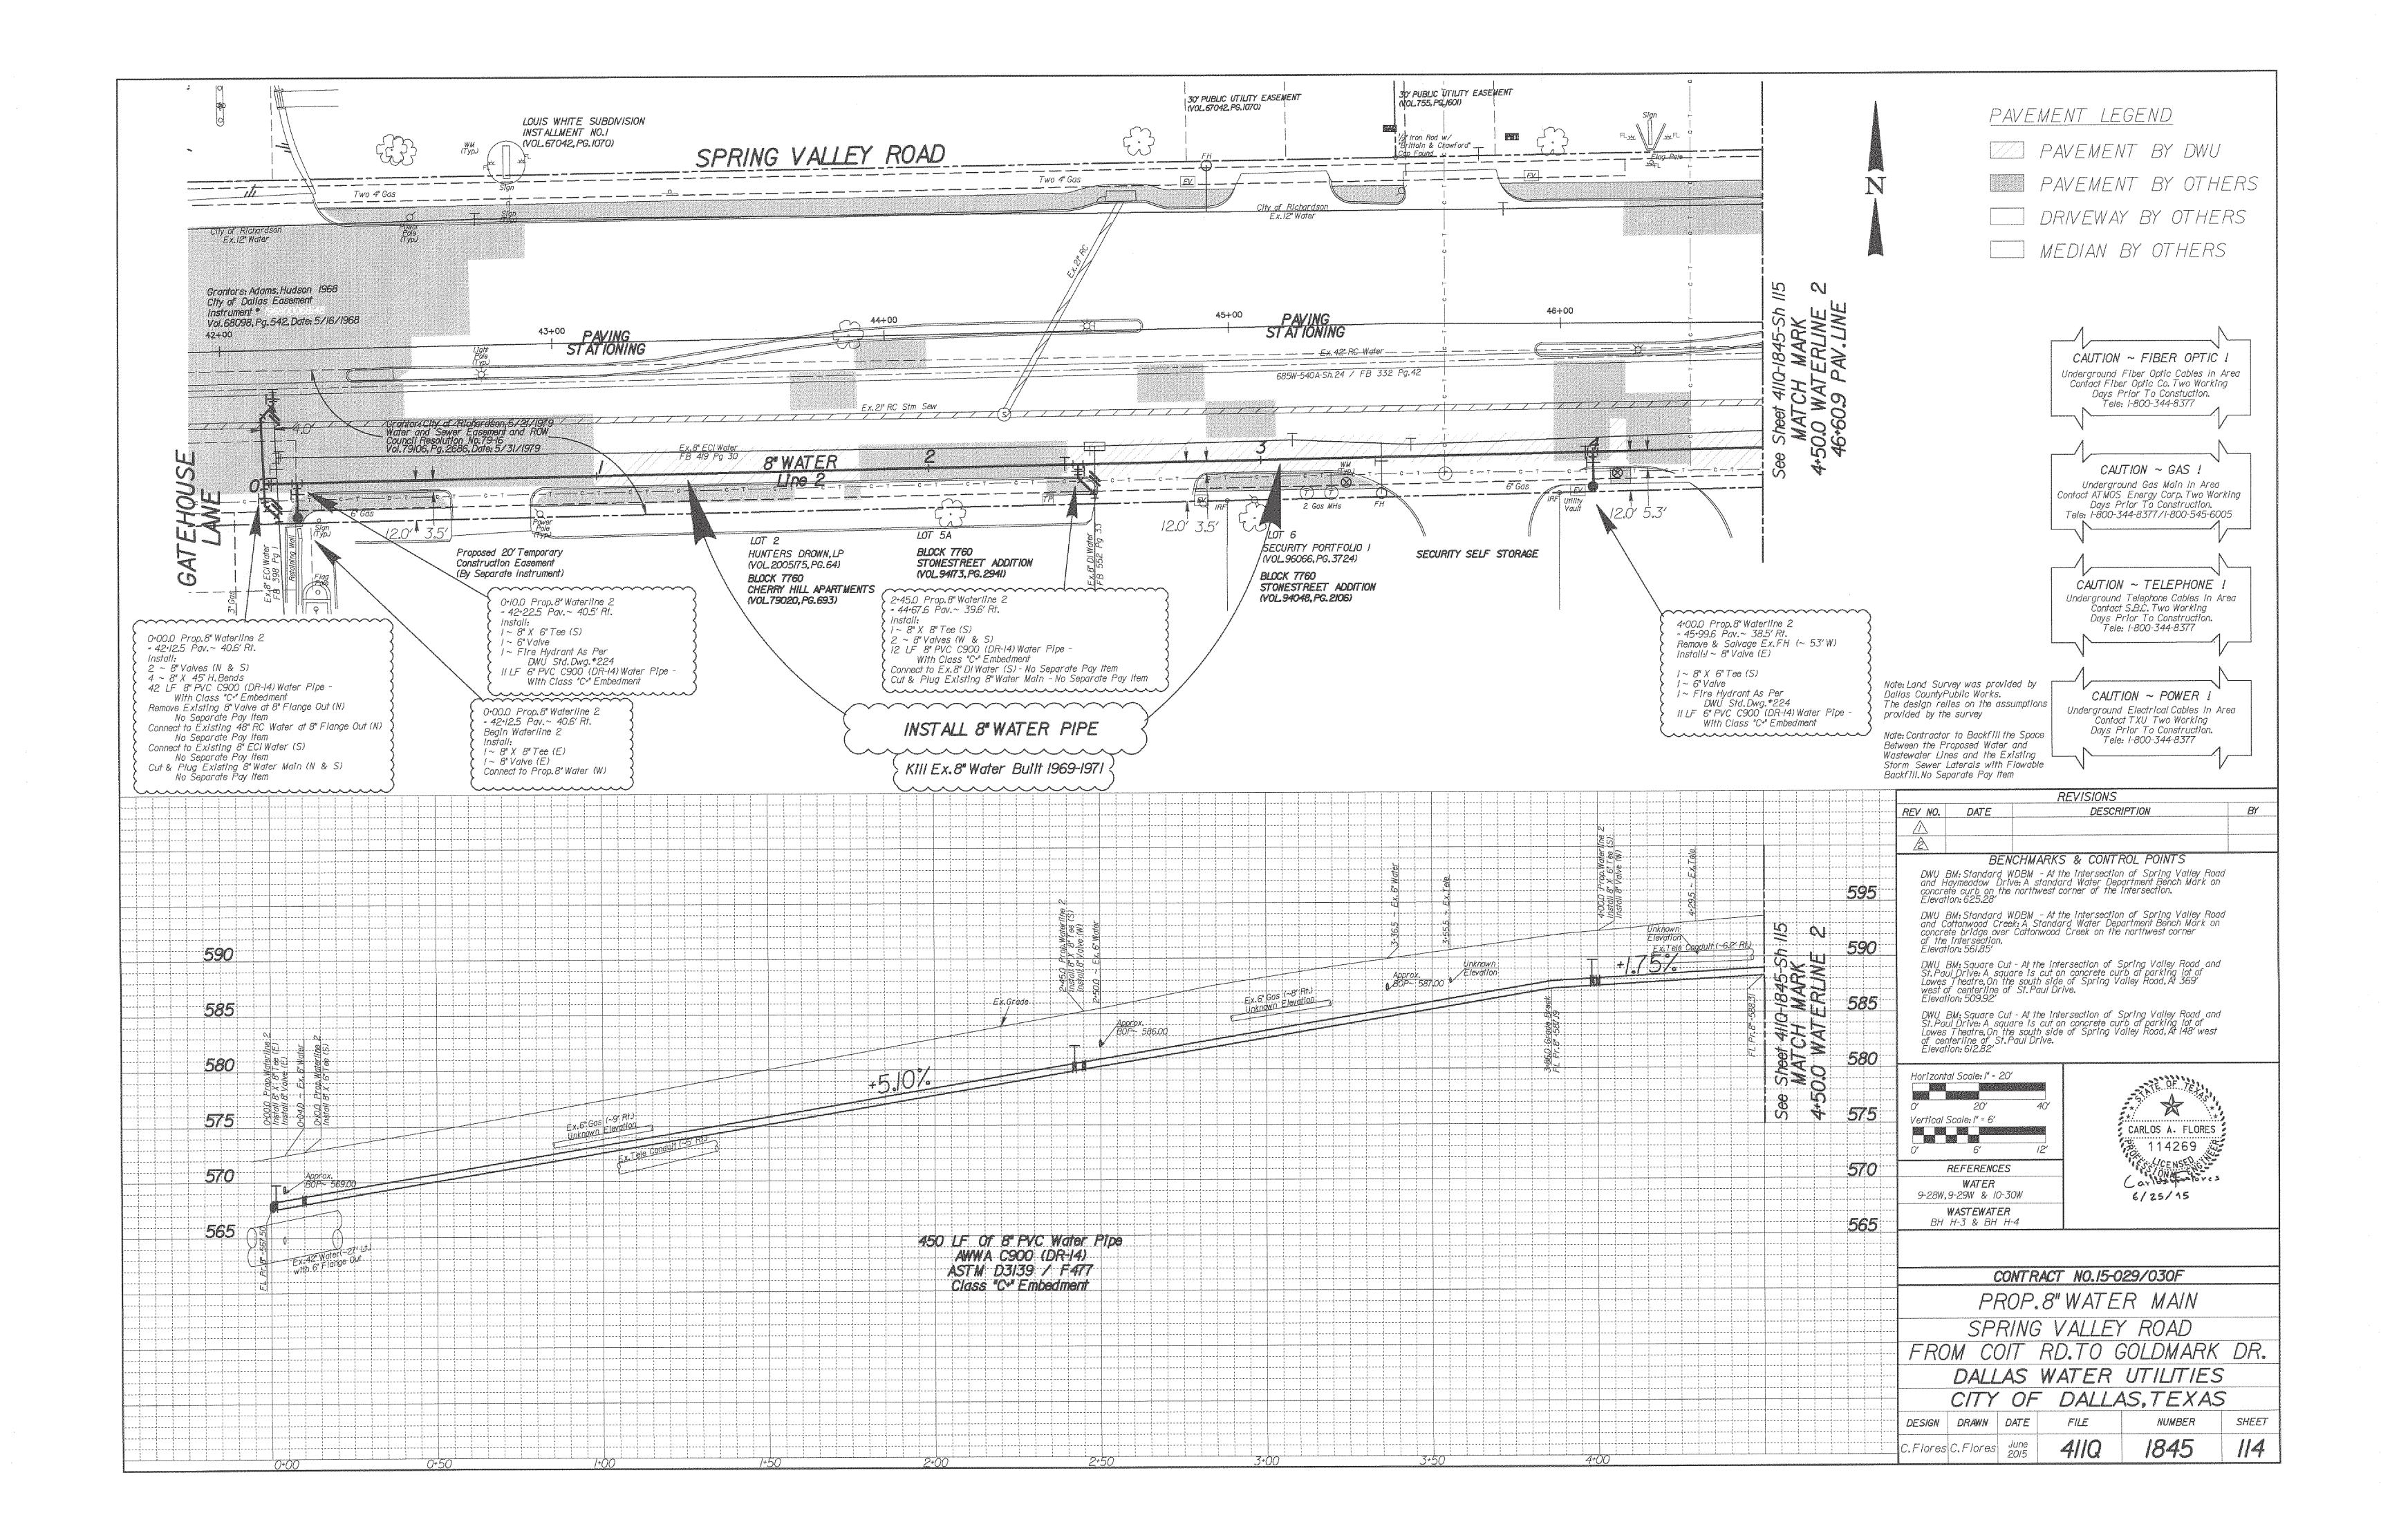


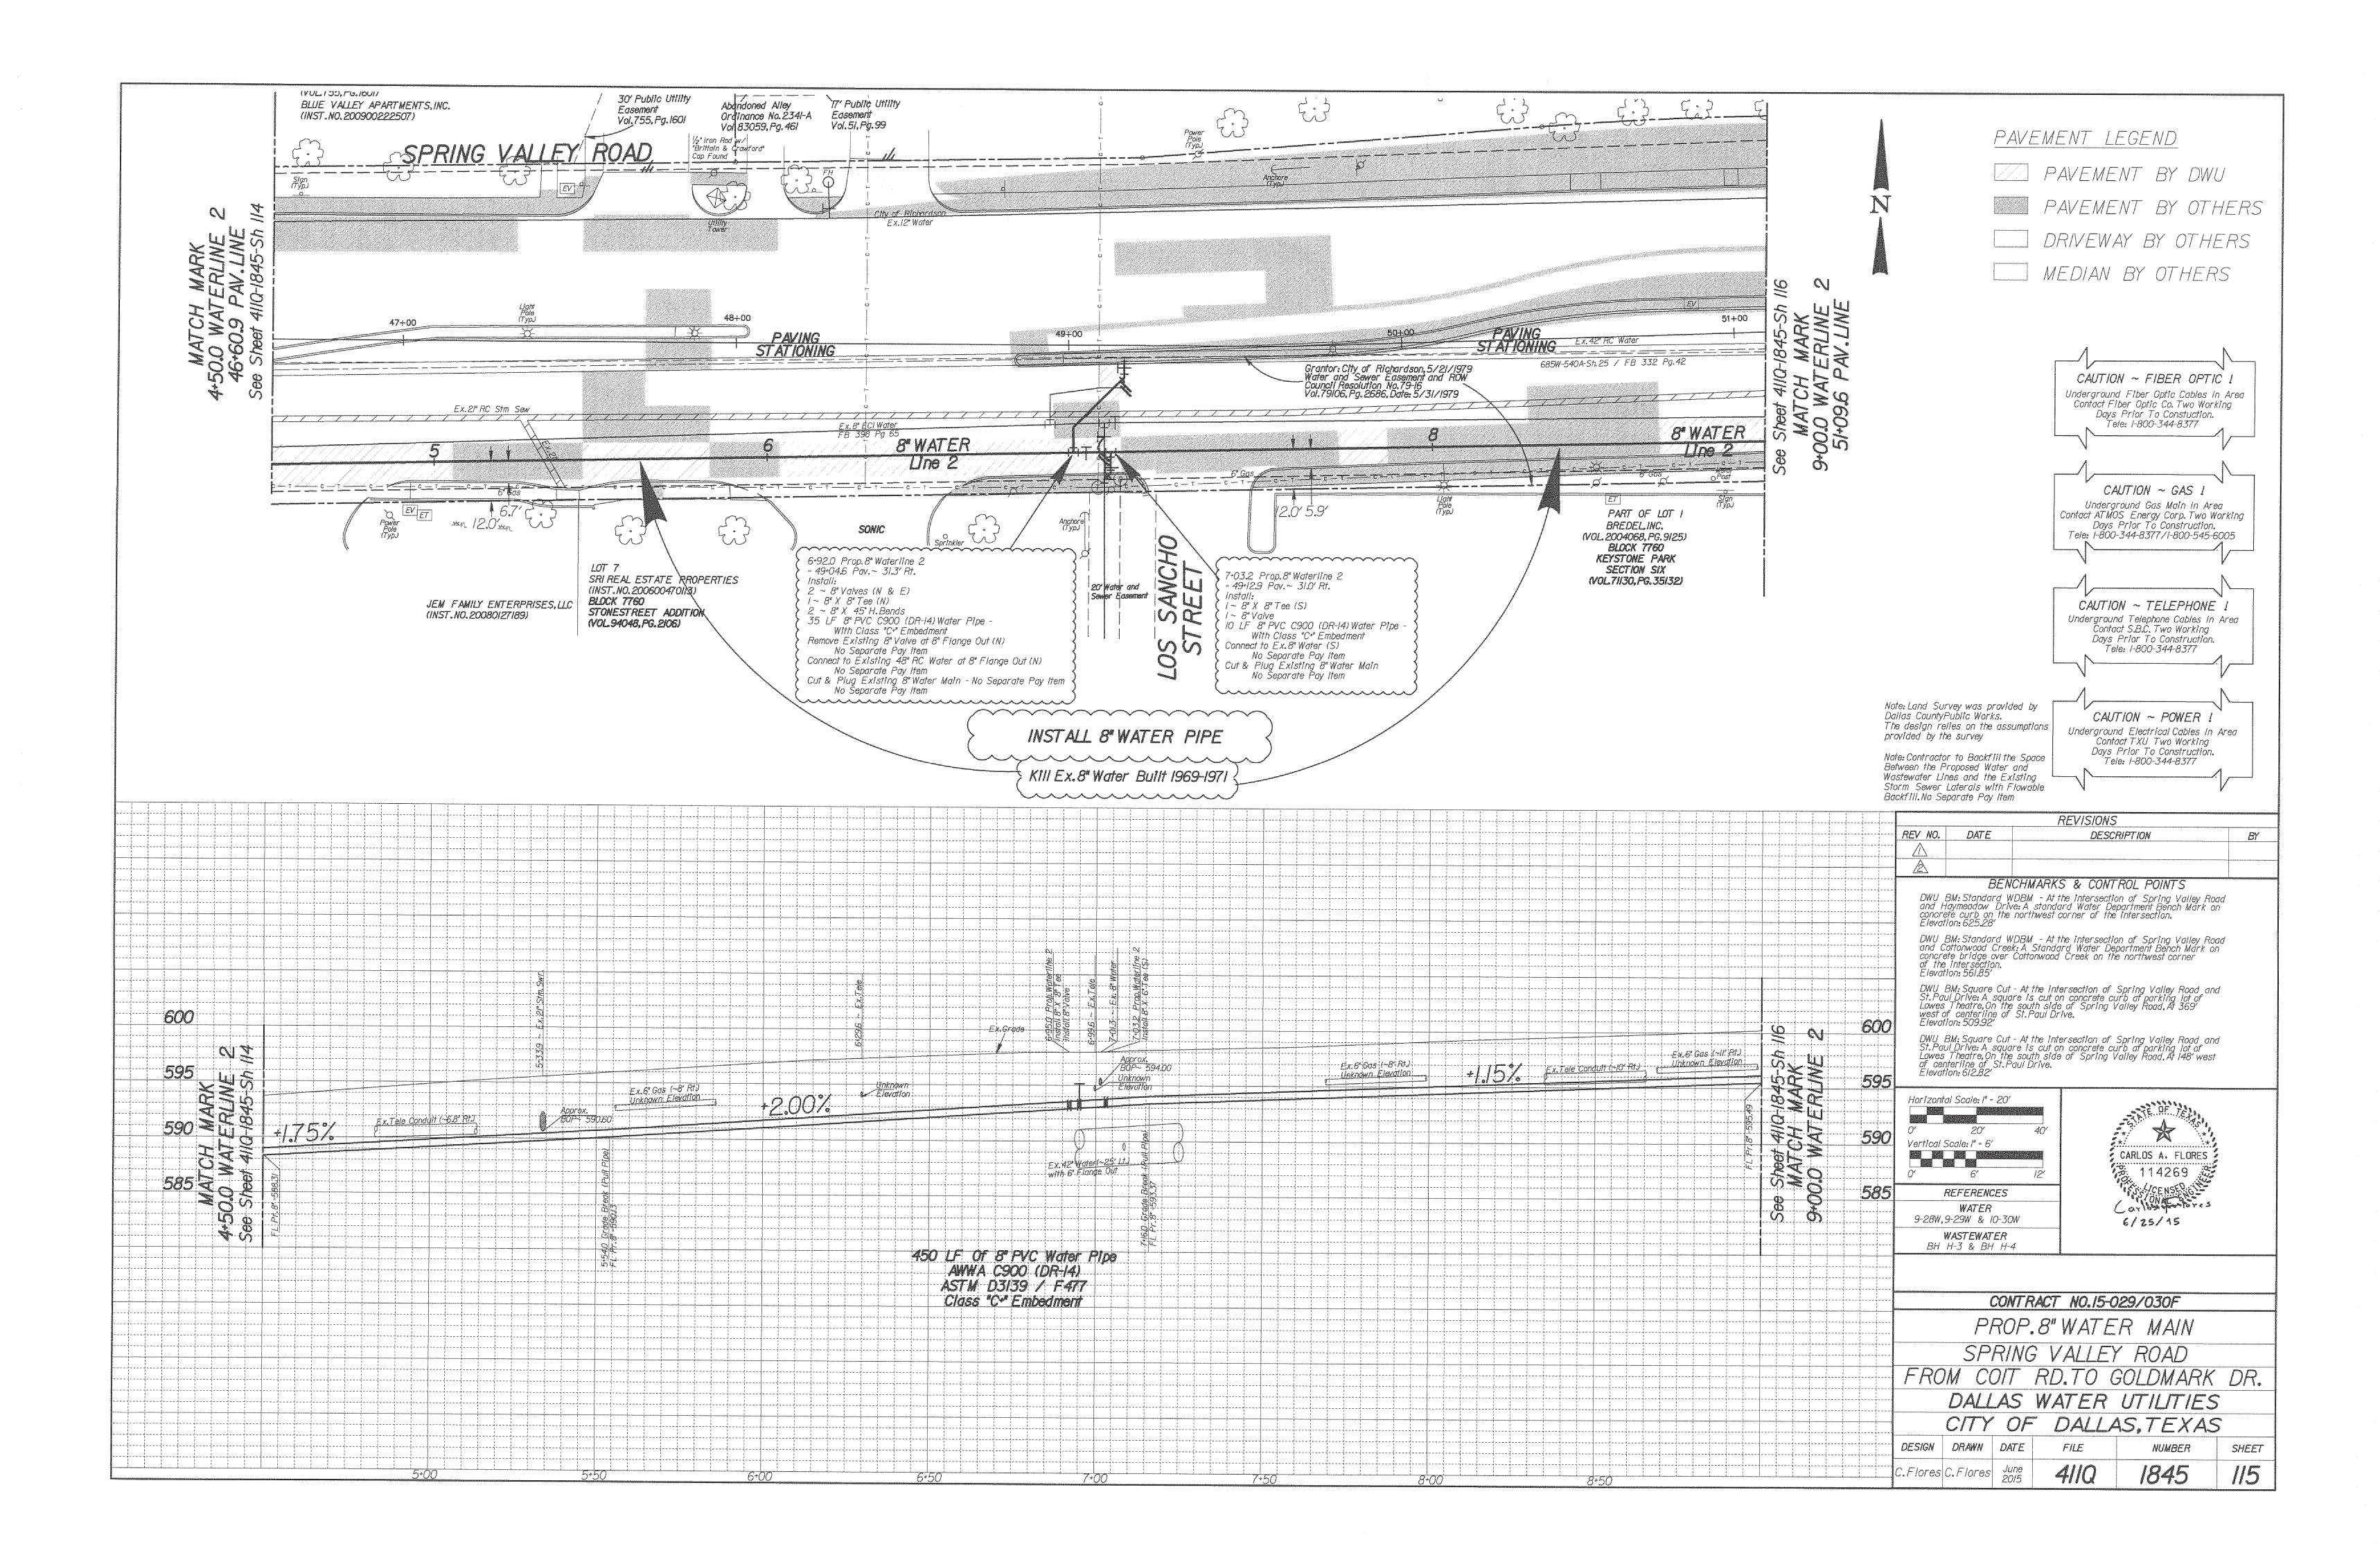


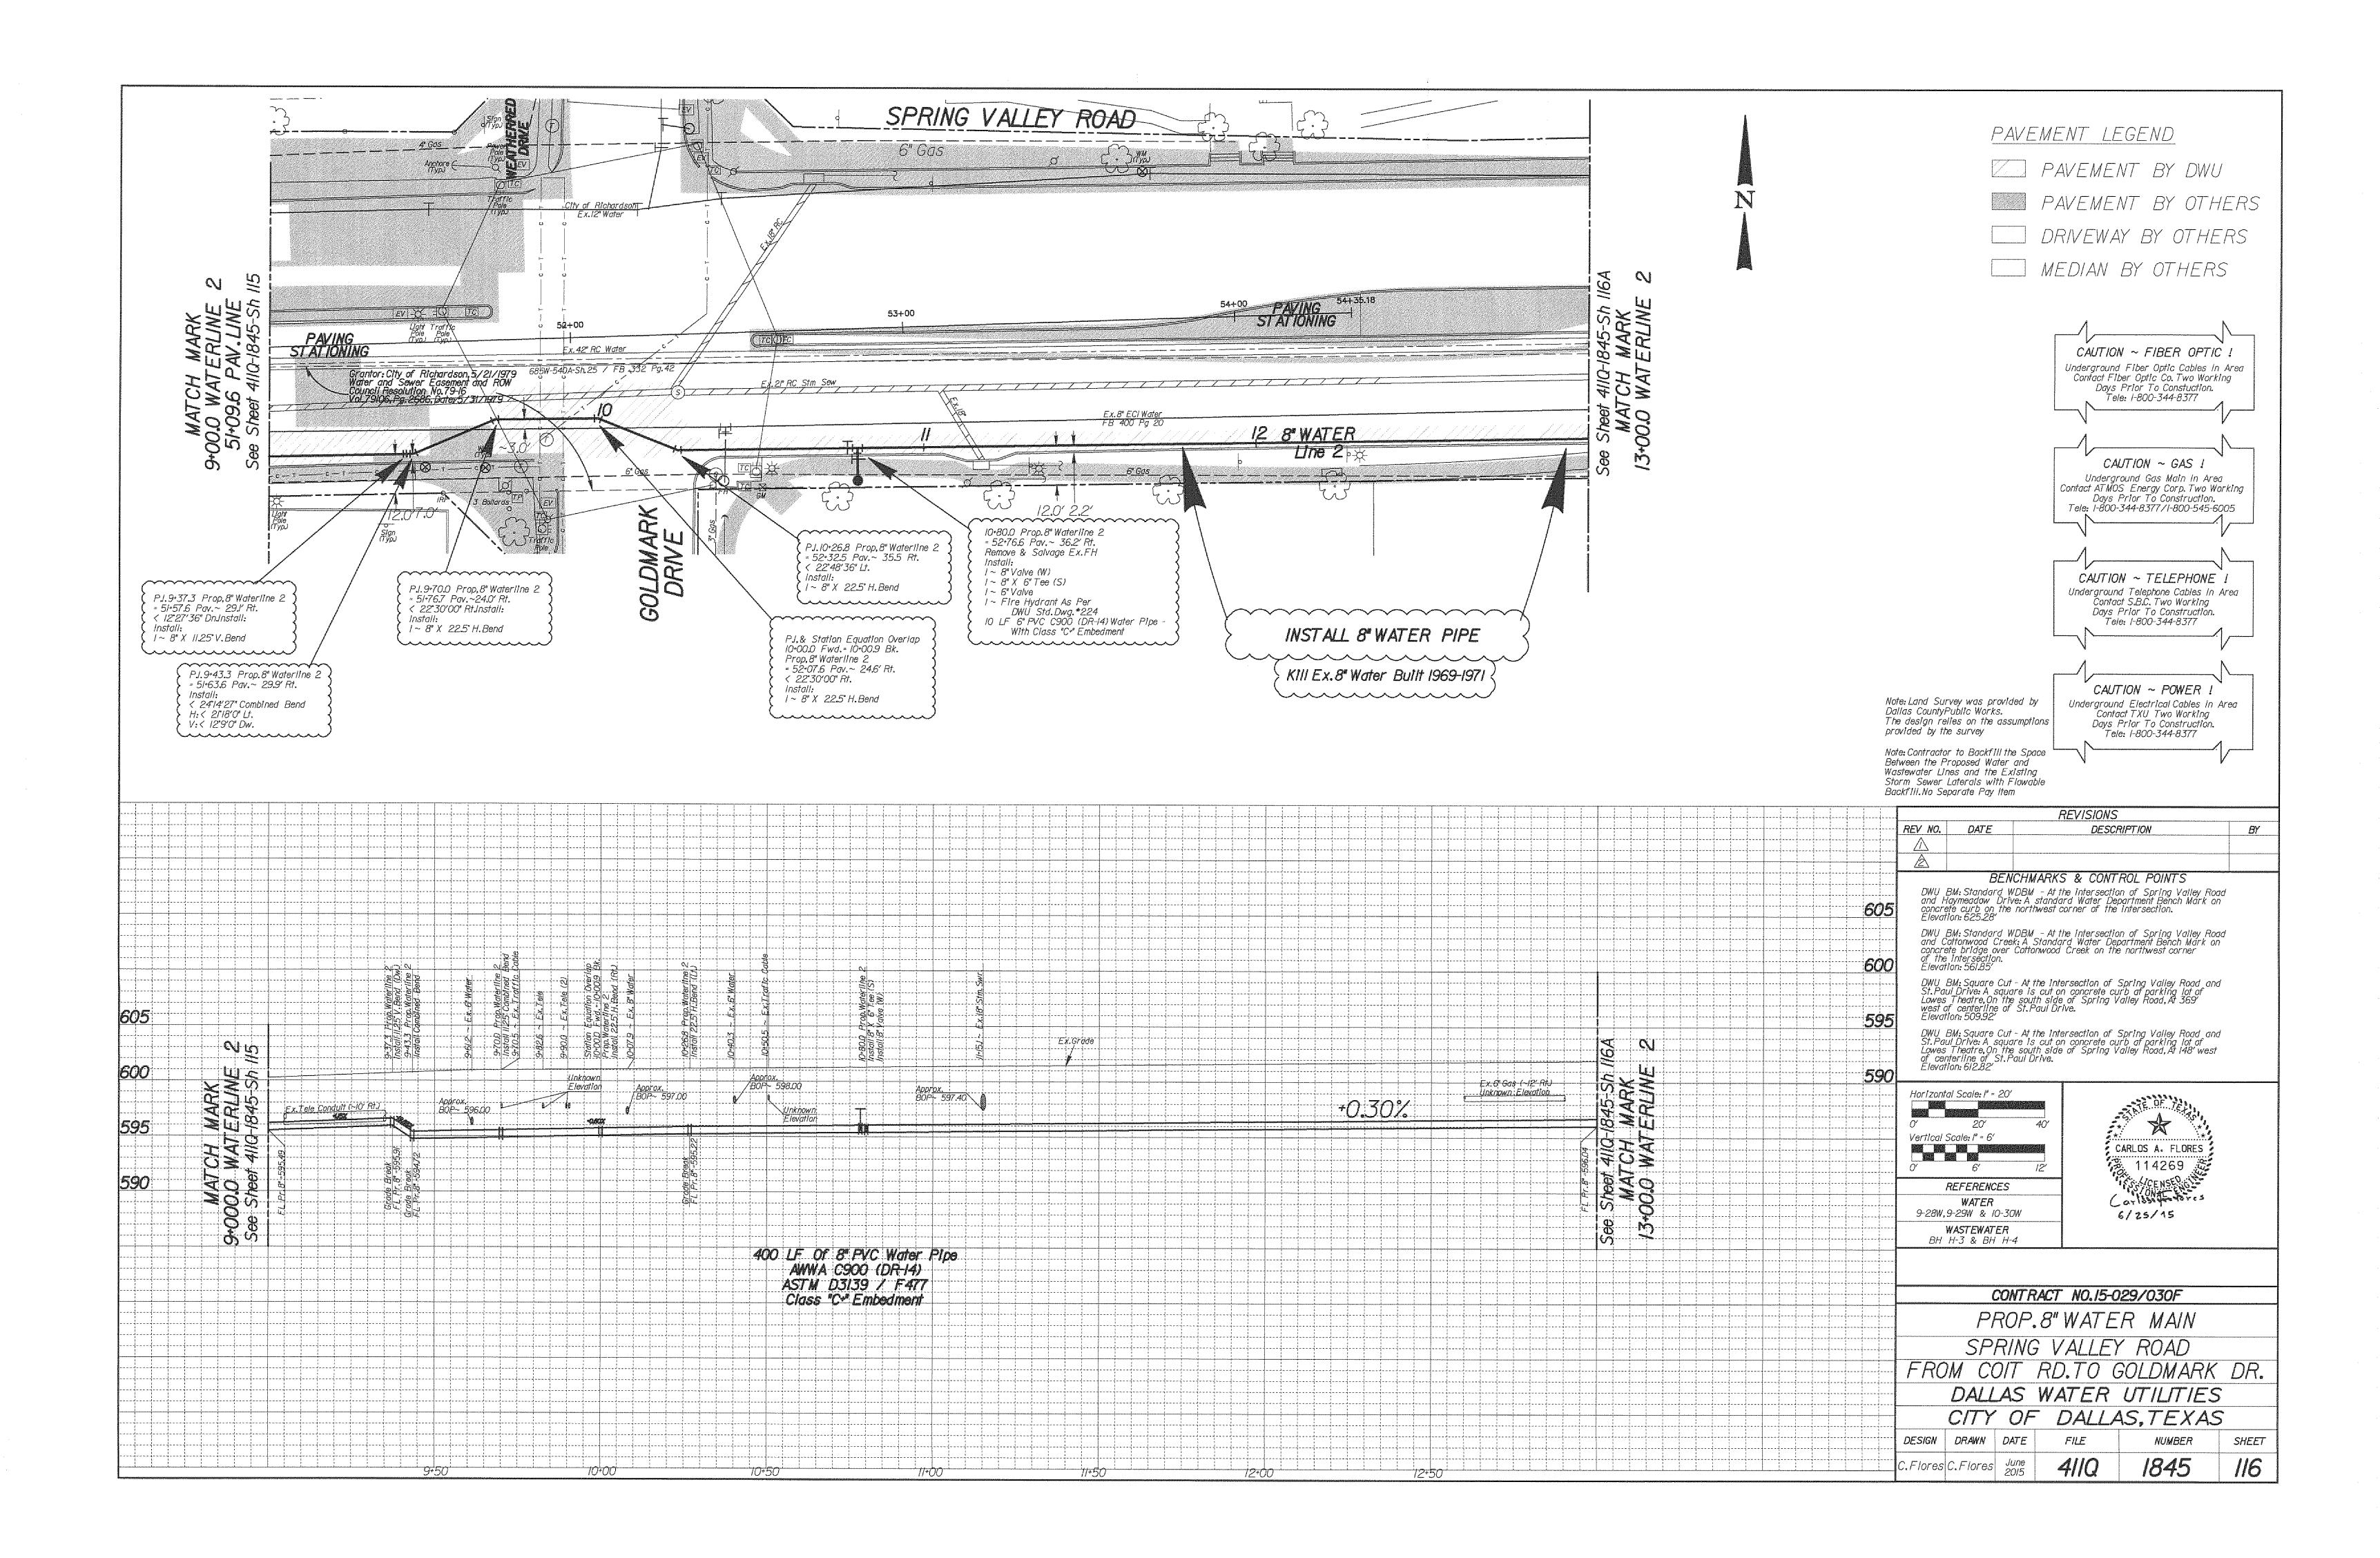


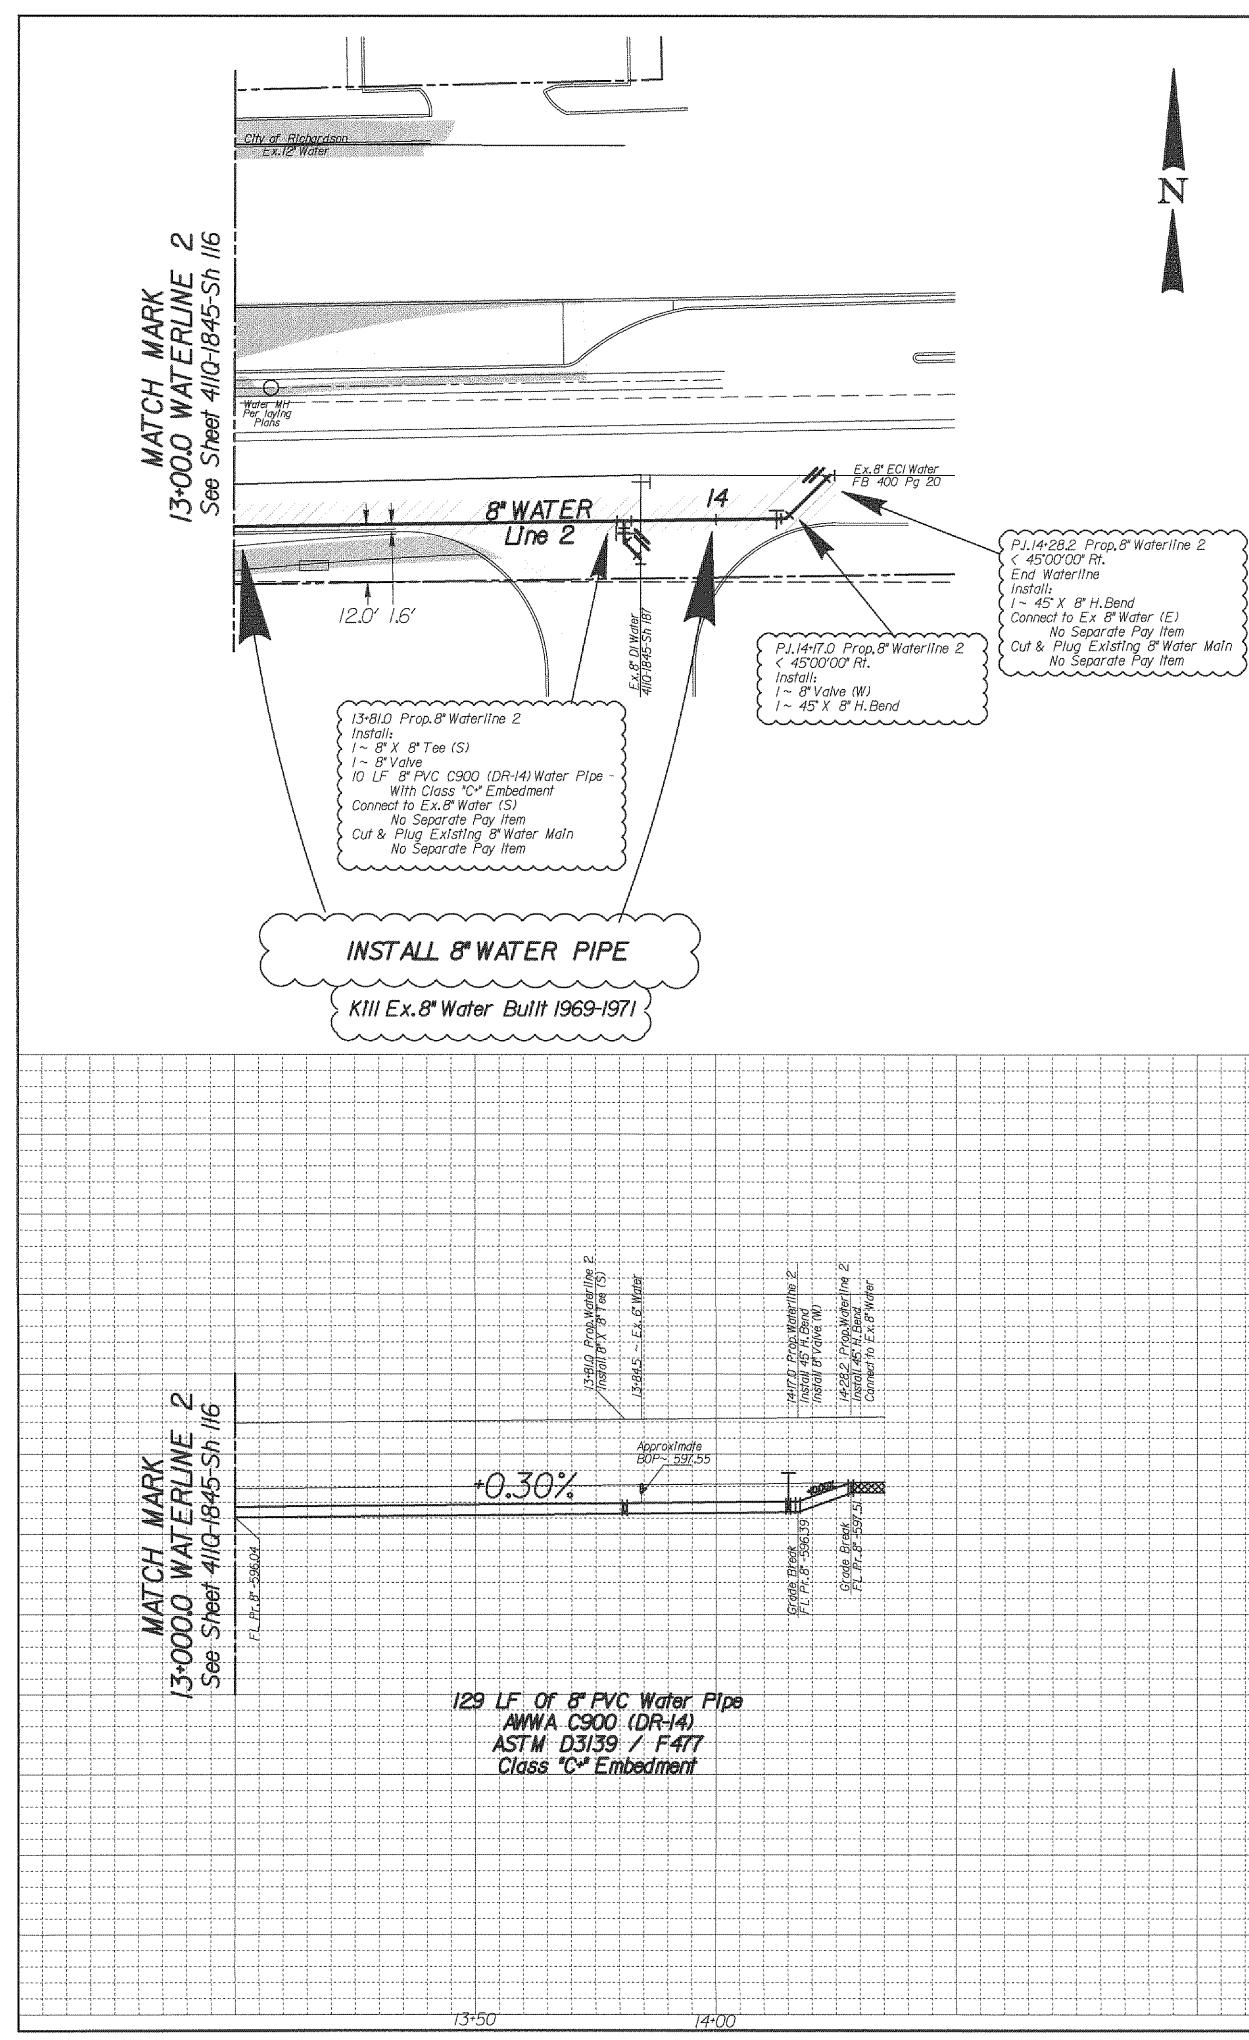












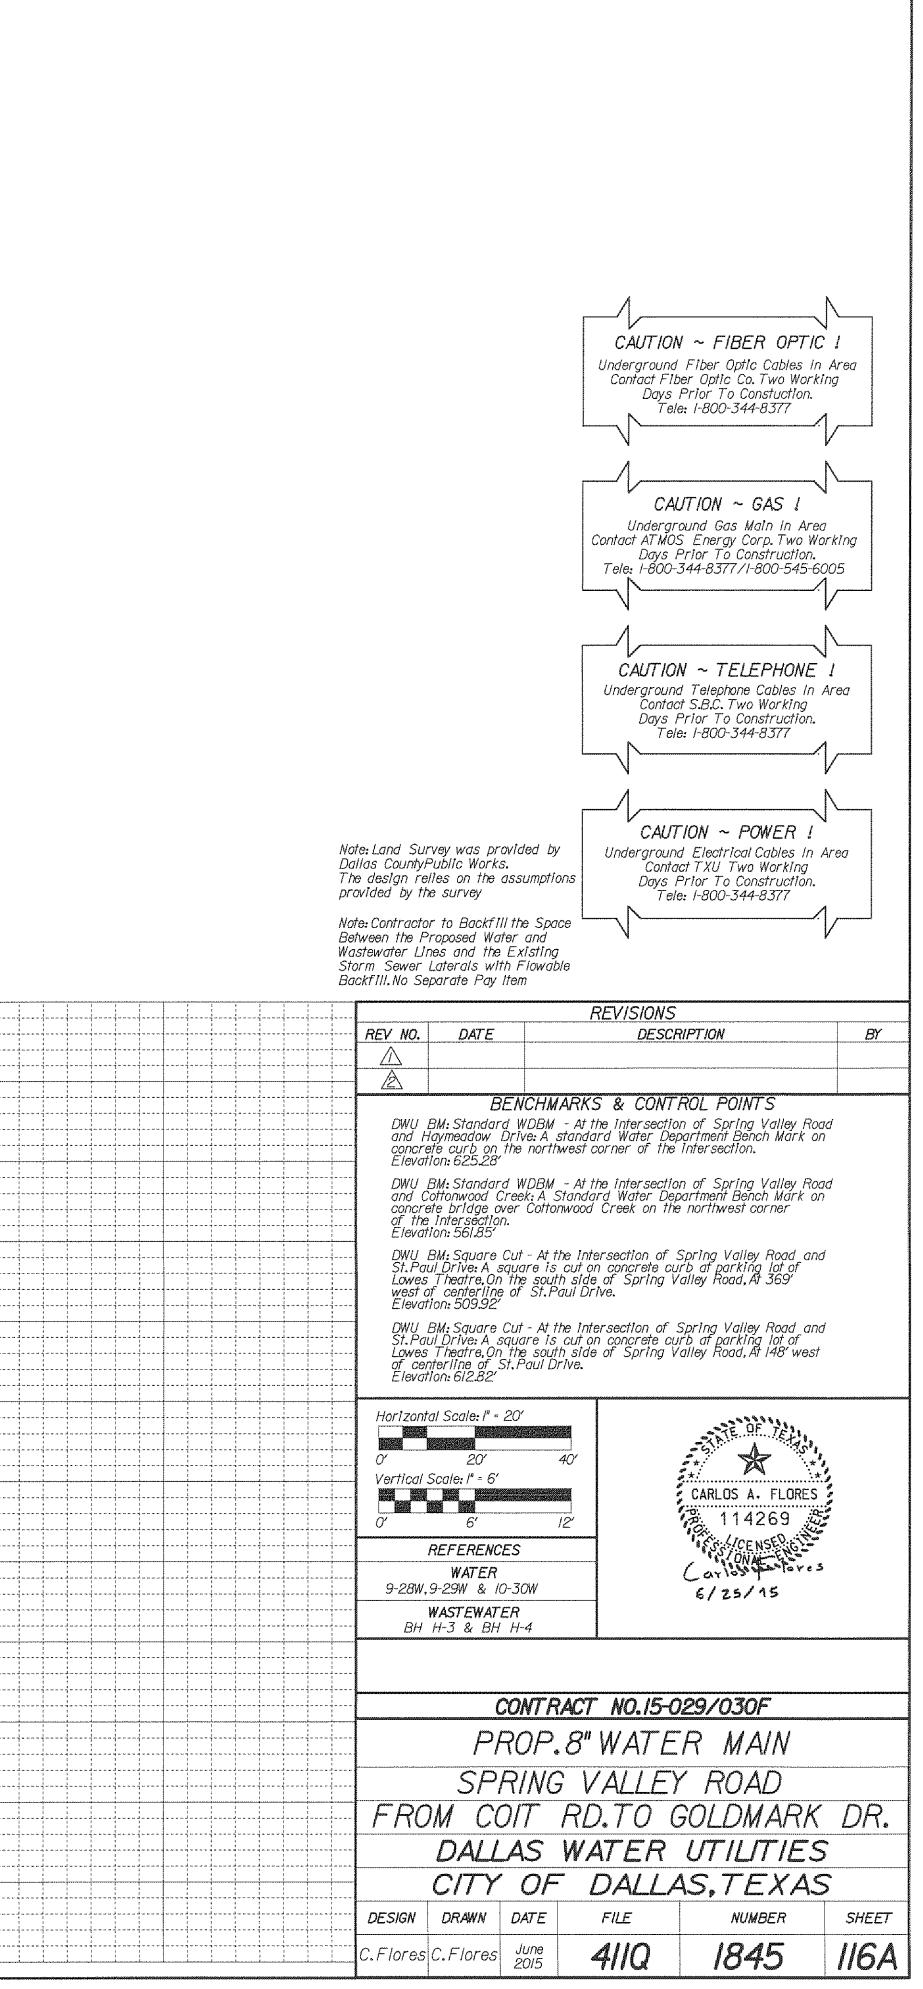


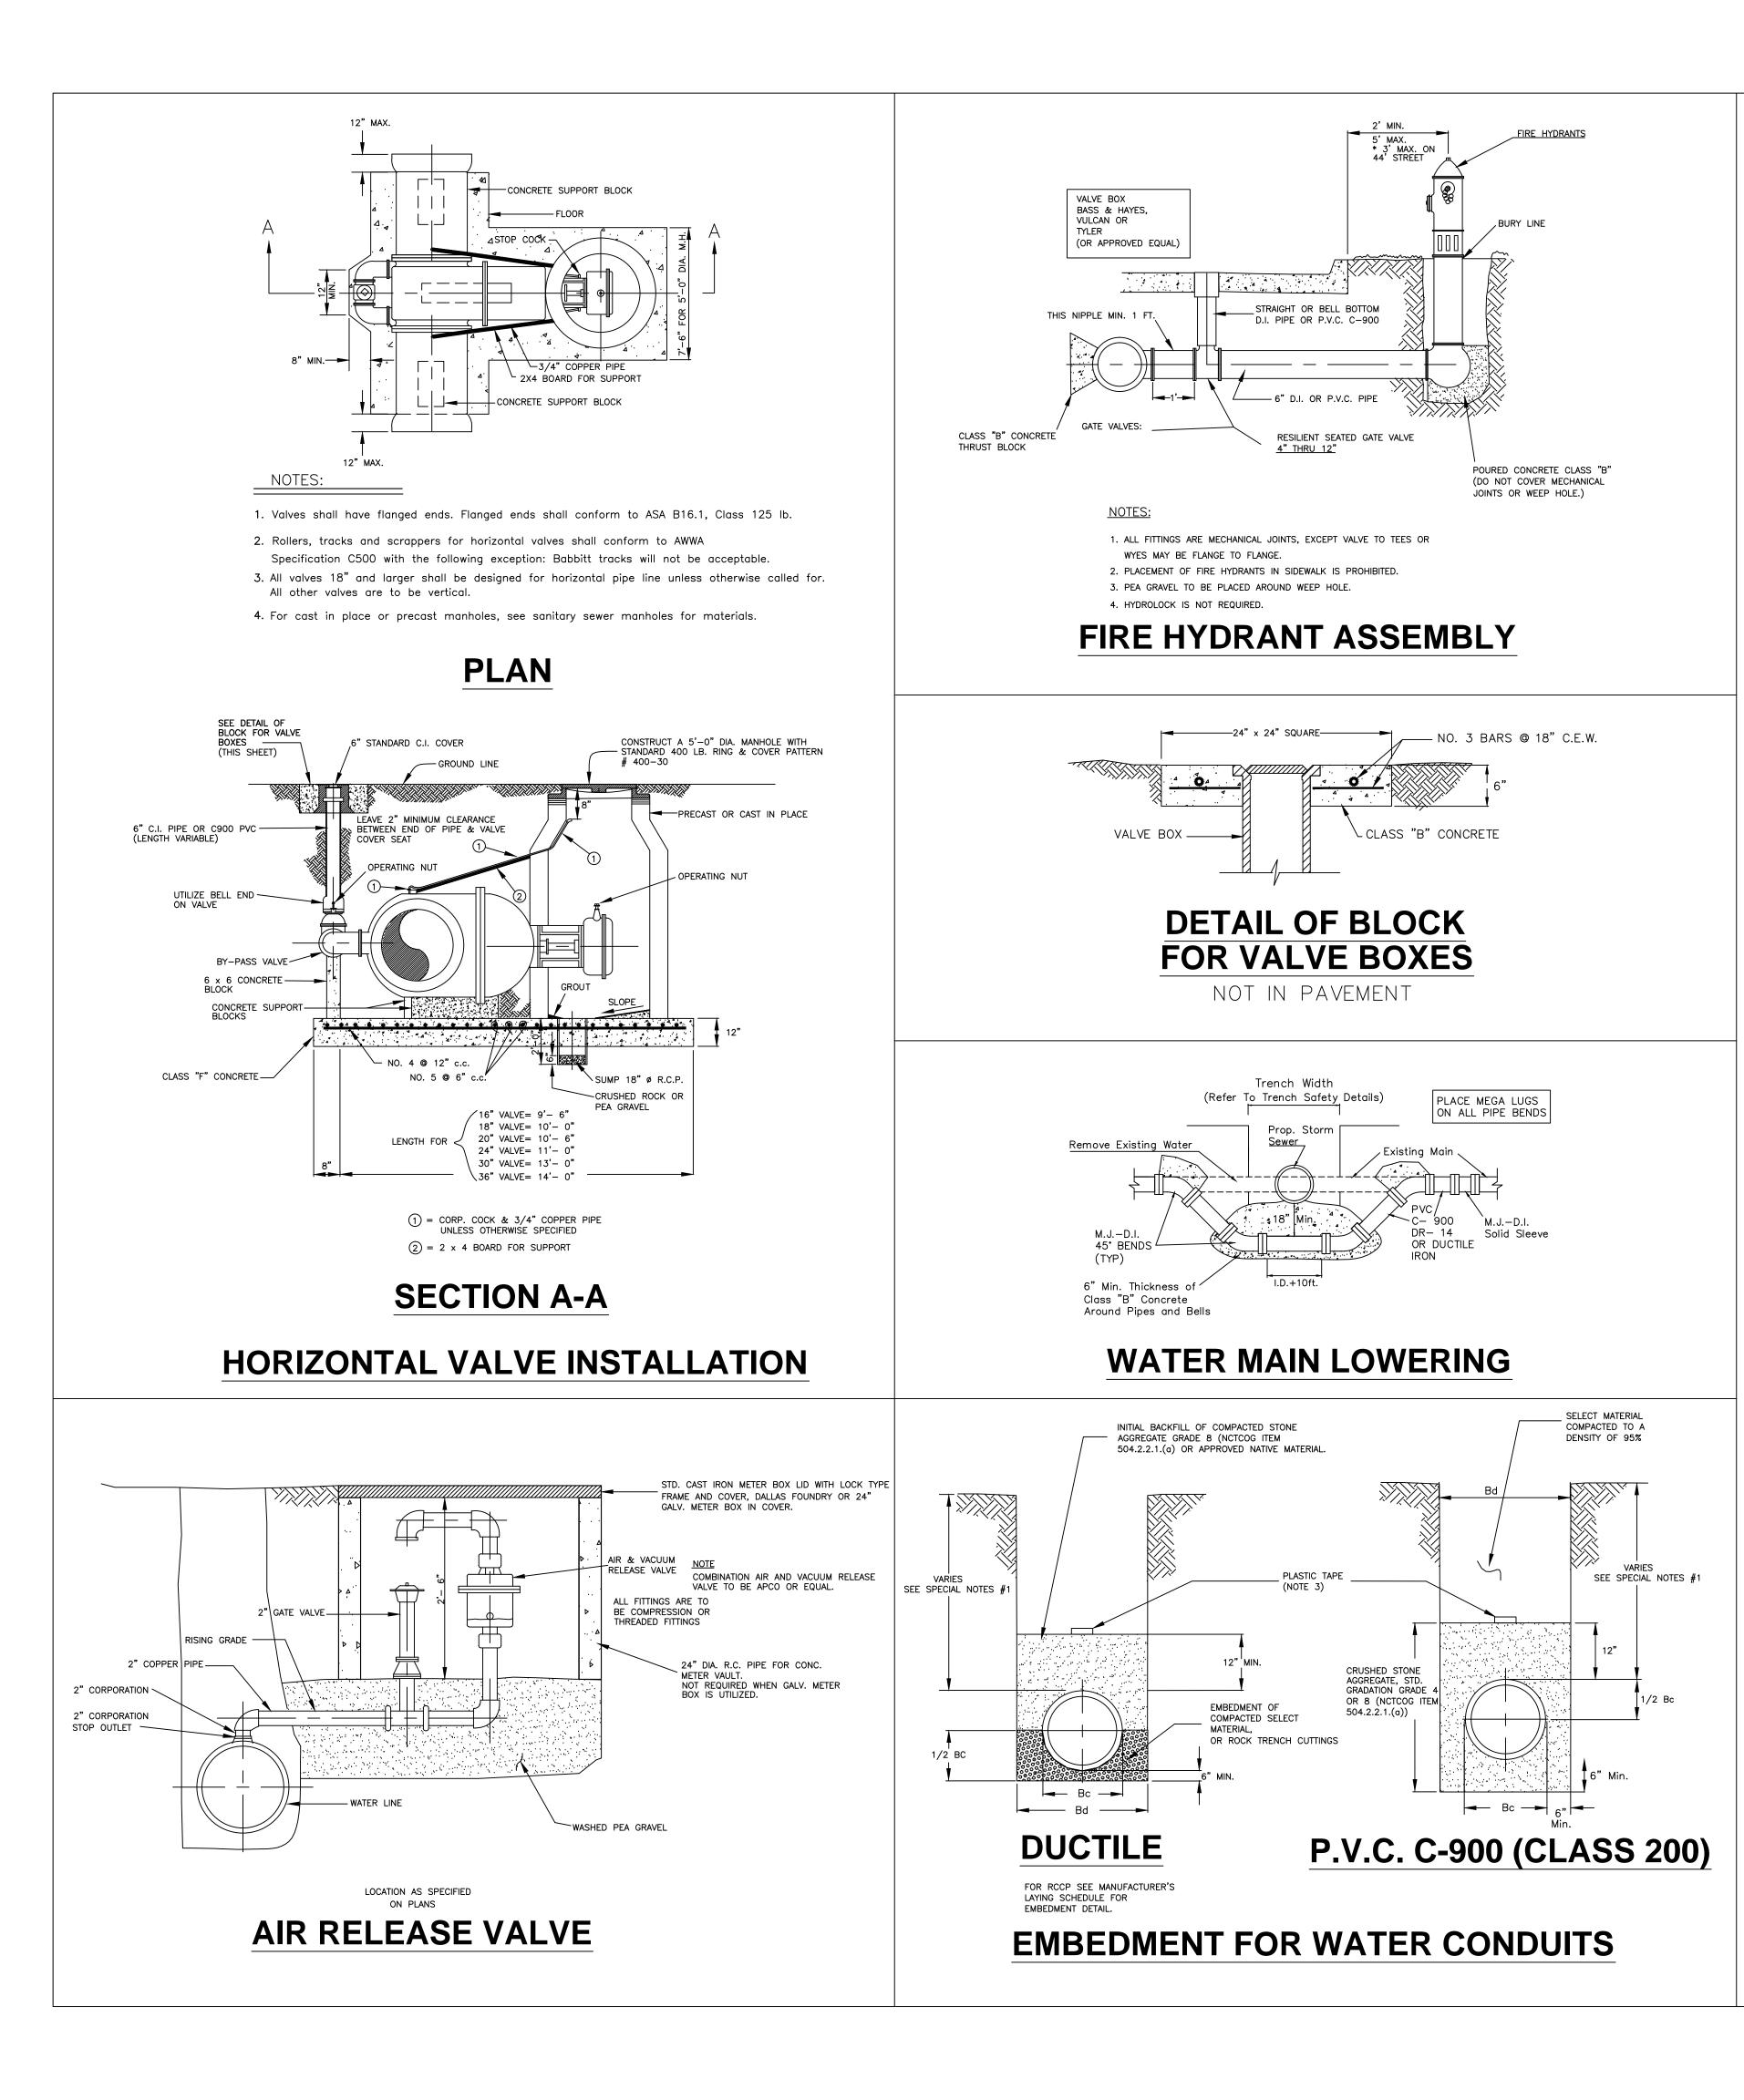
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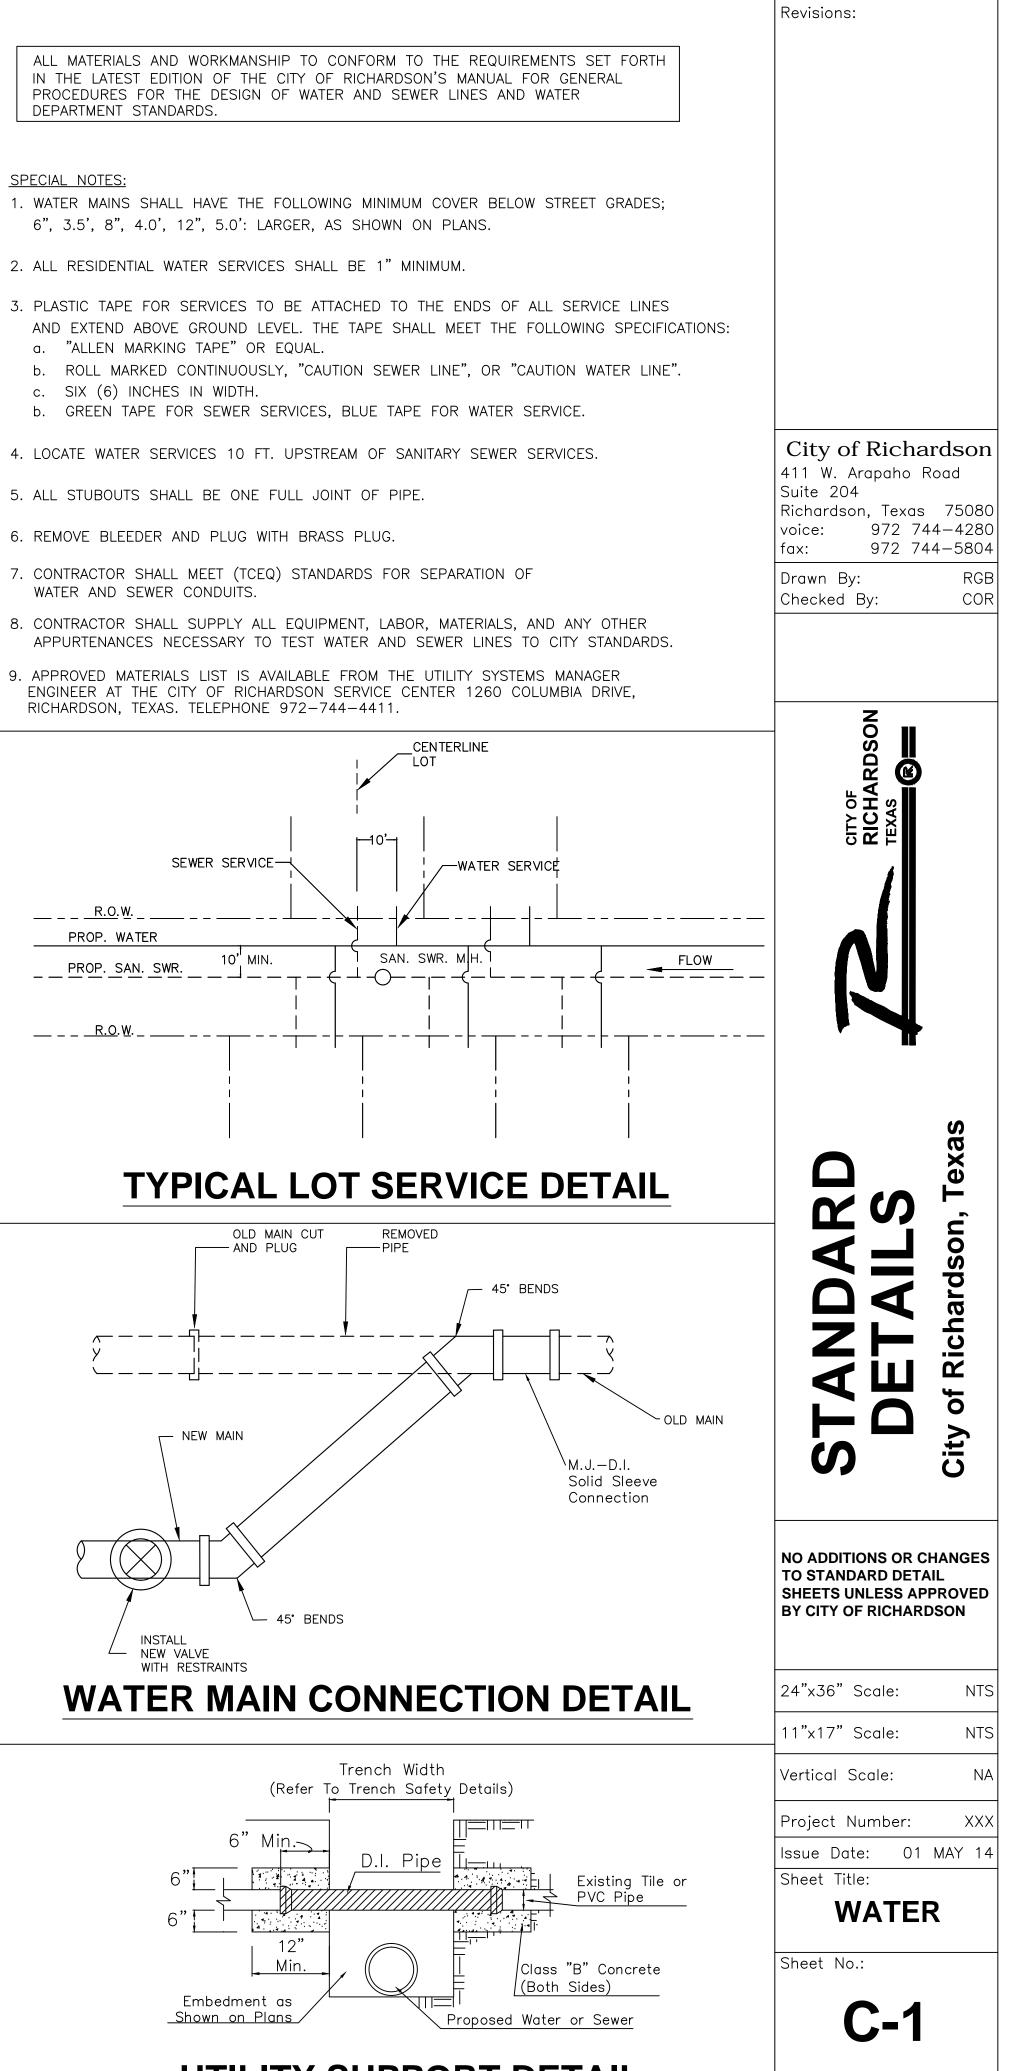
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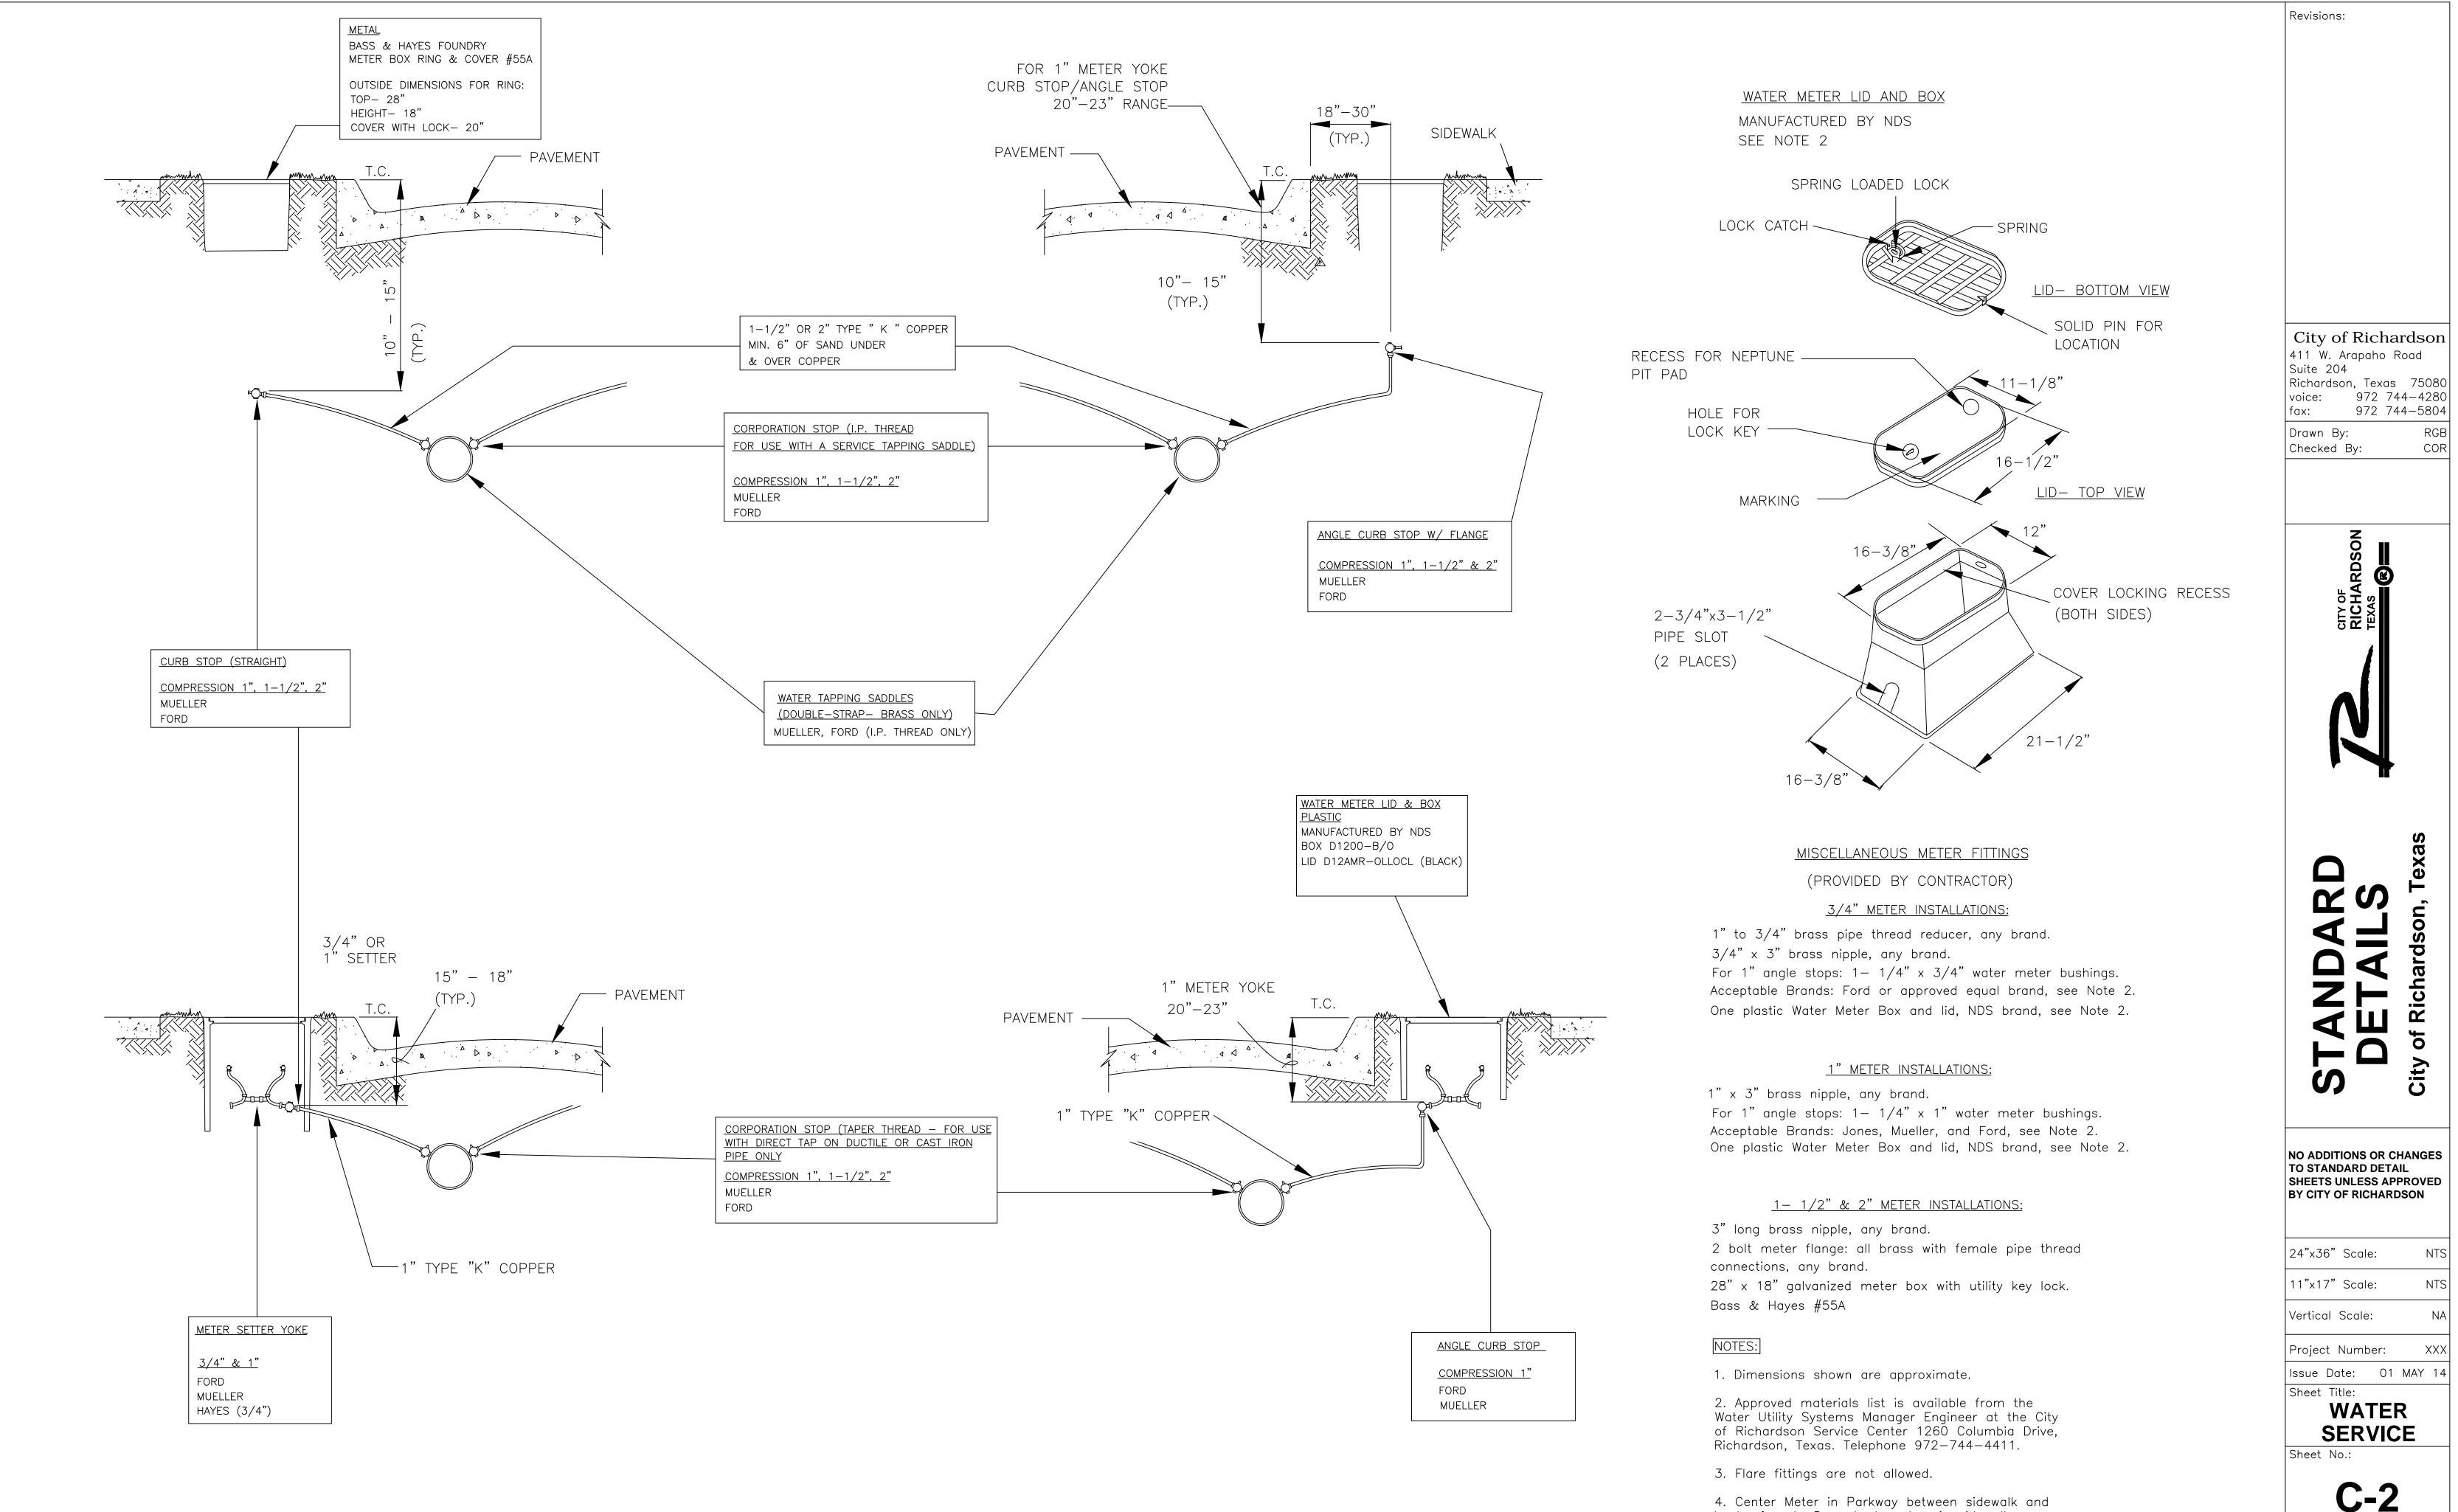




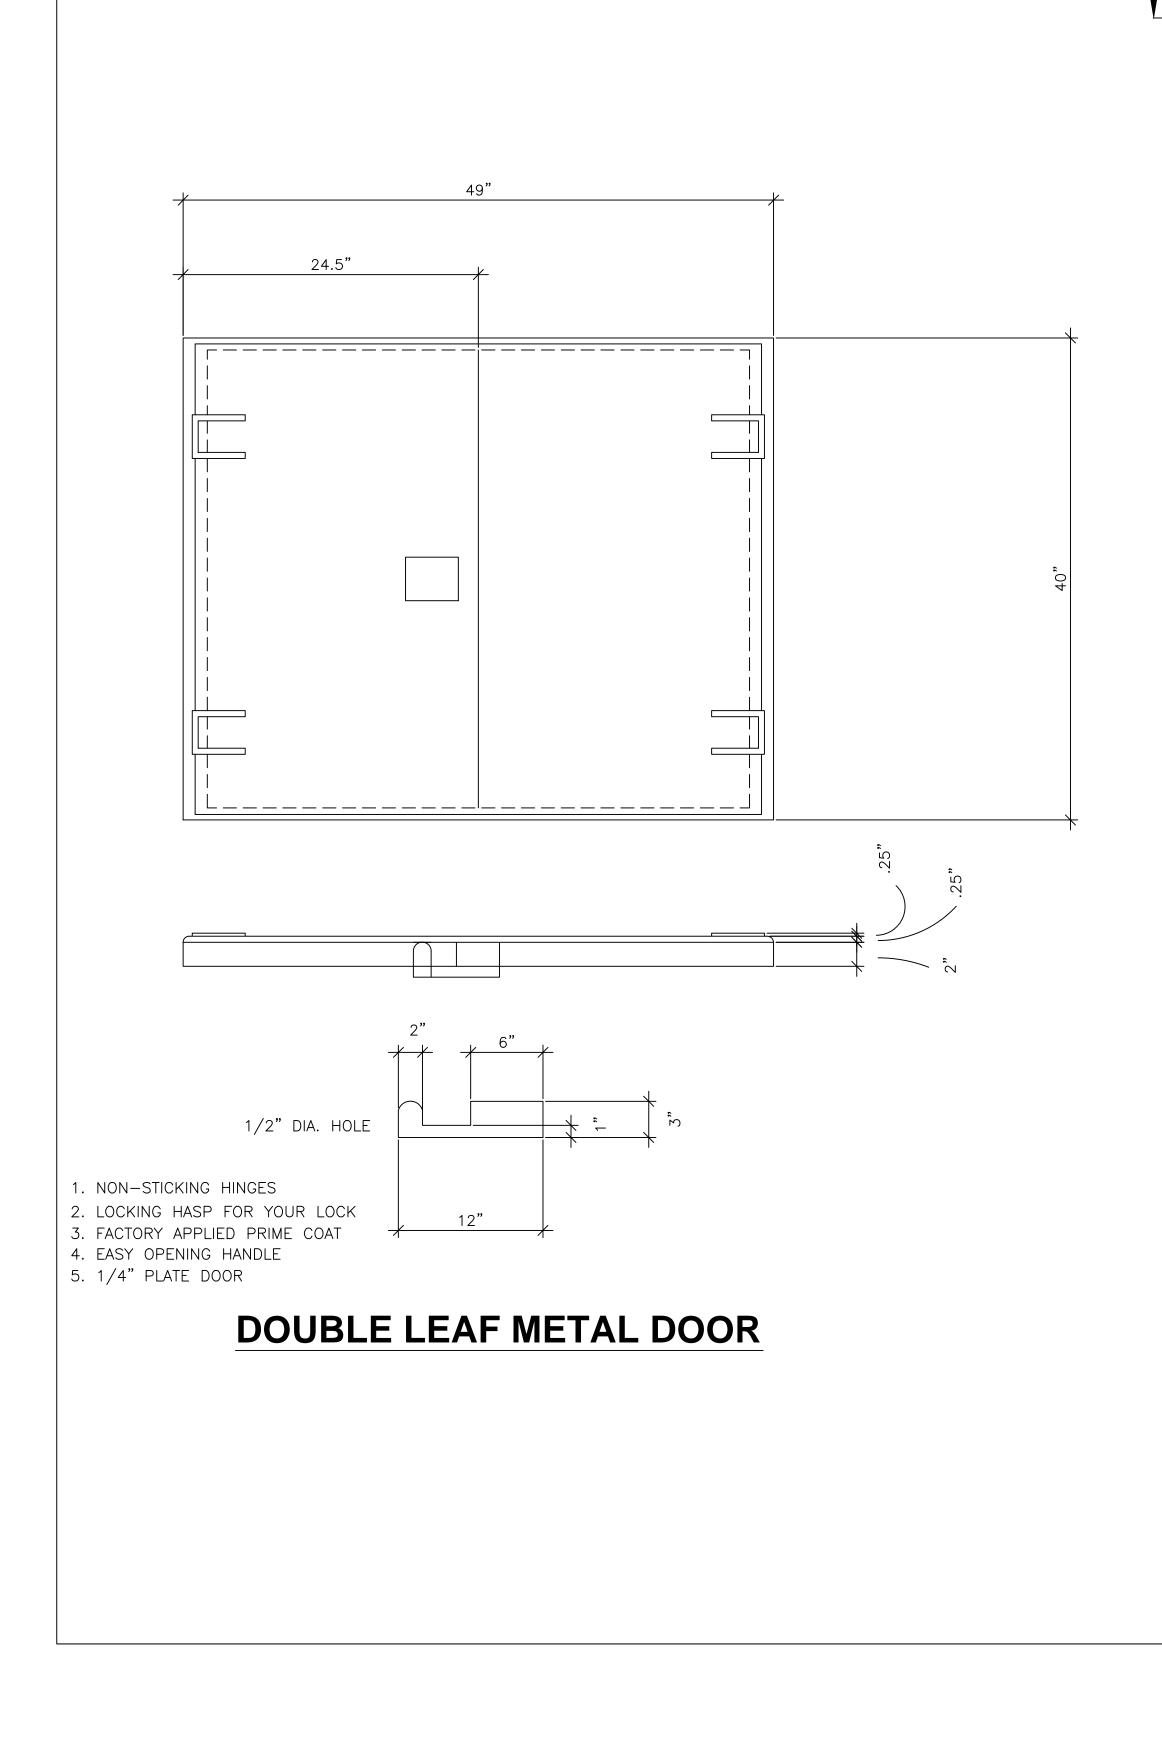
ACCEPTED MATERIALS MANUFACTURERS <u>(SEE NOTE 9)</u> GATE VALVES М&Н CLOW RESILIENT SEATED GATE VALVE <u>4" THRU 12"</u> MUELLER CLOW KENNEDY AFC AVK TAPPING SLEEVES М&Н CLOW MUELLER AFC TYLER TAPPING VALVES М&Н CLOW MUELLER AFC AVK <u>FIRE HYDRANTS</u> MUELLER #A423 M & H #129 CLOW #F2545 KENNEDY 5-1/4" K81D AVK #2700 WATEROUS #WB-67 ADJUSTABLE VALVE BOX WITH LID TYLER BASS & HAYES EAST JORDAN IRON WORKS VALVE BOX WITH LID FOR USE WITH C-900 P.V.C. VALVE STACK EAST JORDAN IRON WORKS TYLER BASS & HAYES STAINLESS STEEL WATERMAIN REPAIR CLAMP WITH OR WITHOUT SERVICE OUTLET MUELLER FORD APPROVED PIPE 4-12" C-900-DR 14 GREATER THAN OR EQUAL TO 14" C-905-DR 18 CLASS 200, DR 14 DUCTILE IRON: CLASS 50 & 51 WITH MECHANICAL JOINT ACCESSORIES CEMENT LINED. APPROVED FITTINGS MADE IN USA ONLY COMBINATION AIR VALVES STANDARD, SINGLE- BODY DOUBLE ORIFICE 1" THRU 6": APCO OR APPROVED EQUAL GATE VALVES FOR COMBINATION AIR VALVES <u>1" THRU 2"</u> NIBCO # T- 131; # T- 133, OR APPROVED EQUAL

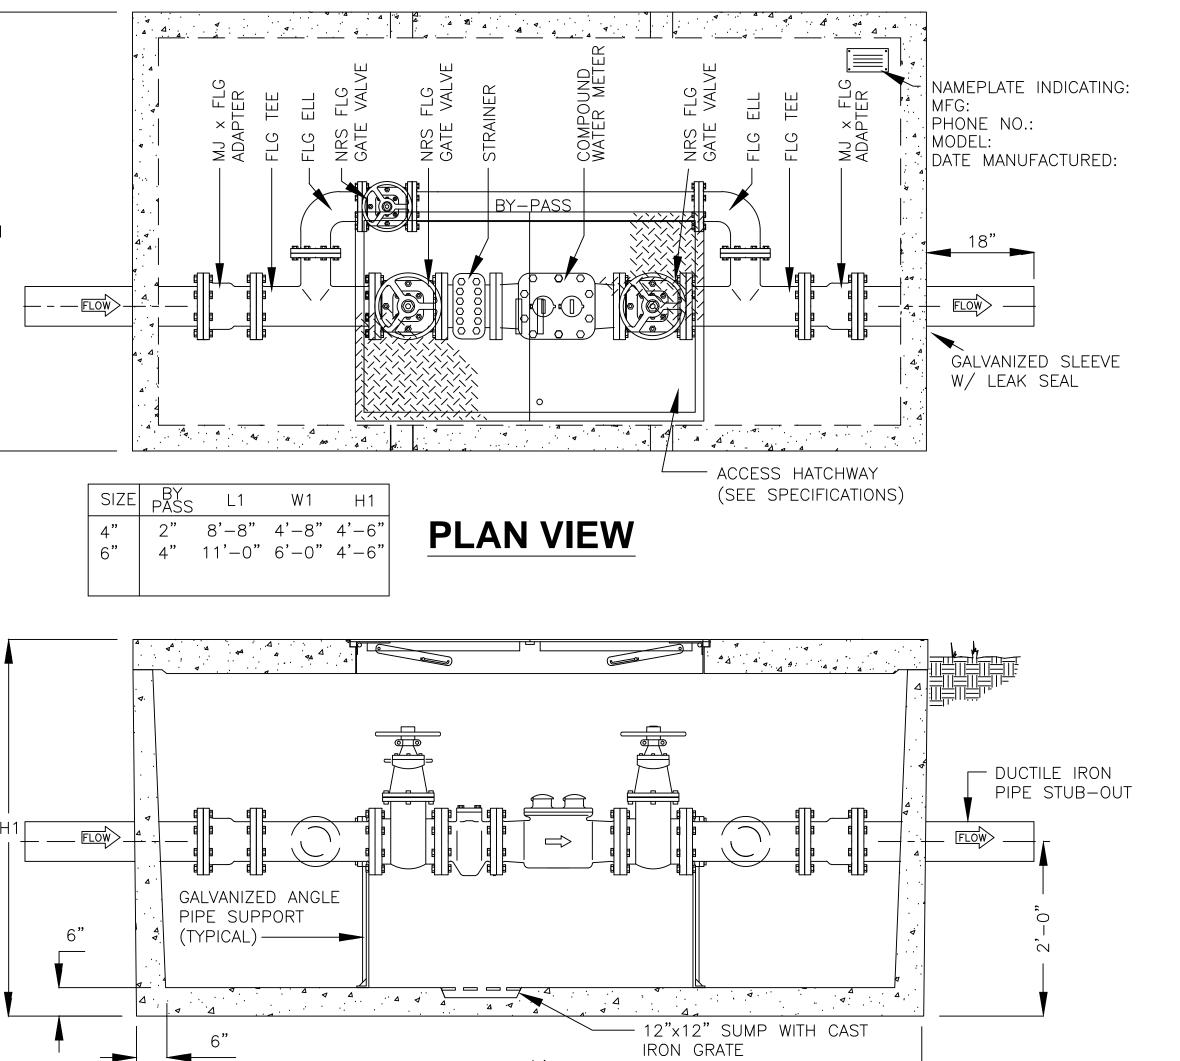


UTILITY SUPPORT DETAIL



4. Center Meter in Parkway between sidewalk and back of curb. Do not place box in sidewalk.





ELEVATION

L1

PIPE AND FITTINGS SHALL BE DUCTILE IRON

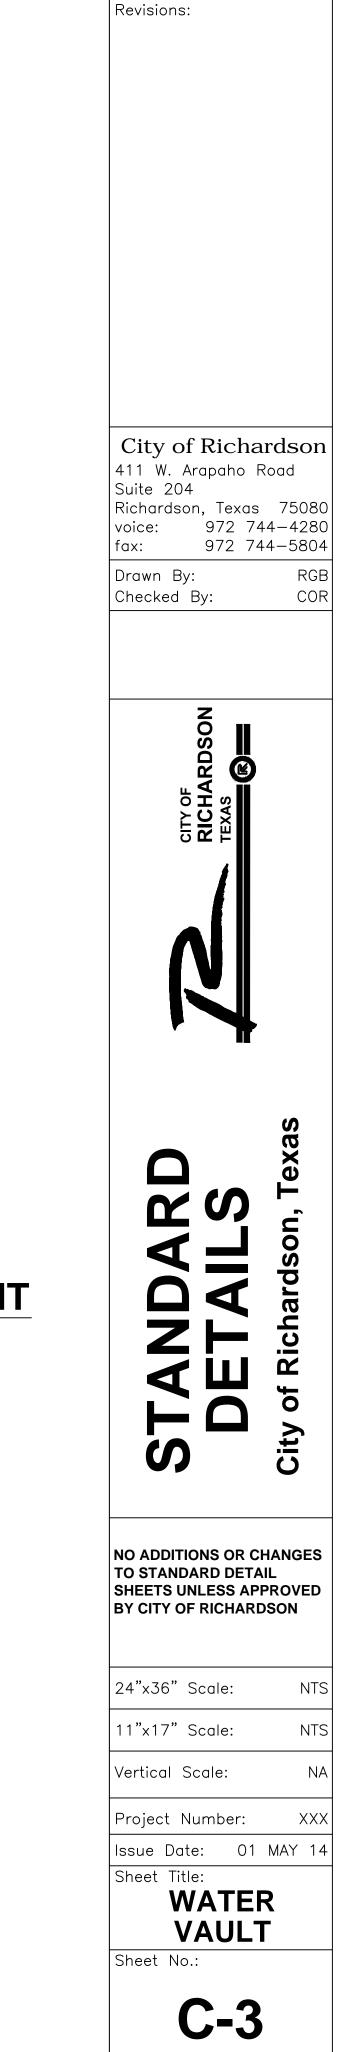
SPECIFICATIONS	
CONCRETE :	CLASS 1 CONCRETE WITH DESIGN STRENGTH OF 4500 PSI AT 28 DAYS. UNIT IS OF MONOLITHIC CONSTRUCTION AT FLOOR AND FIRST STAGE OF WALL WITH SECTIONAL RISER TO REQUIRED DEPTH.
REINFORCEMENT:	GRADE 60 REINFORCED. STEEL BAR CONFORMING TO ASTM A615 ON REQUIRED CENTERS OR EQUAL.
HATCHWAY:	3' X 5' GALVANIZED STEEL DOUBLE LEAF SPRING ASSISTED HATCHWAY – TRAFFIC RATED W/ SLAM LOCK.

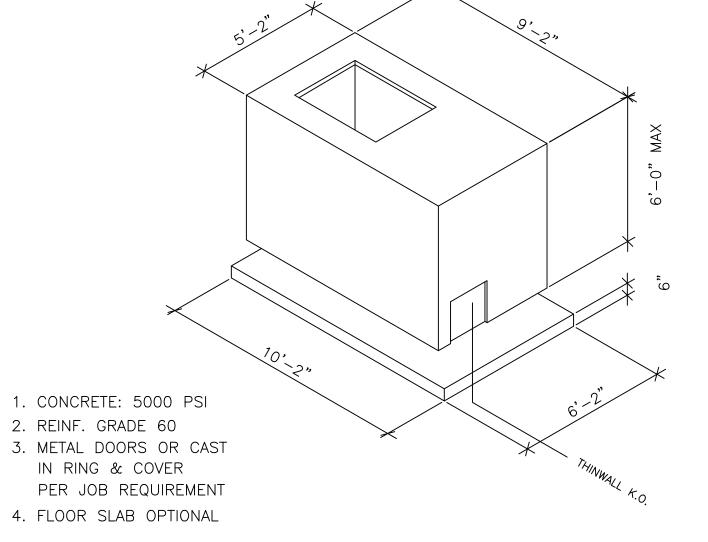
1. PRECAST VAULT SHALL BE FROM HANSEN PIPE & PRECAST, GRAND PRAIRIE, TEXAS PLANT OR APPROVED OTHER EQUAL.

2. DIMENSIONS SHOWN ARE APPROXIMATE ONLY.

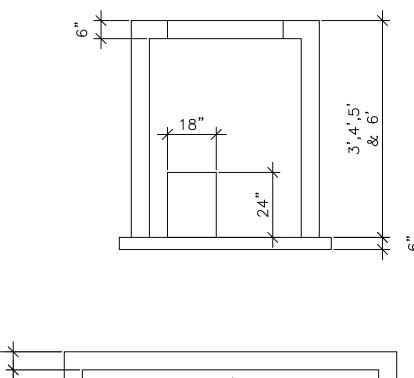
3. SHOP DRAWINGS SHALL BE SUBMITTED BY CONTRACTOR FOR APPROVAL BY THE ENGINEER AND ACCEPTANCE BY CITY OF RICHARDSON PRIOR TO CONTRUCTION.

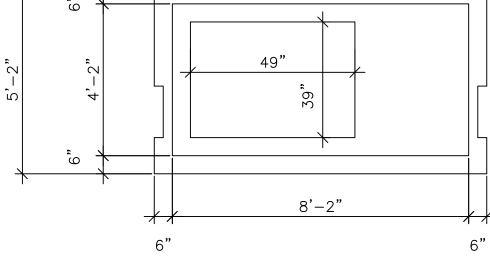
DOMESTIC WATER METER VAULT





HANSEN PIPE & PRECAST COMPOUND METER VAULT GRAND PRAIRIE, TEXAS PLANT







FALSE MANHOLE BOTTOMS WILL BE FURNISHED AND INSTALLED IN ALL MANHOLES CONSTRUCTED IN ADVANCE OF PAVING. THESE FALSE MANHOLE BOTTOMS WILL BE INSTALLED AT A TIME DIRECTED BY THE ENGINEER, BUT WILL USUALLY BE AFTER ALL WORK IS COMPLETED ON THE SANITARY SEWER SYSTEM INCLUDING THE AIR TEST,

<u>REMOVAL</u>

FALSE MANHOLE BOTTOMS WILL BE REMOVED AFTER THE FINAL APPURT. ADJUSTMENT INSPECTION. THE PAVING CONTRACTOR AND CITY FORCES REPRESENTATIVES WILL COORDINATE THE REMOVAL OF THE FALSE MANHOLE BOTTOMS.

45' WYE

— 1/8 CURVE

·CLASS "B" CONCRETE

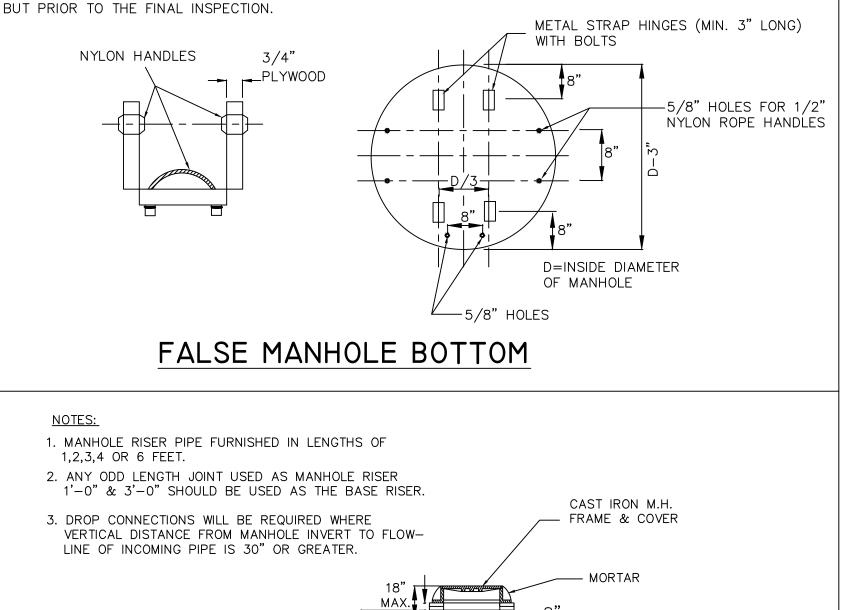
UNDISTURBED EARTH

ENCASEMENT TO

(FOR PRE-CAST)

<u>O-RING</u> GIFFORD HILL OR CONCRETE PIPE PRODUCTS

90° CURVE



NOTE: (A) MANHOLES FOR 6', 8" & 10" LINES SHALL BE 48" DIA. MANHOLES FOR 12", 15" & 18" LINES SHALL BE 60" DIA. MANHOLES FOR 21", 24" & 27" LINES SHALL BE 72" DIA.

STANDARD MANHOLE WITH DROP CONNECTION

SEWER COLLECTION MATERIALS

VARIABLE

SEE NOTE A

STANDARD BOLT DOWN TYPE RING & COVER

(To be used on trunklines, areas of flooring, or as specified) MANHOLE PIPE CONNECTOR 5/8" stainless hex cap screws

Acceptable Brands: Bass & Hayes VRM-30 Watertight or approved equal

STANDARD 400 LB RING & LID (To be used at all times) Pattern #400-30D Acceptable Brands: Bass & Hayes VRM-30 or approved equal

STANDARD 400 LB RING EXTENSION Pattern #400-30 3"Rise Only Acceptable Brands:

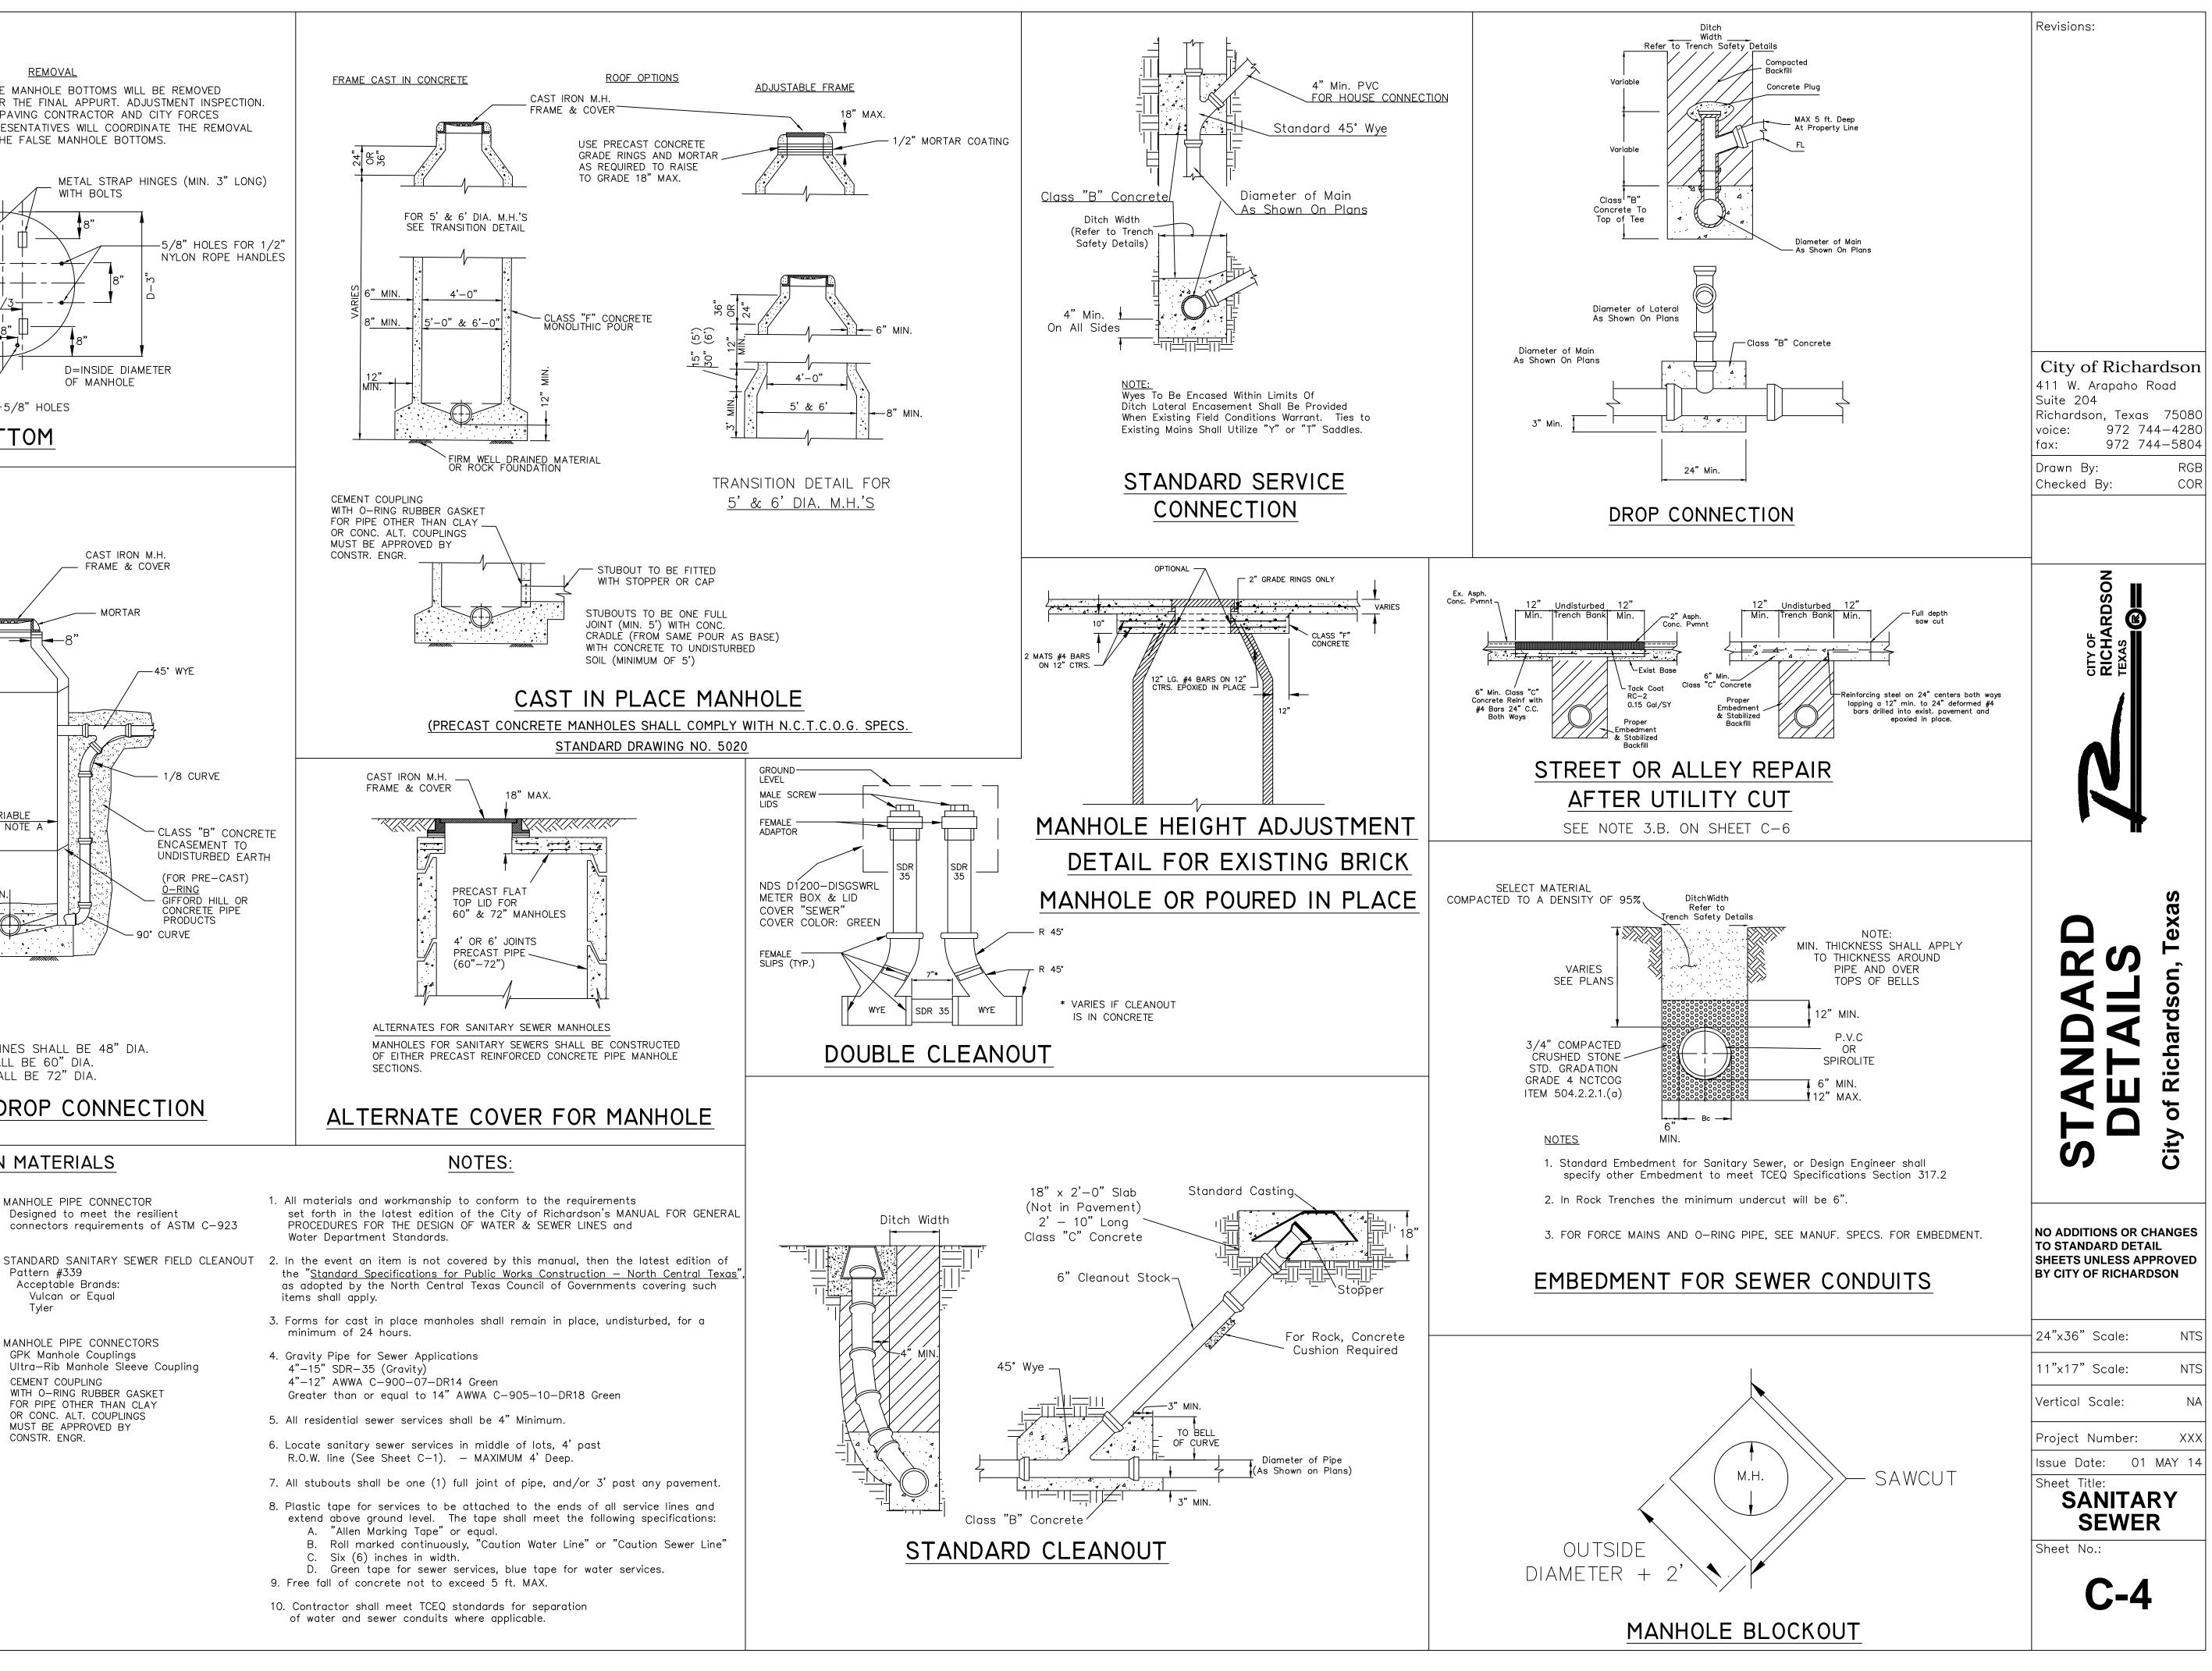
Bass & Hayes

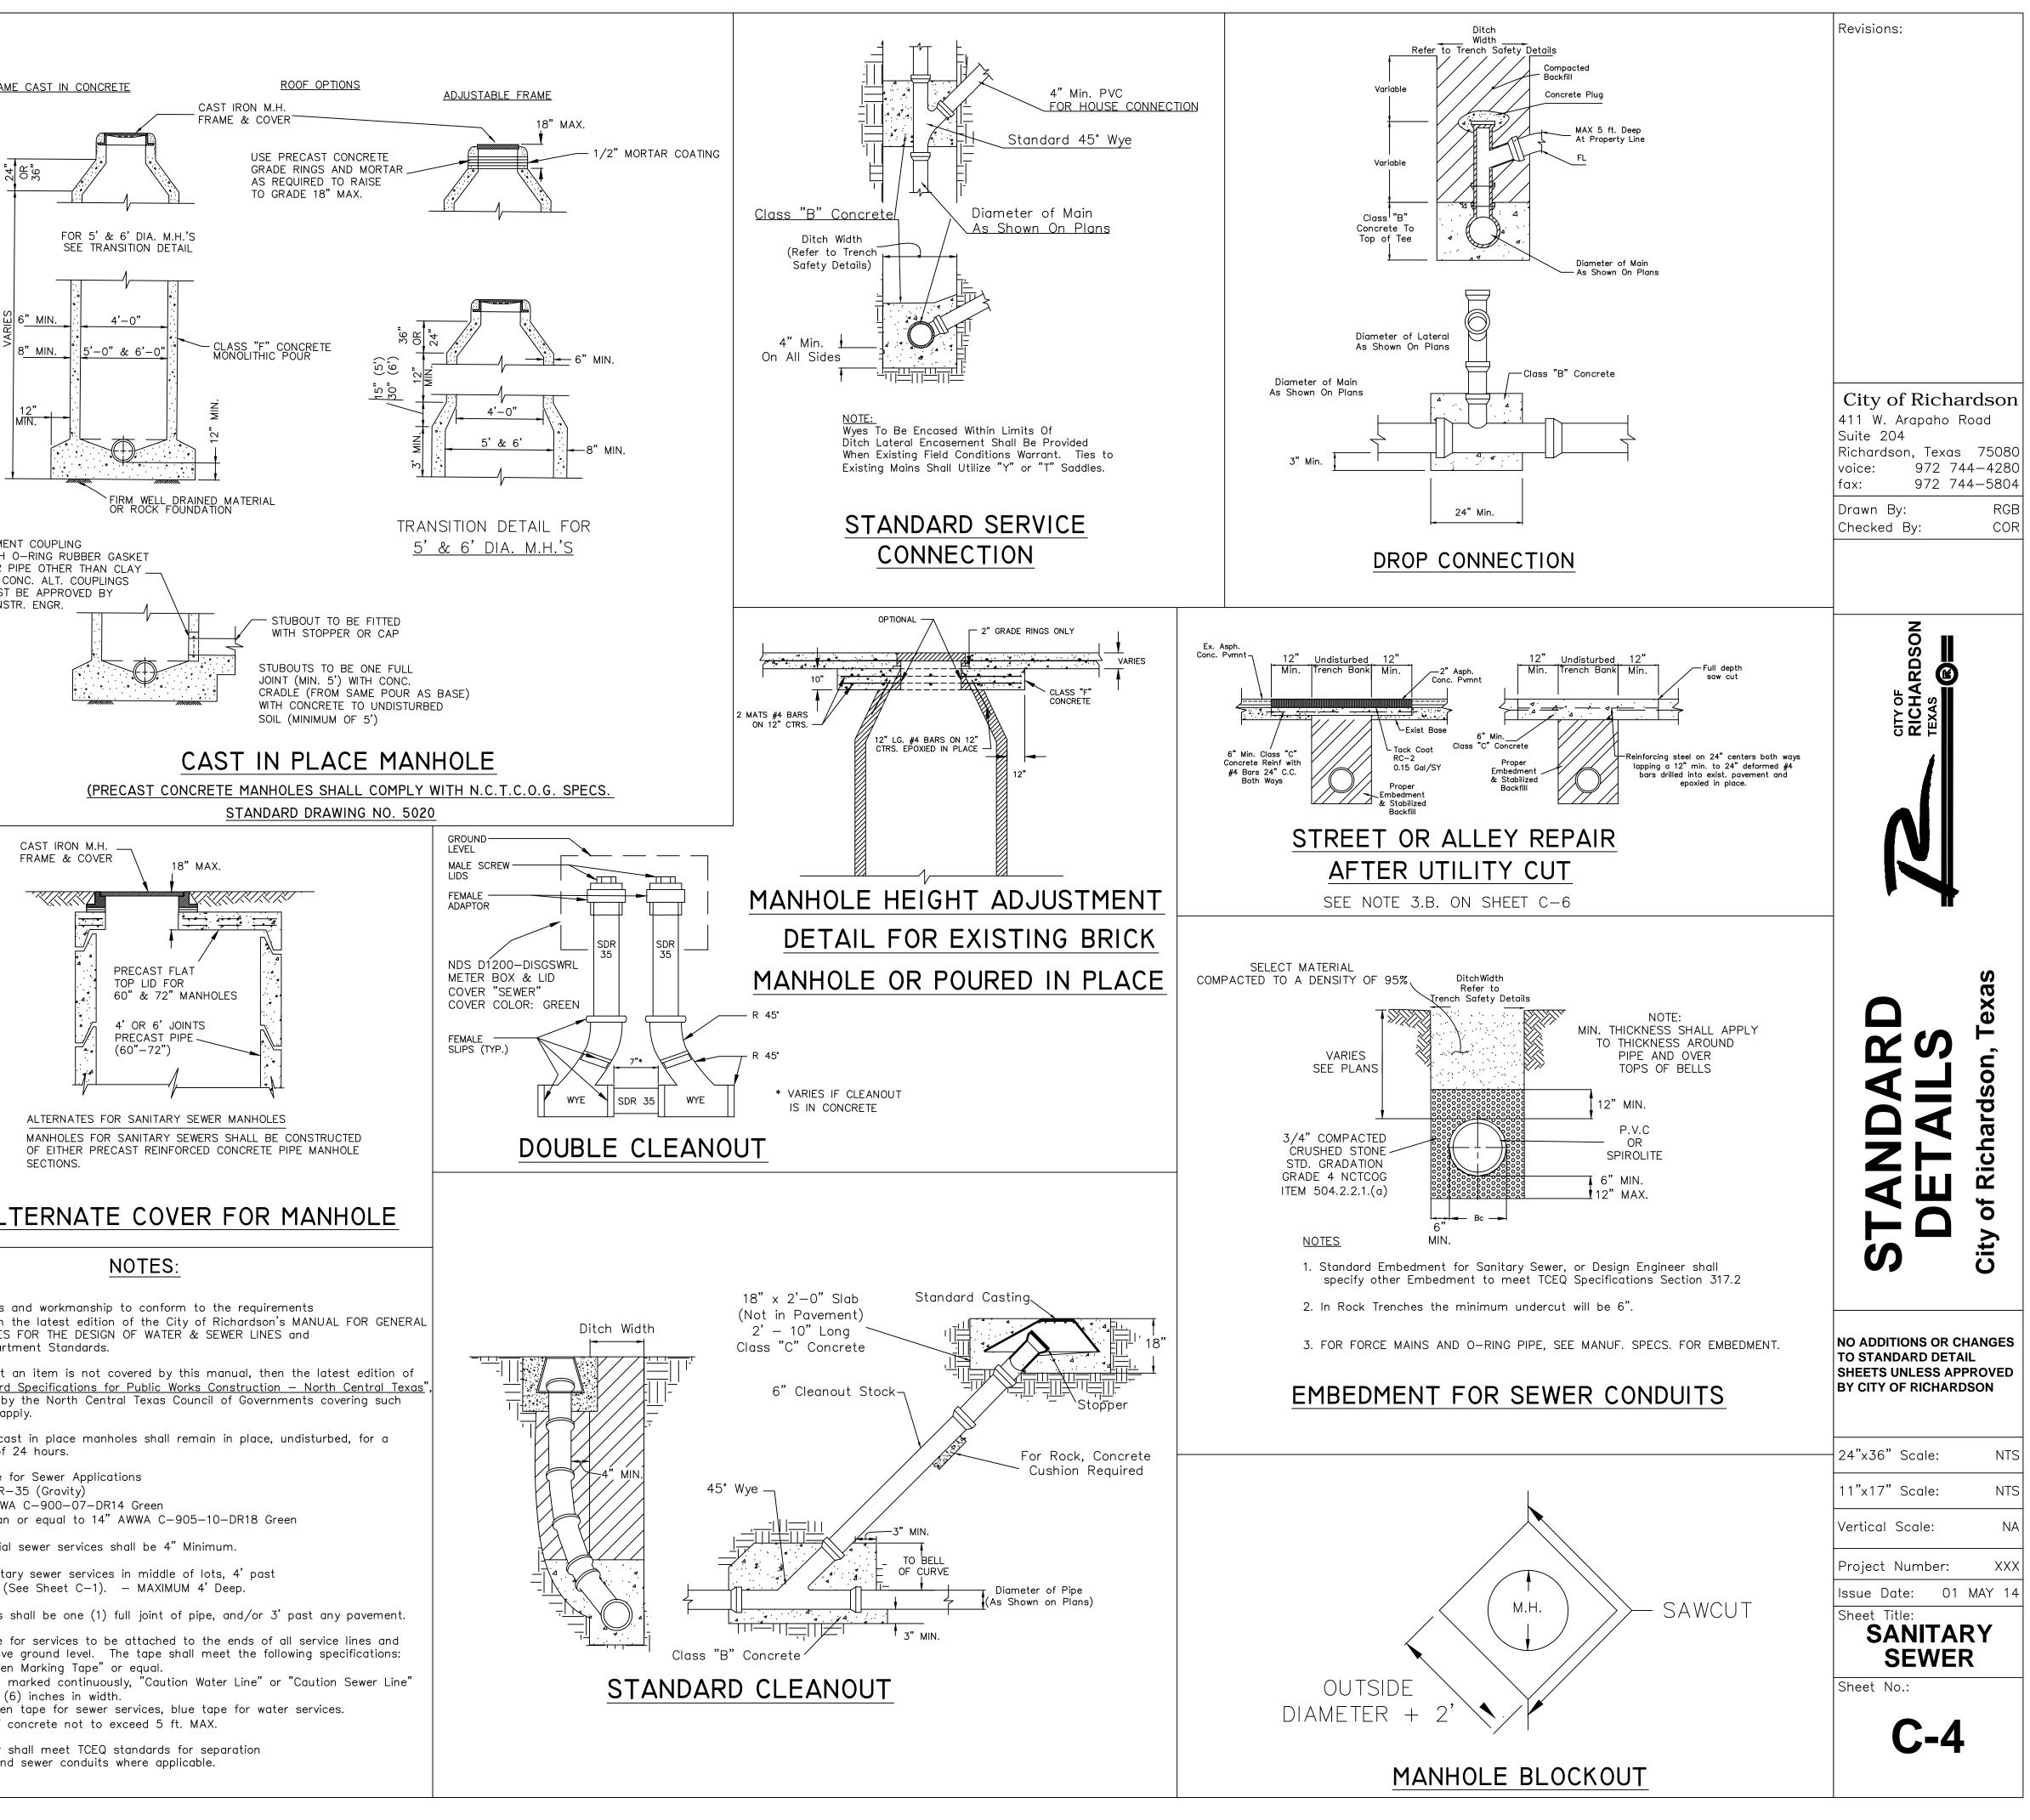
connectors requirements of ASTM C-923

Designed to meet the resilient

Pattern #339 Acceptable Brands: Vulcan or Equal Tyler

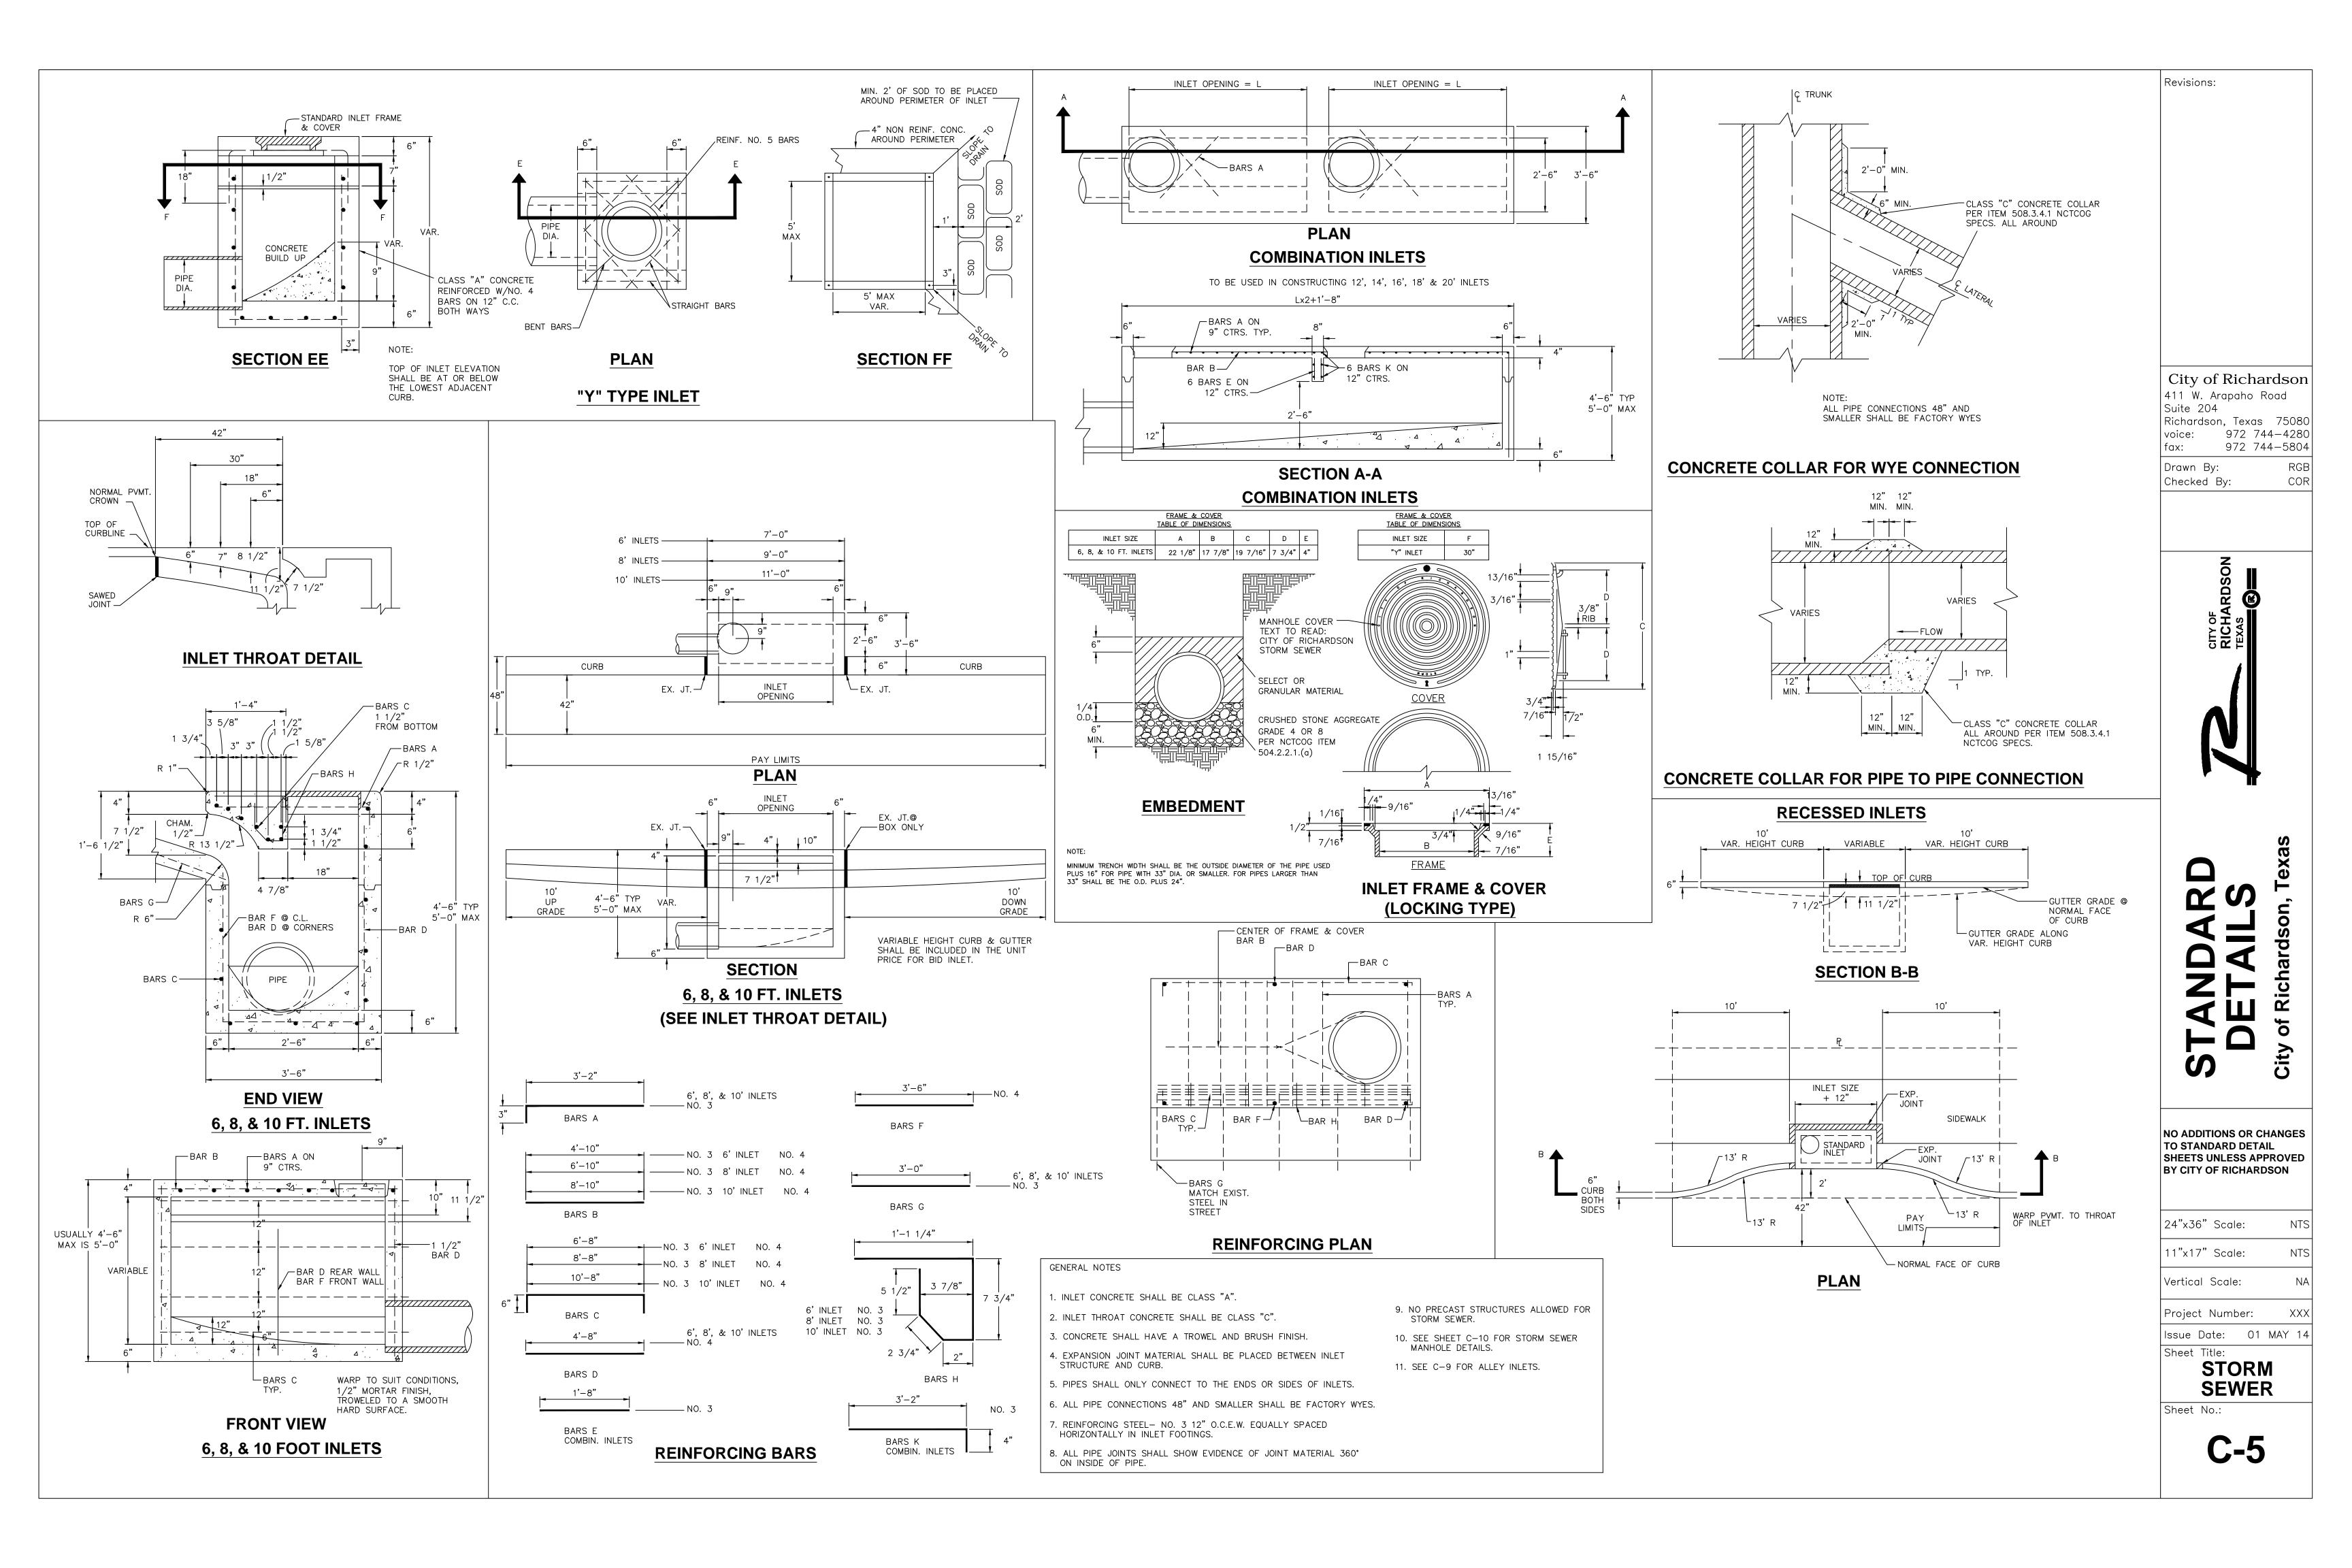
MANHOLE PIPE CONNECTORS GPK Manhole Couplings Ultra-Rib Manhole Sleeve Coupling CEMENT COUPLING WITH O-RING RUBBER GASKET FOR PIPE OTHER THAN CLAY OR CONC. ALT. COUPLINGS MUST BE APPROVED BY CONSTR. ENGR.

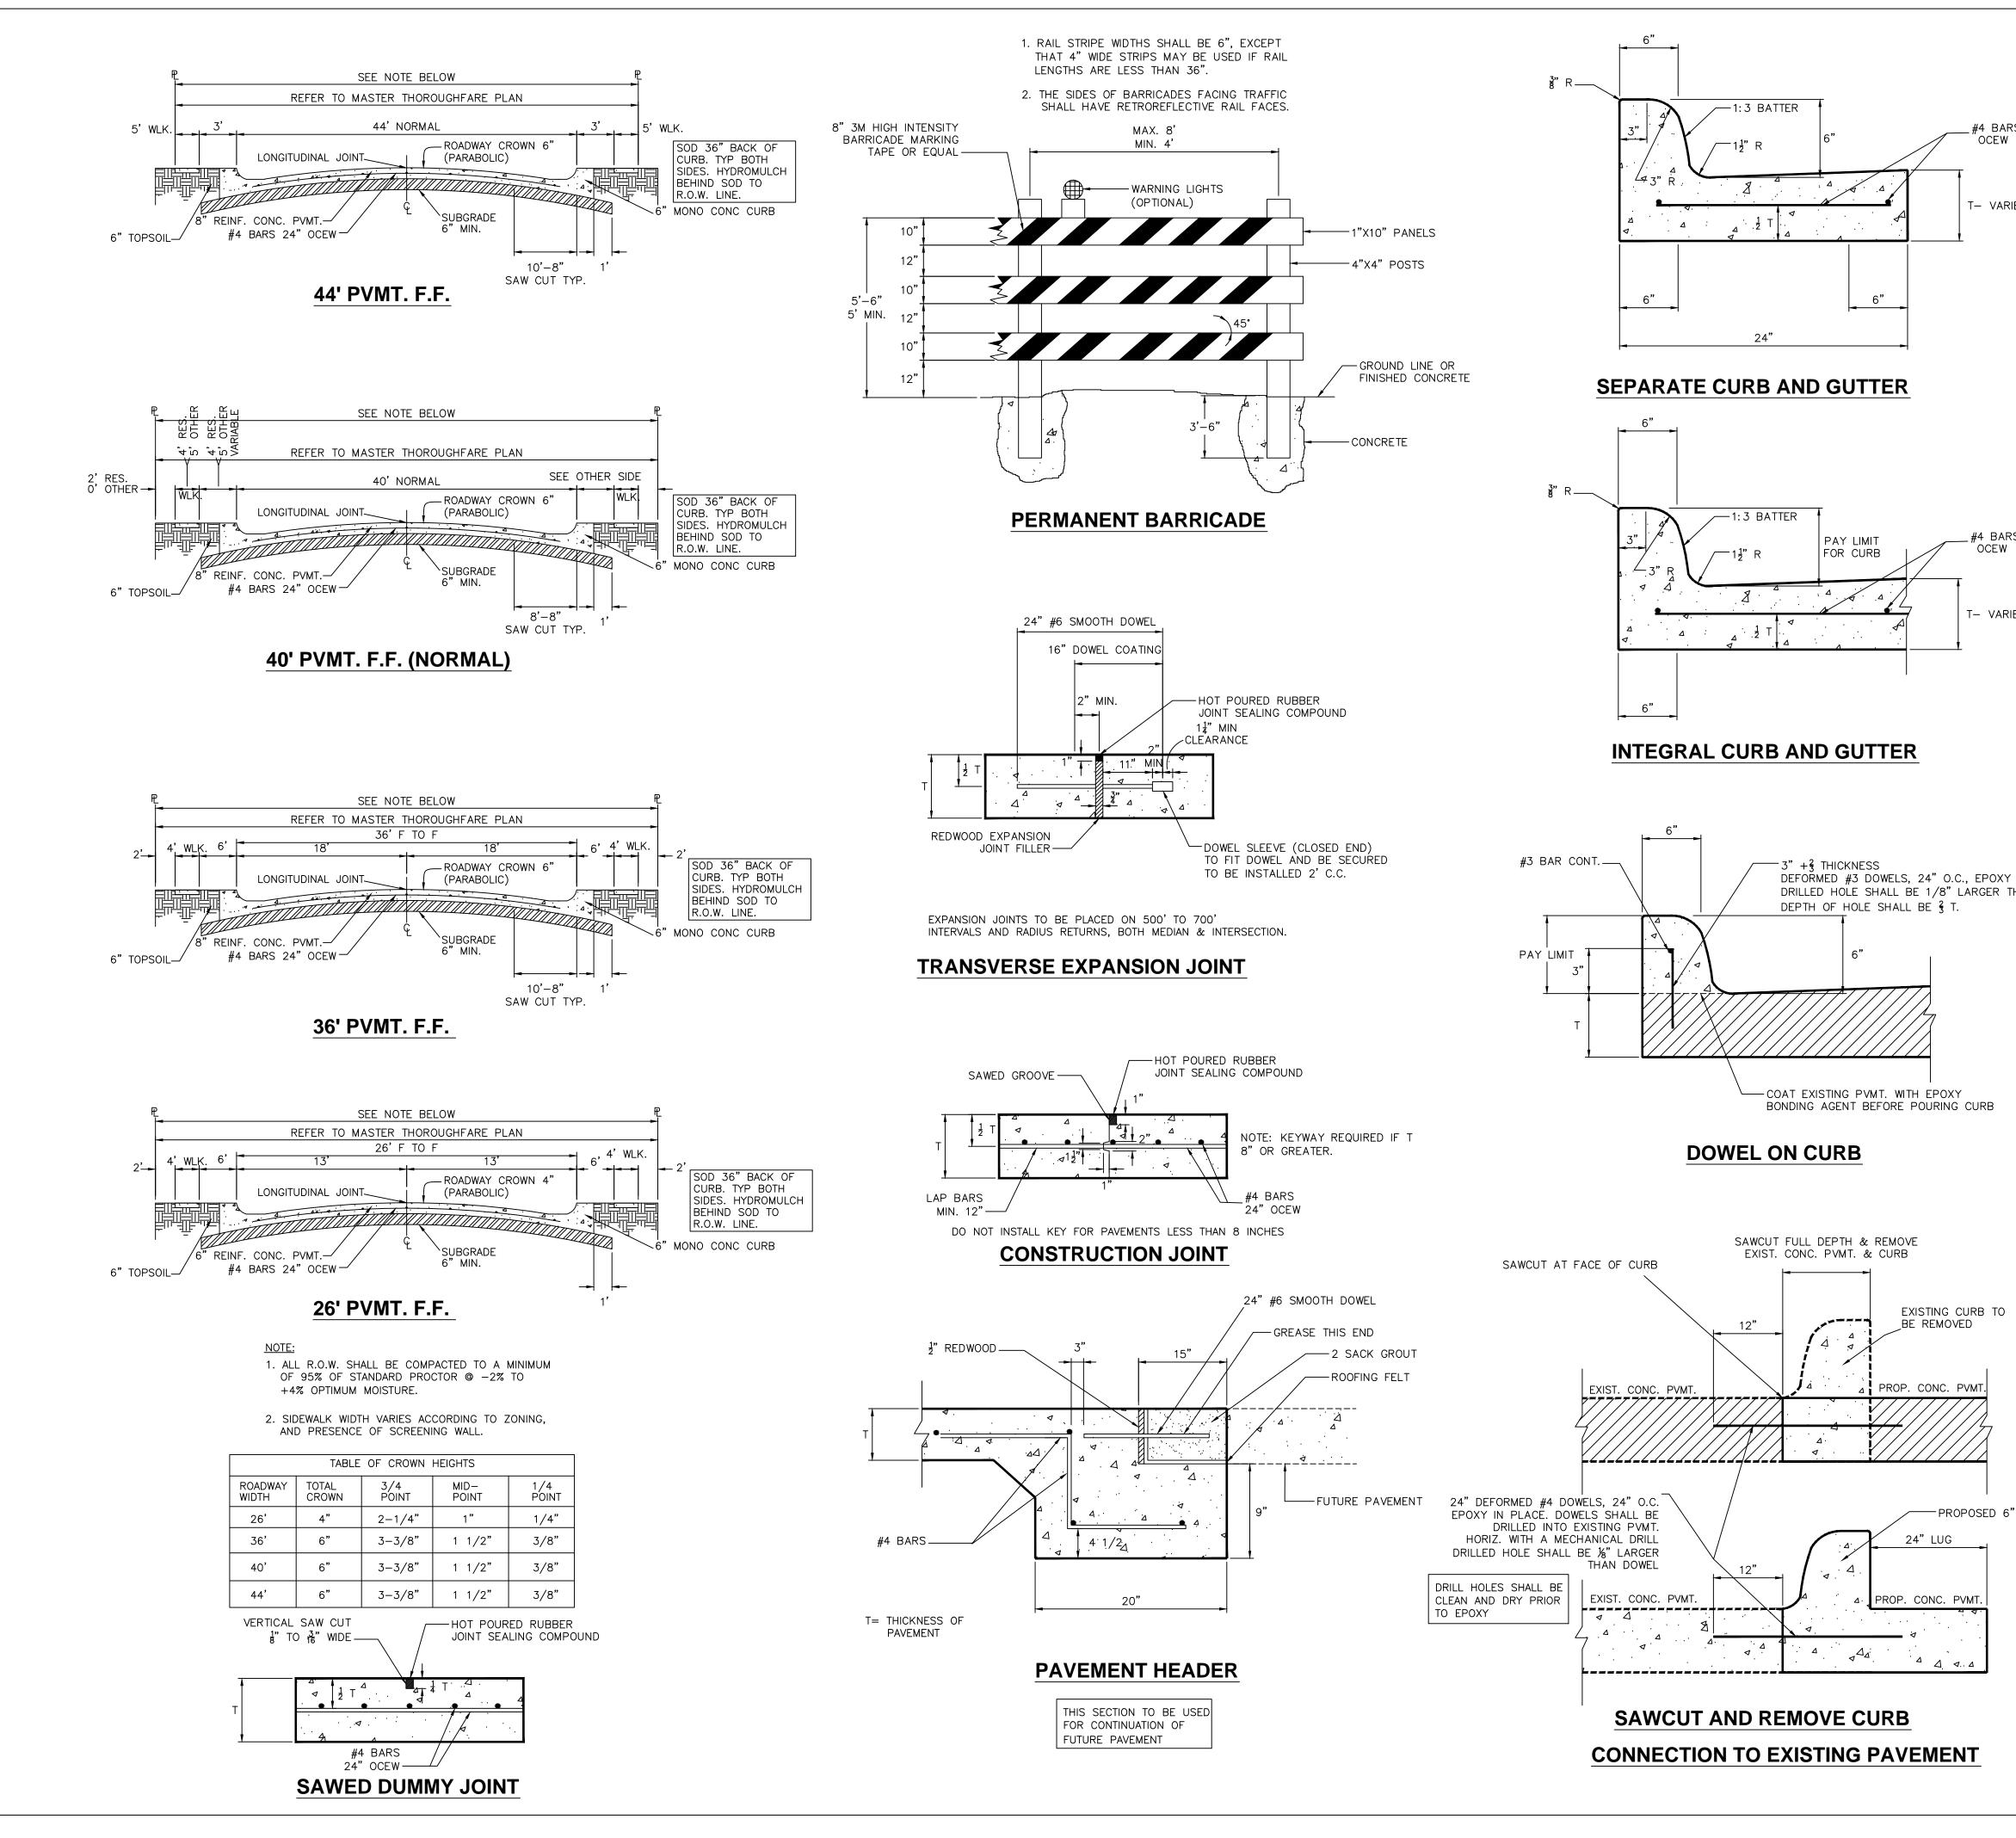




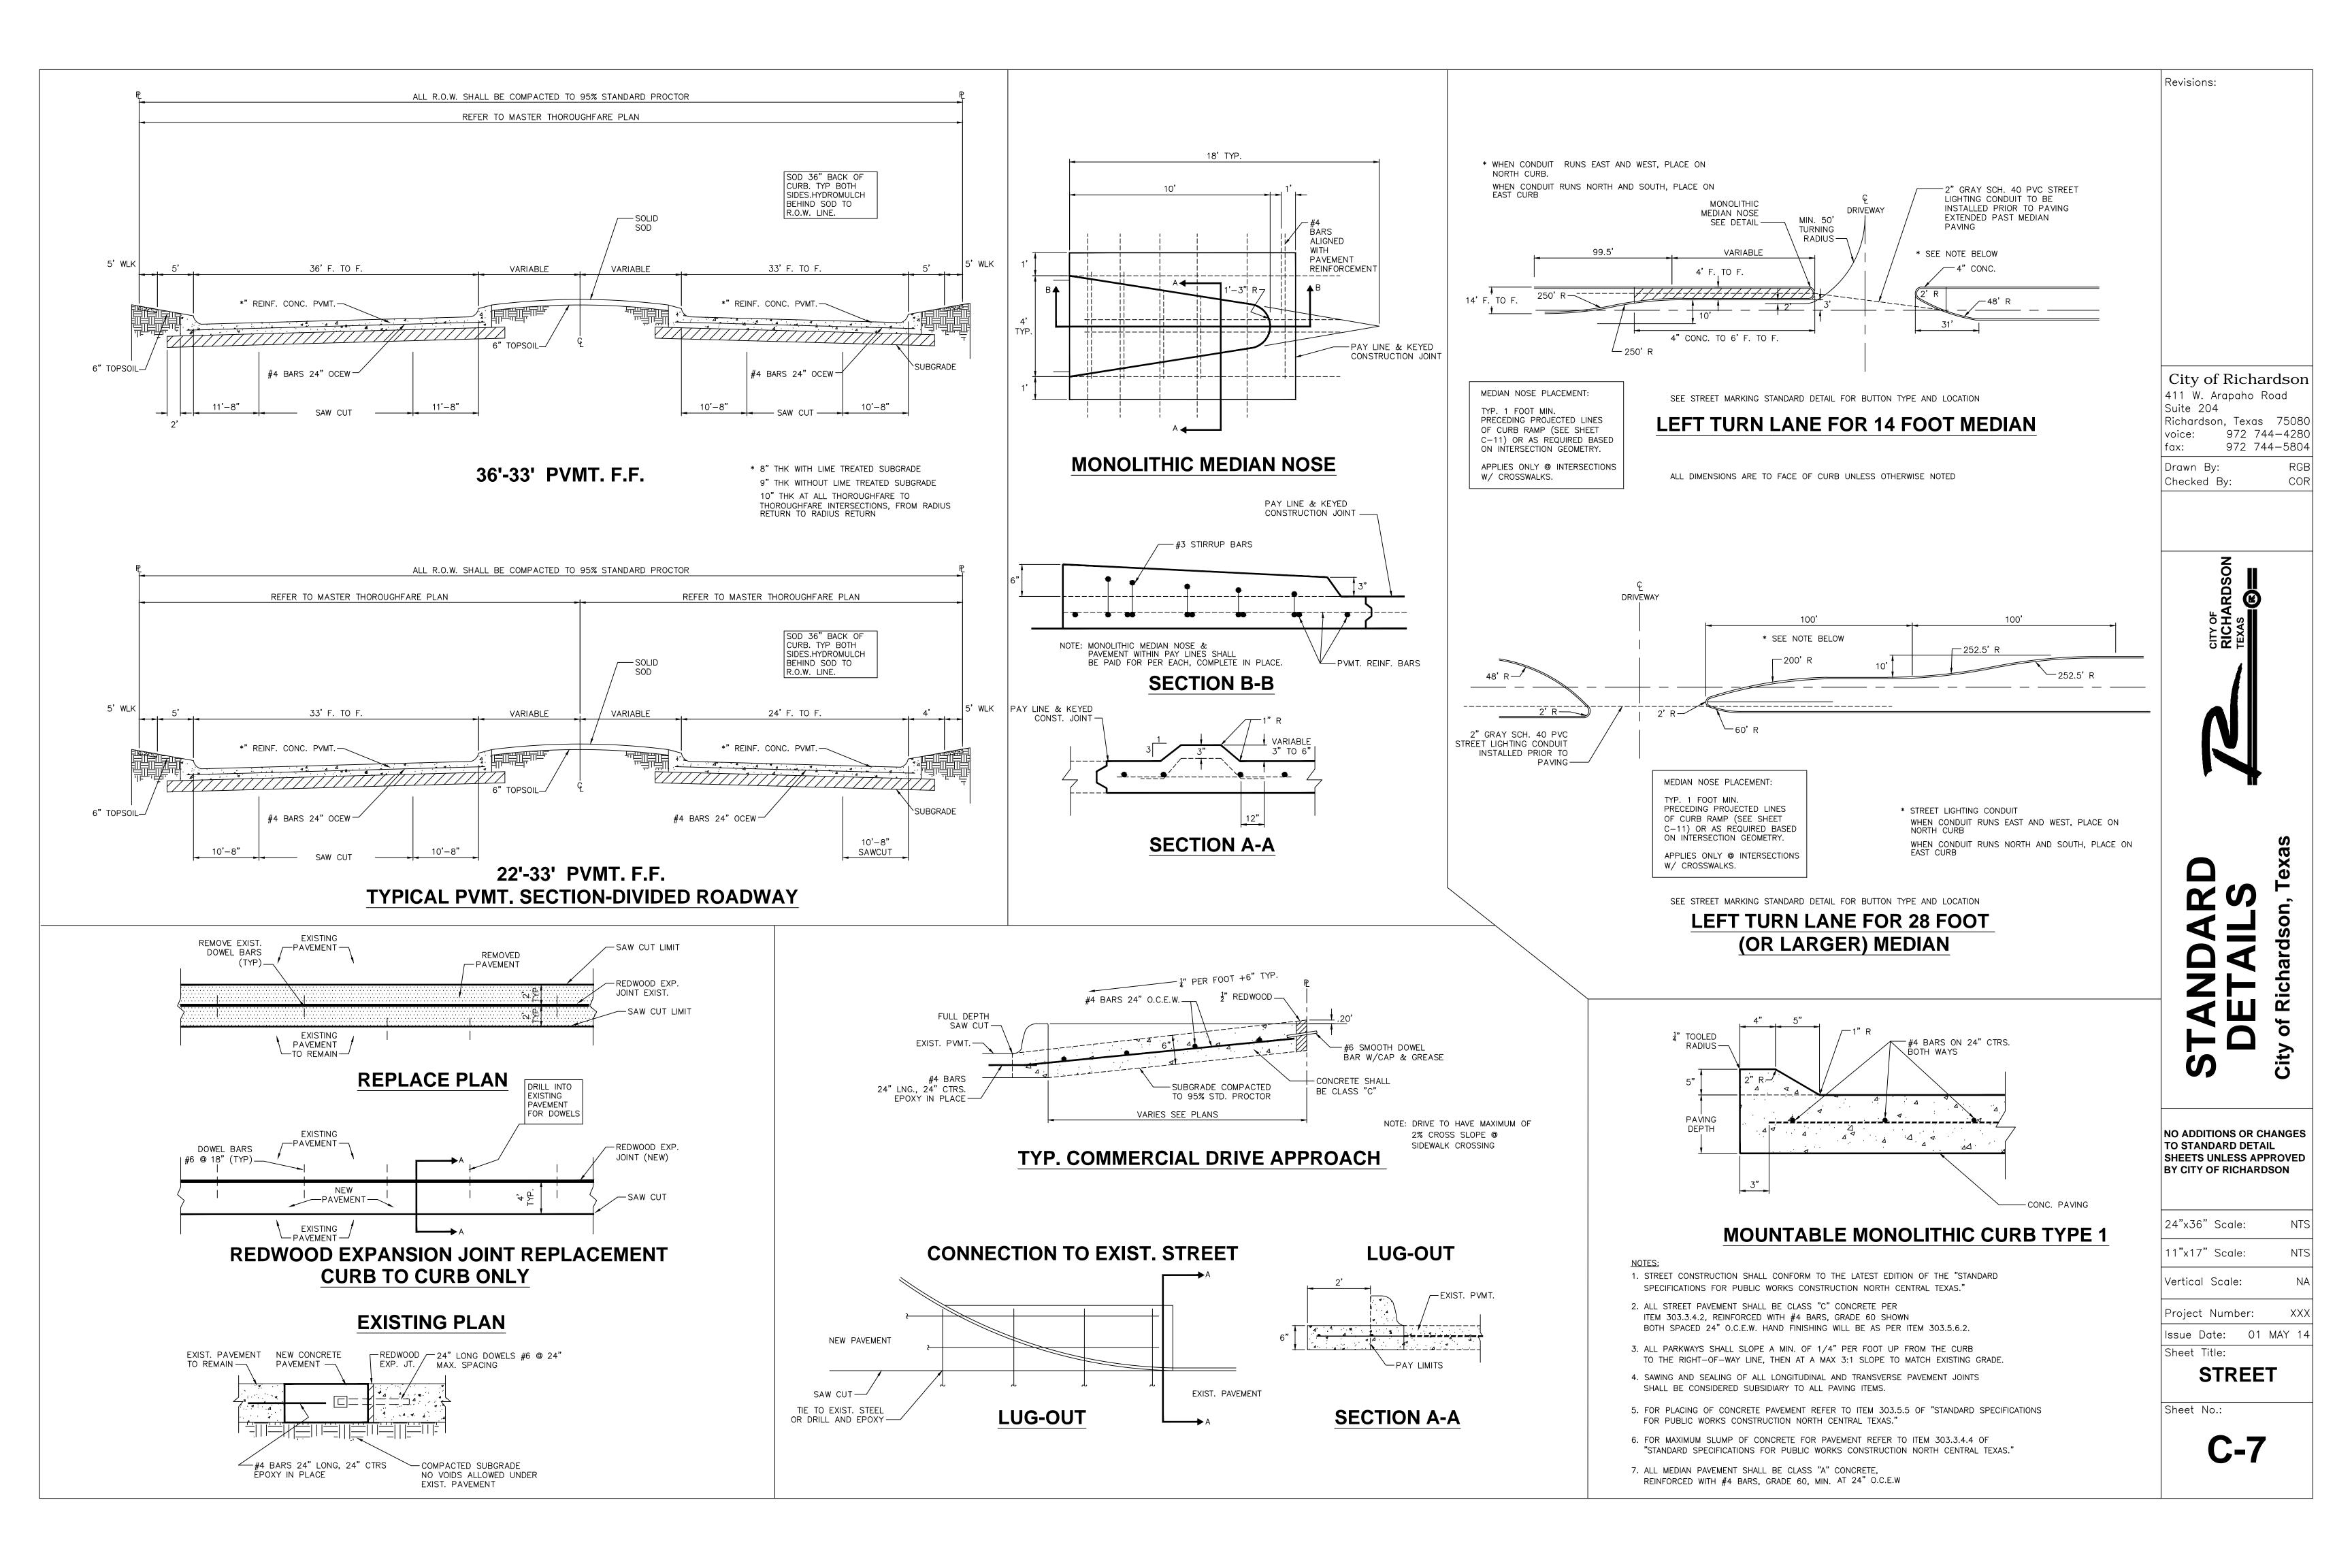
- Water Department Standards.
- items shall apply.
- minimum of 24 hours.
- 4. Gravity Pipe for Sewer Applications 4"-15" SDR-35 (Gravity) 4"-12" AWWA C-900-07-DR14 Green
- 5. All residential sewer services shall be 4" Minimum.

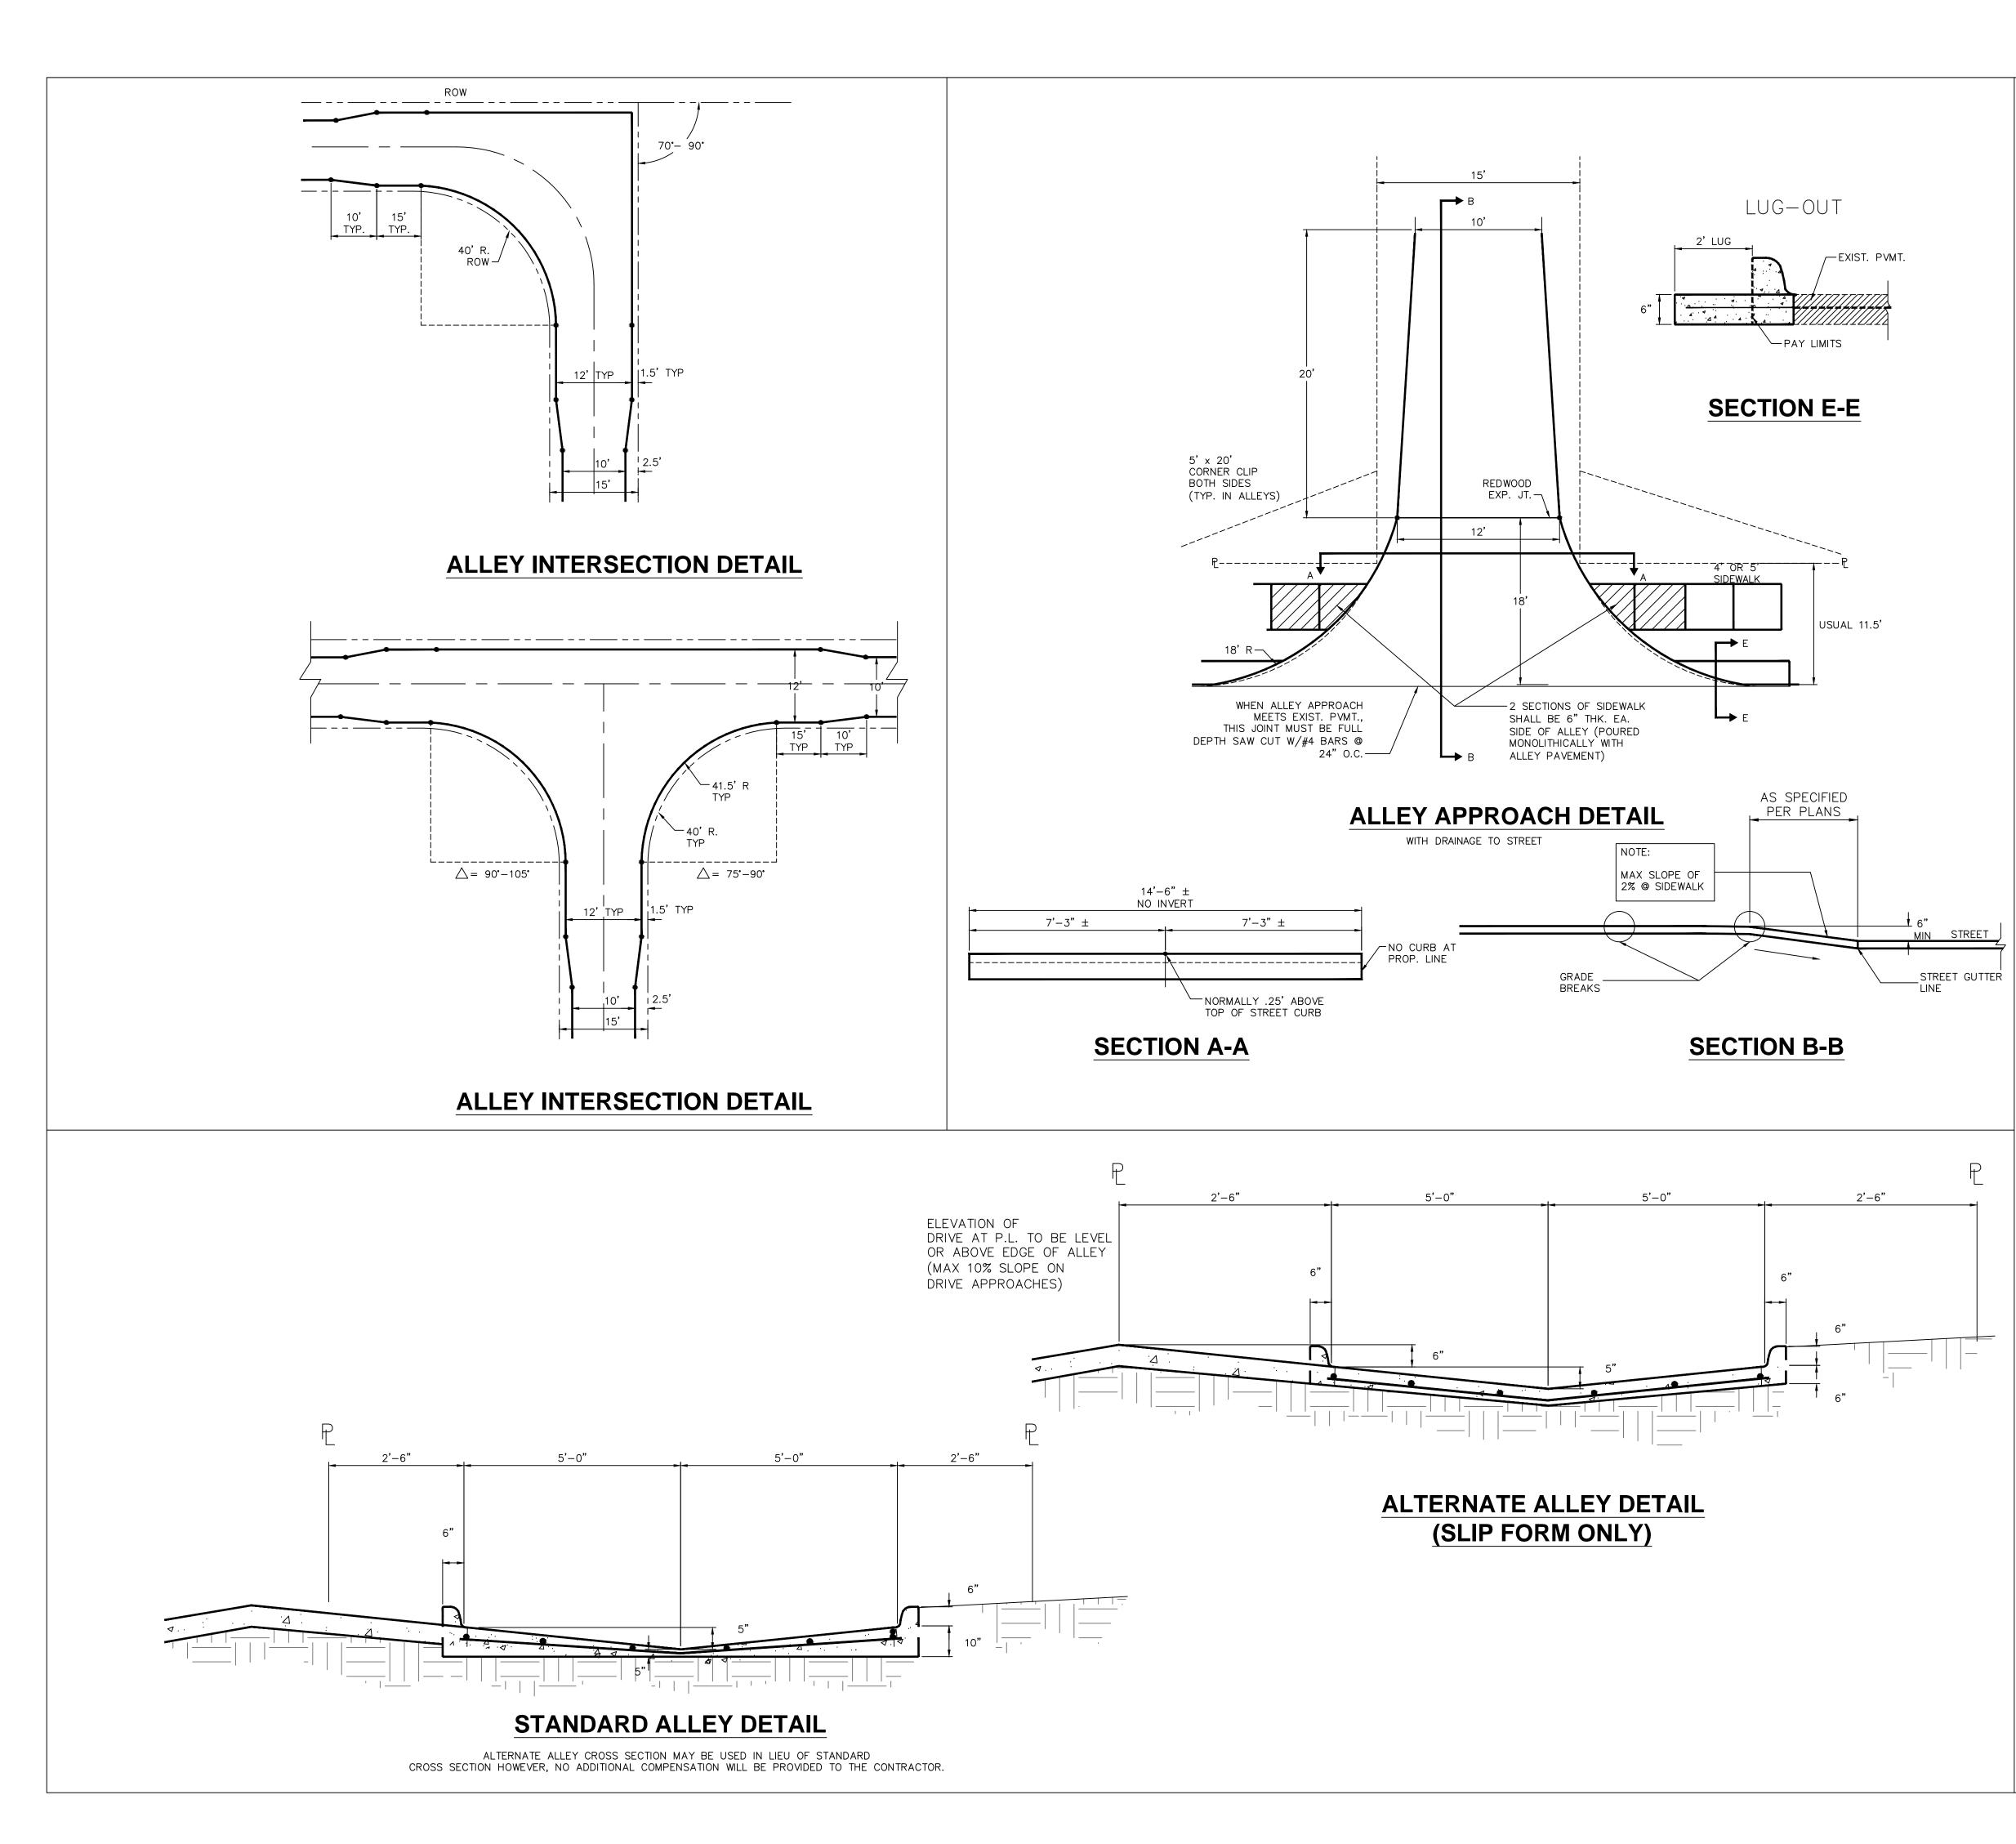
- A. "Allen Marking Tape" or equal.
 - C. Six (6) inches in width.
- 9. Free fall of concrete not to exceed 5 ft. MAX.





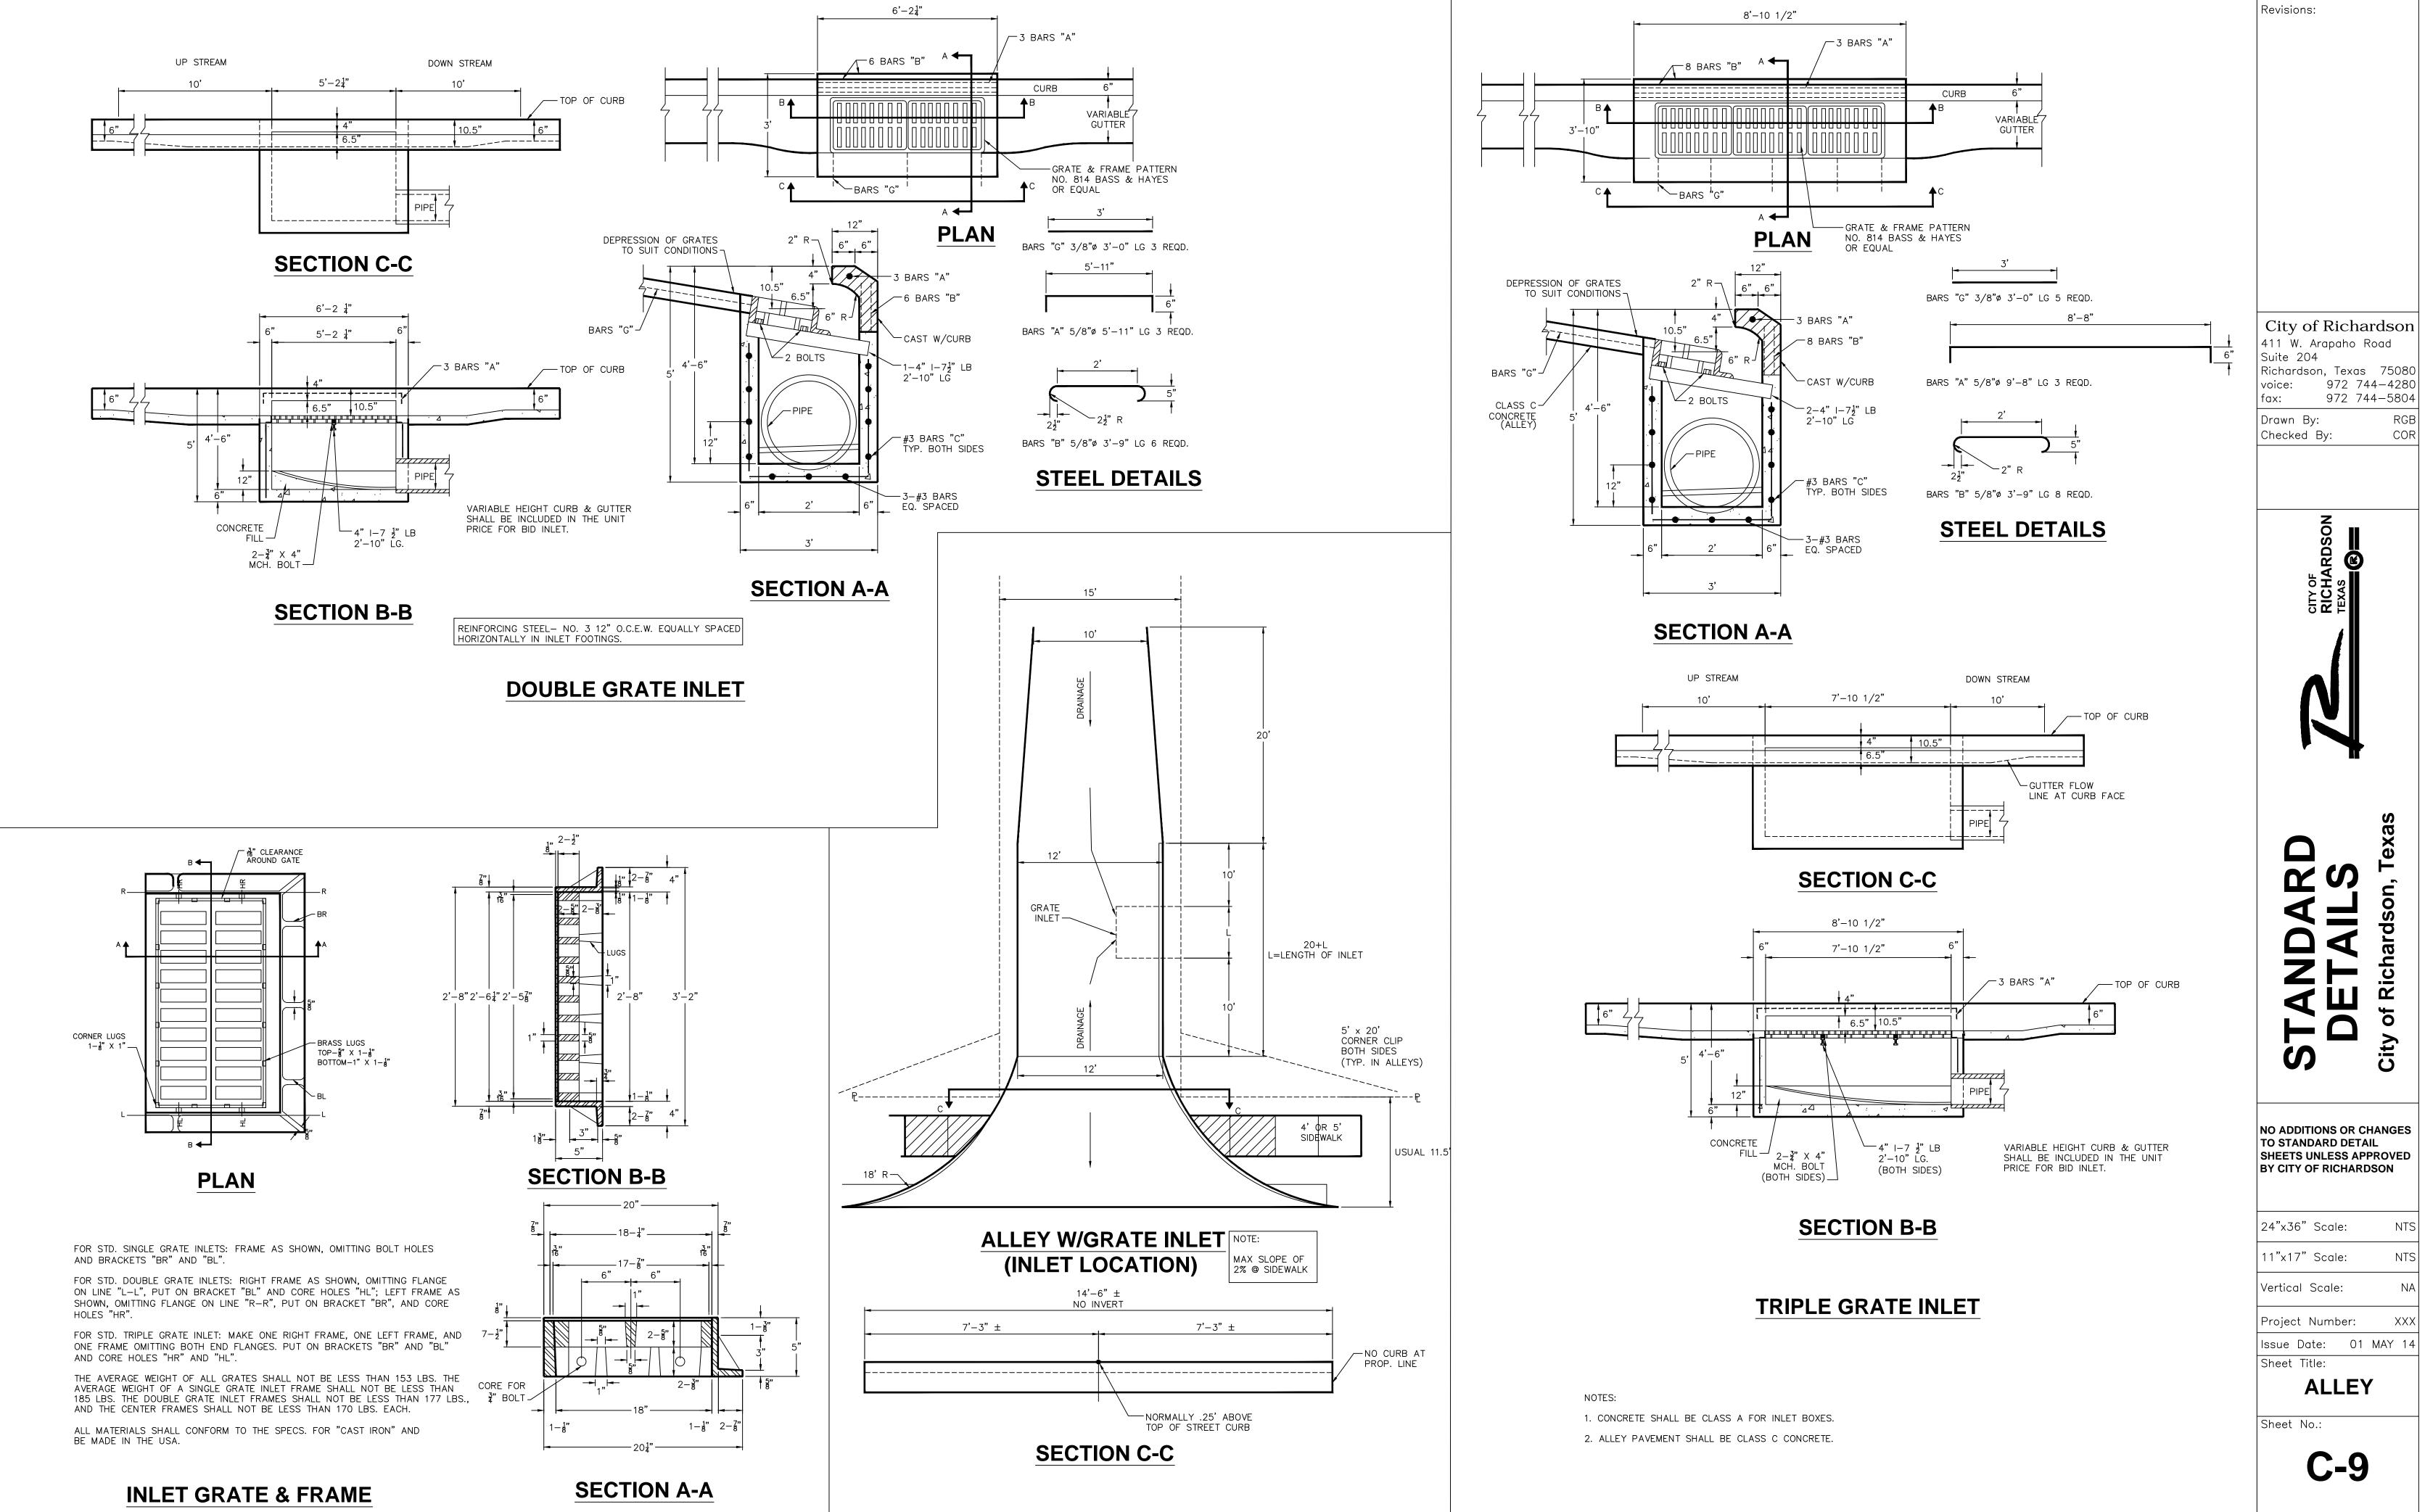
	NOTES: 1. STREET CONSTRUCTION SPECIFICATIONS FOR P	SHALL CONFORM TO TO			Revisions:	
	FOR THE DESIGN OF V 2. ALL STREET PAVEMENT	WATER AND SEWER LINE	S AND WATER DEPART CONCRETE PER	MENT STANDARDS.		
ARS W	BOTH SPACED 24" O.C	C.E.W. HAND FINISHING	WILL BE AS PER ITEM	303.5.6.2		
ARIES SEE PLANS	4. SAWING AND SEALING	Y LINE, THEN AT A MAX	K 3:1 SLOPE TO MATC AND TRANSVERSE PAVE	H EXISTING GRADE.		
	5. FOR PLACING OF CON		R TO ITEM 303.5.5 OF	"STANDARD SPECIFICATIONS		
	6. FOR MAXIMUM SLUMP "STANDARD SPECIFICAT	OF CONCRETE FOR PA				
	7. ALL NONRESIDENTIAL F REINFORCED WITH #4		MINIMUM OF 8" THICK	,		
	8. ALL COMMERCIAL AND BARS GRADE 60 SPAC		S SHALL BE CLASS "C	" CONCRETE WITH #4		
		NS ITEM 303.2.1.3 – IS DELETED AND REPL	ACED AS FOLLOWS	SHALL BE AMENDED	City of Richar 411 W. Arapaho Ro Suite 204	
	2. STANDARD SPECIFICATIO		E AMENDED AS FOLLO	NS:	Richardson, Texas voice: 972 744	
	B. ITEM 303.2.5 SHAL	ASH IS ALLOWED: MAX L BE DELETED. NO MIN L BE DELETED. NO FIB	IERAL FILLER IS ALLOW		fax: 972 744 Drawn By:	4-5804 RGB
ARS W	3. STANDARD SPECIFICATIO				Checked By:	COR
	OWNER PRIOR TO STAF	RTING THE PAVING OPER		HALL BE APPROVED BY THE IENT REQUIREMENTS ARE		
RIES SEE PLANS	NO PAVING MACHINE SHALL BE USED TO	E REQUIRED. STINGER V CONSOLIDATE THE COM		STRAIGHT EDGES	RDSON	
		WITH TWO HAND HELD	STINGER VIBRATORS SI	HALL BE USED TO		
	CONSOLIDATE THE C 3. <u>PARKING LOTS AND</u>	TURN LANES			CITY OF RICHAI TEXAS	
	CONSOLIDATE THE C		STINGER VIBRATORS SH	HALL BE USED TO		
	4. <u>NEW STREET AND A</u> SLIPFORM PAVING E SPECIFICATIONS SHA	QUIPMENT AS DESCRIBE	ED IN ITEM 303.4.3 OF	THE STANDARD		
	5. <u>STREET AND ALLEY</u> PAVING EQUIPMENT	<u>REPAIRS</u> WILL BE DETERMINED E	BY THE OWNER.			
(Y IN PLACE THAN DOWEL	6. <u>FULL WIDTH ALLEY</u> VIBRATING SCREED CONSOLIDATE THE C	WITH TWO HAND HELD	STINGER VIBRATORS SI	HALL BE USED TO		
	B. CONCRETE FINISH NEW PAVEMENT: STR	EET AND ALLEY PAVEME	NT SHALL BE TEXTURI	ED WITH A		
	NYLON BAKER BROOI DRAG BROOM LONGIT	M THAT IS CLEAN AND	FREE OF GROUT BUILI AVEMENT AFTER BLEED	DUP. WATER HAS EVAPORATED		exas
		ALL BE TEXTURED WITH LL BE PER ITEM 303.5		H A LIGHT BROOM FINISH.	ရှိလ	n, Te
		STREET AND ALLEY PA BROOM OR A BURLAP E		XTURED LONGITUDINALLY		rdso
	2. CONCRETE TEMPERA		MENT SHALL NOT EXC			of Richardson
	90°F OR ABOVE	AGITATED CONCRETE (32.2°C)	45 MINUTES		່. ເວ	City
C	75°F TO 89°F 35°F TO 74°F	(23.9° TO 31.6°C) (1.6° TO 23.3°C)	60 MINUTES 90 MINUTES			•
		N AGITATED CONCRETE			NO ADDITIONS OR CH	
	80°F OR ABOVE 35°F TO 79°F	(26.6°C) (1.6° TO 26.1°C)	15 MINUTES 30 MINUTES		SHEETS UNLESS APP BY CITY OF RICHARDS	ROVED
	OCTOBER 1 THROUGH	· · ·	JU MINULES			
	1. CONCRETE TEMPERA	TURE PRIOR TO PLACE (FROM ADDITION OF IN		EED 95°F, (35°C).	24"x36" Scale:	NTS
6" CURB W/LUG		AGITATED CONCRETE			11"x17" Scale:	NTS
	90°F OR ABOVE 75°F TO 89°F	(32.2°C) (23.9° TO 31.6°C)	45 MINUTES 60 MINUTES		Vertical Scale:	NA
	35°F TO 74°F	(1.6° TO 23.3°C)			Project Number:	XXX
	80°F OR ABOVE	N AGITATED CONCRETE (26.6°C) (1.6° TO 26.1°C)			Issue Date: 01 I Sheet Title: STREE	
					SINCE Sheet No.:	•
					C-6	

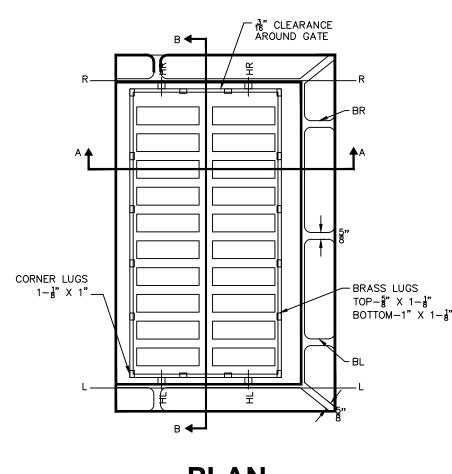




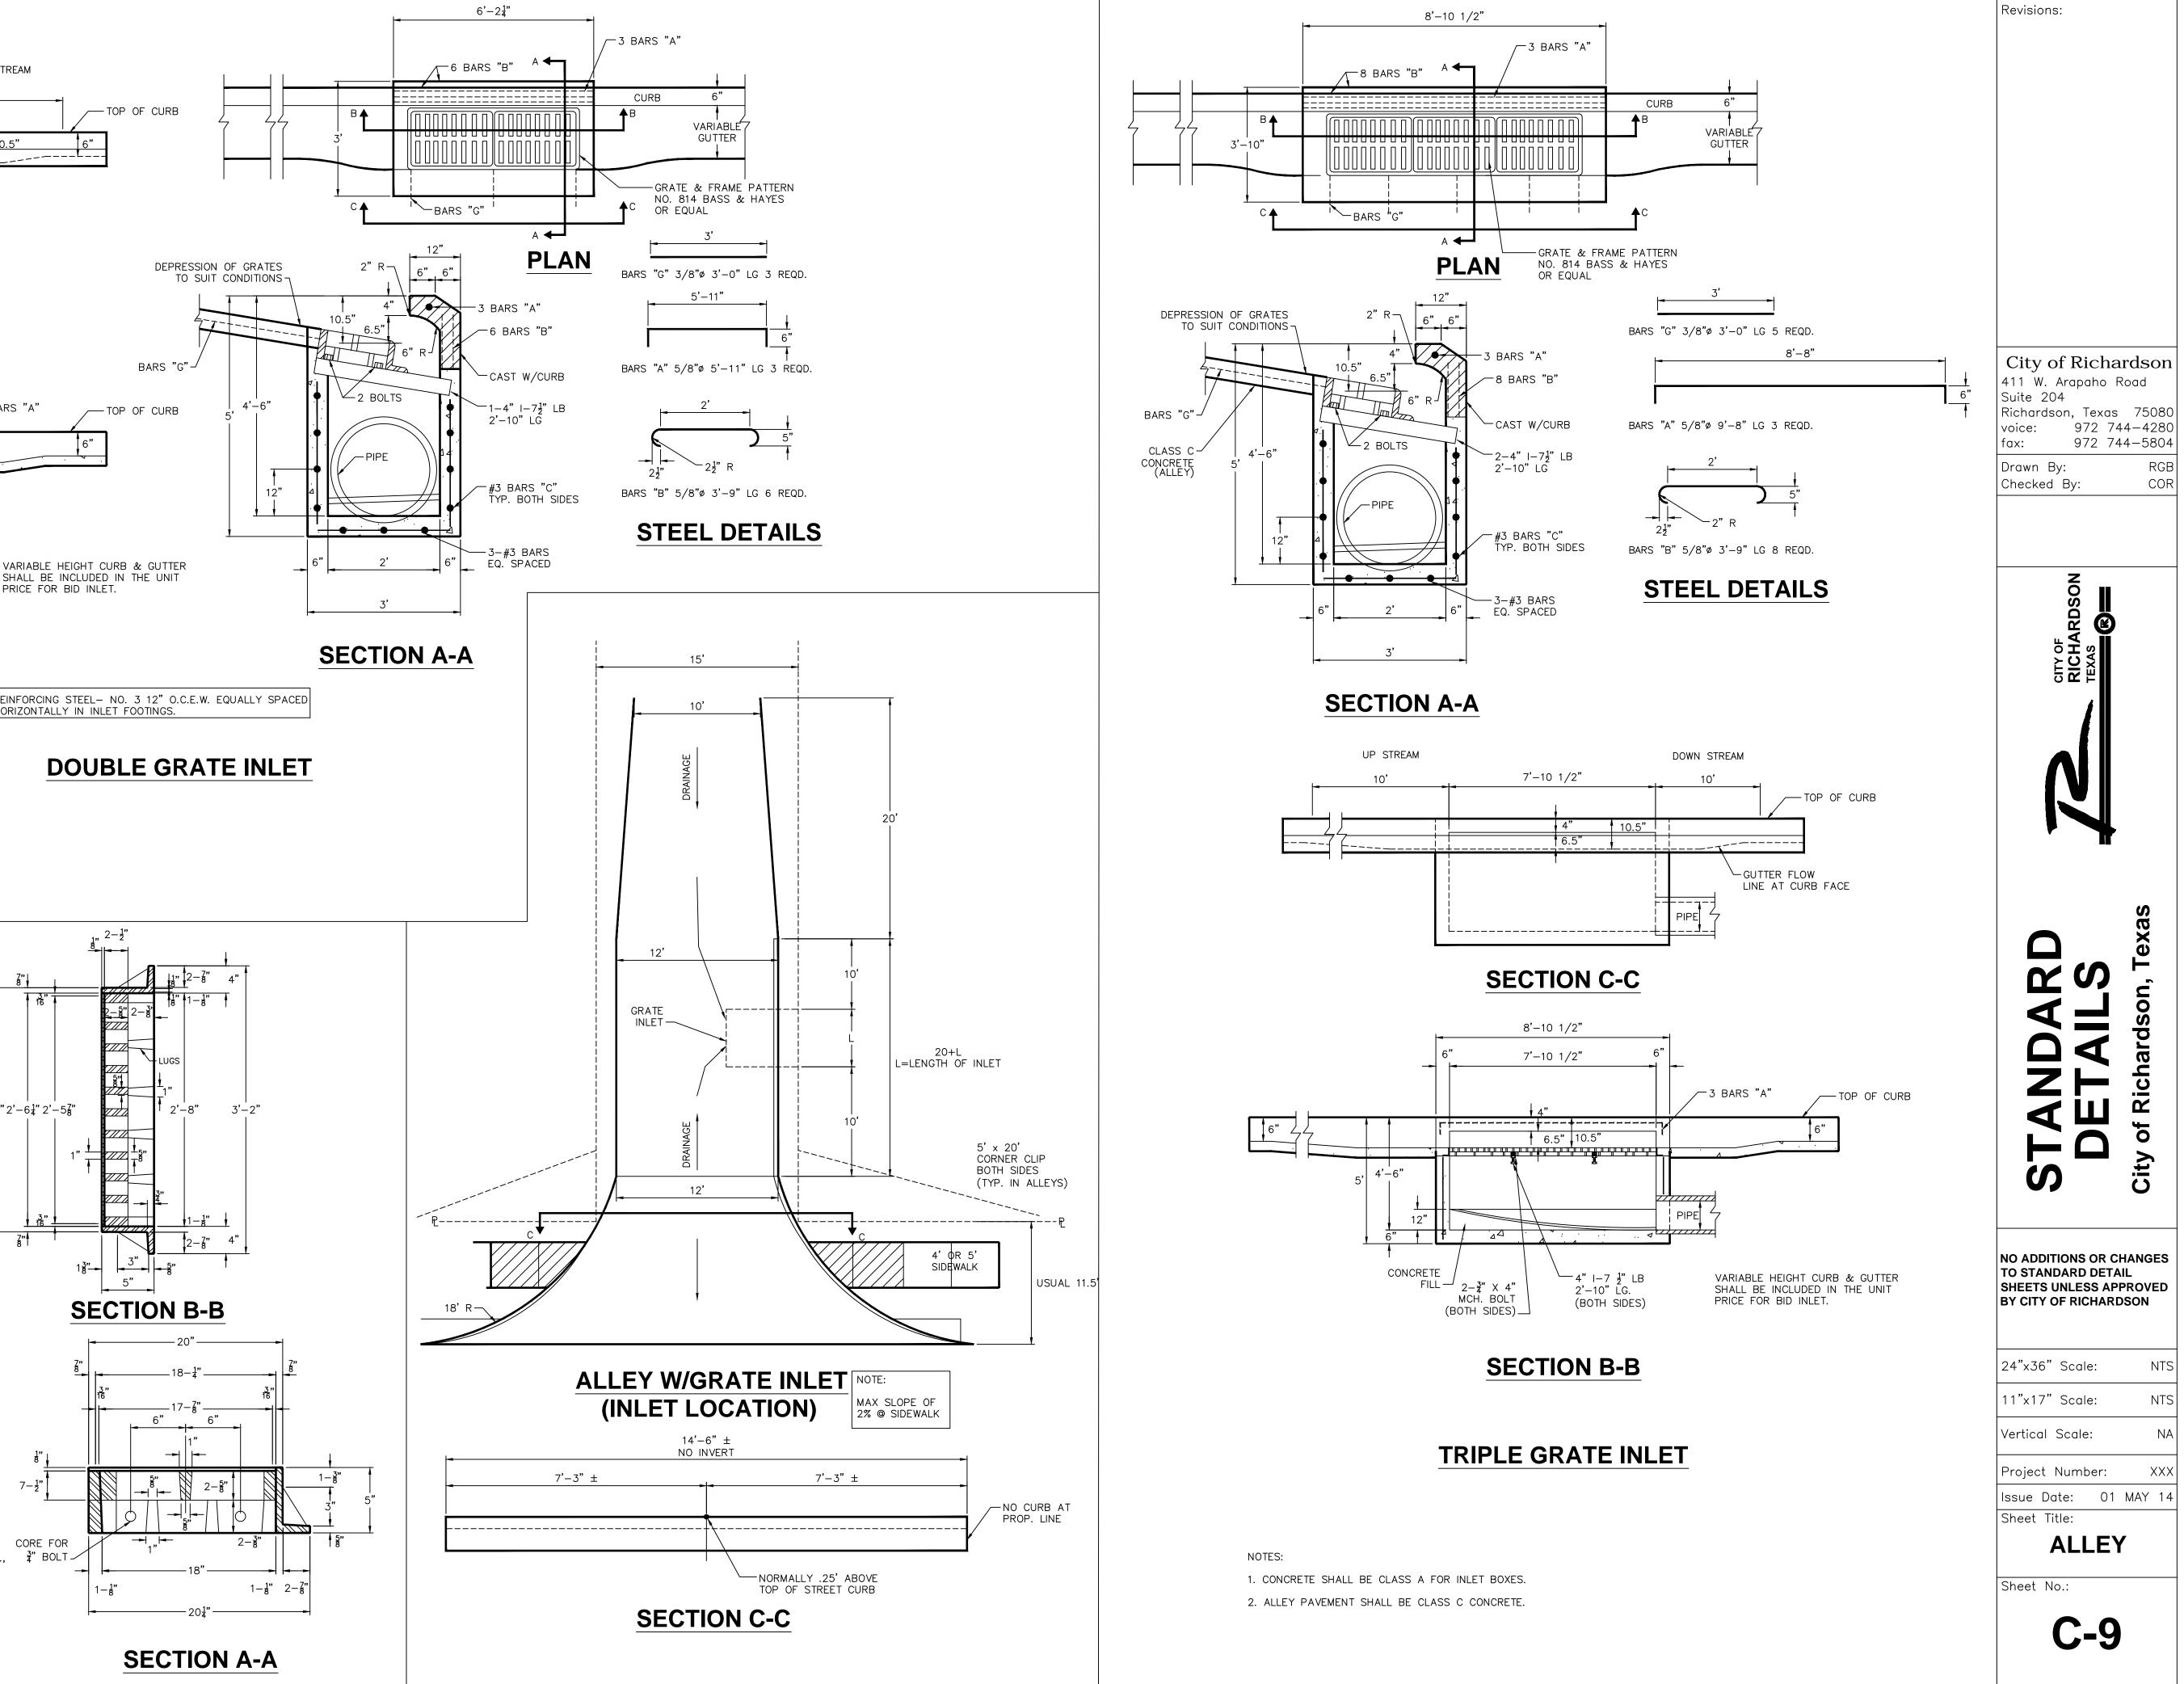
			Revisions:
NOTES			
		EST EDITION OF THE "STANDARD DN NORTH CENTRAL TEXAS."	
		DE 60 SPACED 24" O.C.E.W.	
3. ALL JOINTS, SAWING AM		IAL AND TRANSVERSE PAVEMENT JOINTS	
4. FOR PLACING OF CONC	RETE PAVEMENT REFER TO) ITEM 303.5.5.	
5. FOR MAXIMUM SLUMP	OF CONCRETE FOR PAVEME	ENT REFER TO ITEM 303.4.4.	
		IN LIEU OF STANDARD ALLEY CROSS SECTION E PROVIDED TO THE CONTRACTOR.	
 SEE SHEET C-6 FOR INLETS SHALL NOT BE 		SITIONS	City of Richardson
			411 W. Arapaho Road Suite 204
PORTLAND CEMENT CONCE 1. STANDARD SPECIFICATIO		RSE AGGREGATES' SHALL BE AMENDED	Richardson, Texas 75080 voice: 972 744-4280
	IS DELETED AND REPLACE S SHALL BE 100% CRUSH		fax: 972 744-5804
2. STANDARD SPECIFICATIO			Drawn By: RGB
A. ITEM 303.2.4. FLY /	ASH IS ALLOWED MAX 20%	BY WEIGHT	Checked By: COR
	BE DELETED. NO MINERA BE DELETED. NO FIBROU	L FILLER IS ALLOWED S REINFORCEMENT ALLOWED	
3. STANDARD SPECIFICATIO	NS ITEM 303 SHALL BE AI	MENDED TO INCLUDE THE FOLLOWING:	
A. ALL EQUIPMENT NECES	SARY TO CONSTRUCT CONC	CRETE PAVEMENT SHALL BE APPROVED BY THE	
OWNER PRIOR TO STAR AS FOLLOWS:	TING THE PAVING OPERATION	DN. PAVING EQUIPMENT REQUIREMENTS ARE	CITY OF RICHARDSON TEXAS
1. <u>NEW STREET AND A</u>			
SLIPFORM PAVING EC SPECIFICATIONS SHA		N ITEM 303.4.3 OF THE STANDARD	CHA CHA
2. <u>STREET AND ALLEY</u>			
3. <u>FULL WIDTH ALLEY</u>	WILL BE DETERMINED BY T	HE OWNER.	1
	VITH TWO HAND HELD STIN	GER VIBRATORS SHALL BE USED TO	
B. CONCRETE FINISH			
	ET AND ALLEY PAVEMENT S THAT IS CLEAN AND FREE	HALL BE TEXTURED WITH A	
		ENT AFTER BLEED WATER HAS EVAPORATED	
(CONCRETE WILL APPE	AR DULL) BUT BEFORE CC	NCRETE HAS ATTAINED ITS INITIAL SET.	
C. CONCRETE TEMPERATUR	RES		
MAY 1 THROUGH SEP	TEMBER 30 MIX DESIGNS SHALL INCLU		
		MENT SHALL NOT EXCEED 95°F, (35°C).	as
3. THE TIME INTER'	VAL (FROM ADDITION OF IN	IITIAL WATER):	
90°F OR ABOVE	AGITATED_CONCRETE (32.2°C)	45 MINUTES	
75°F TO 89°F	(23.9° TO 31.6°C)		
35°F TO 74°F	(1.6° TO 23.3°C)	90 MINUTES	
	NON AGITATED CONCRETE		
80°F OR ABOVE	(26.6°C)	15 MINUTES	
35°F TO 79°F	(1.6° TO 26.1°C)	30 MINUTES	
OCTOBER 1 THROUGH	APRIL 30		ЧШ≝
		MENT SHALL NOT EXCEED 95°F, (35°C).	FANDA DETAIL of Richardso
2. THE TIME INTER	VAL (FROM ADDITION OF IN	IITIAL WATER):	
	AGITATED CONCRETE		U Ü
90°F OR ABOVE 75°F TO 89°F	(32.2°C) (23.9° TO 31.6°C)	45 MINUTES 60 MINUTES	
35°F TO 74°F	(1.6° TO 23.3°C)	90 MINUTES	
	NON AGITATED CONCRETE		NO ADDITIONS OR CHANGES
80°F OR ABOVE	(26.6°C)	15 MINUTES	TO STANDARD DETAIL SHEETS UNLESS APPROVED
35°F TO 79°F	(1.6° TO 26.1°C)	30 MINUTES	BY CITY OF RICHARDSON
			24"x36" Scale: NTS
			11"x17" Scale: NTS
			Vertical Scale: NA
			Project Number: XXX
			Issue Date: 01 MAY 14
			Sheet Title:
			ALLEY
			Sheet No.:

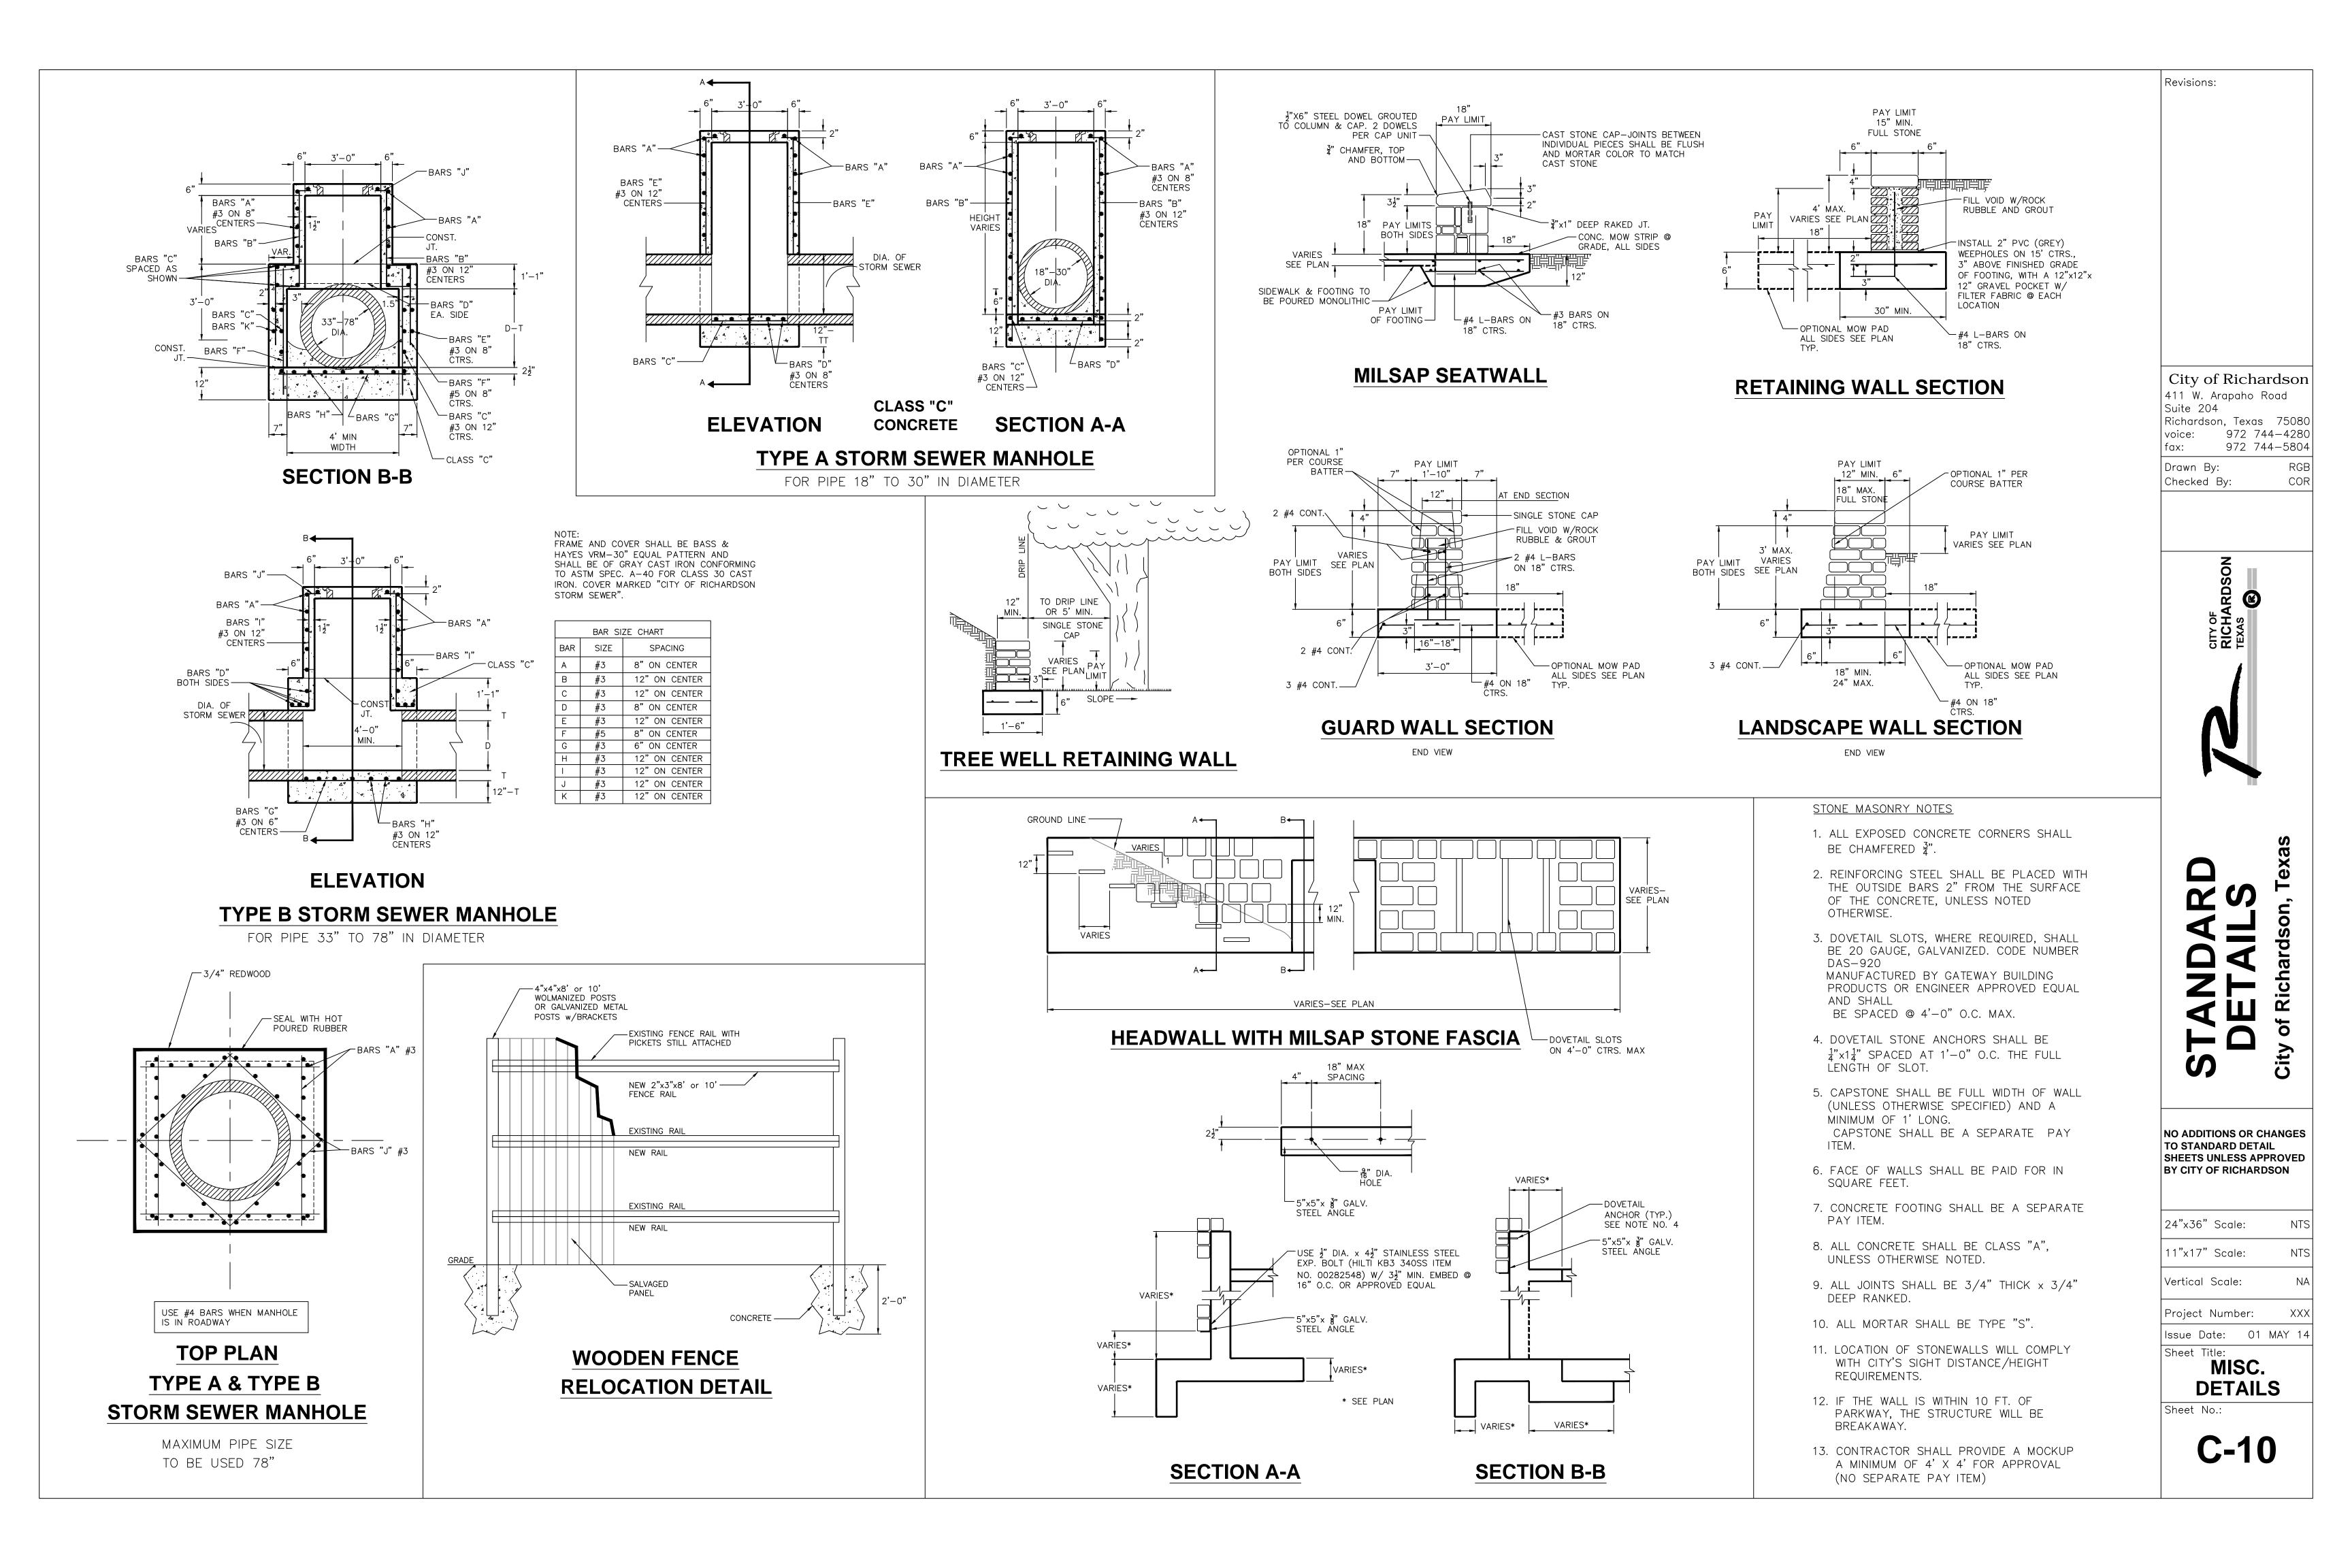
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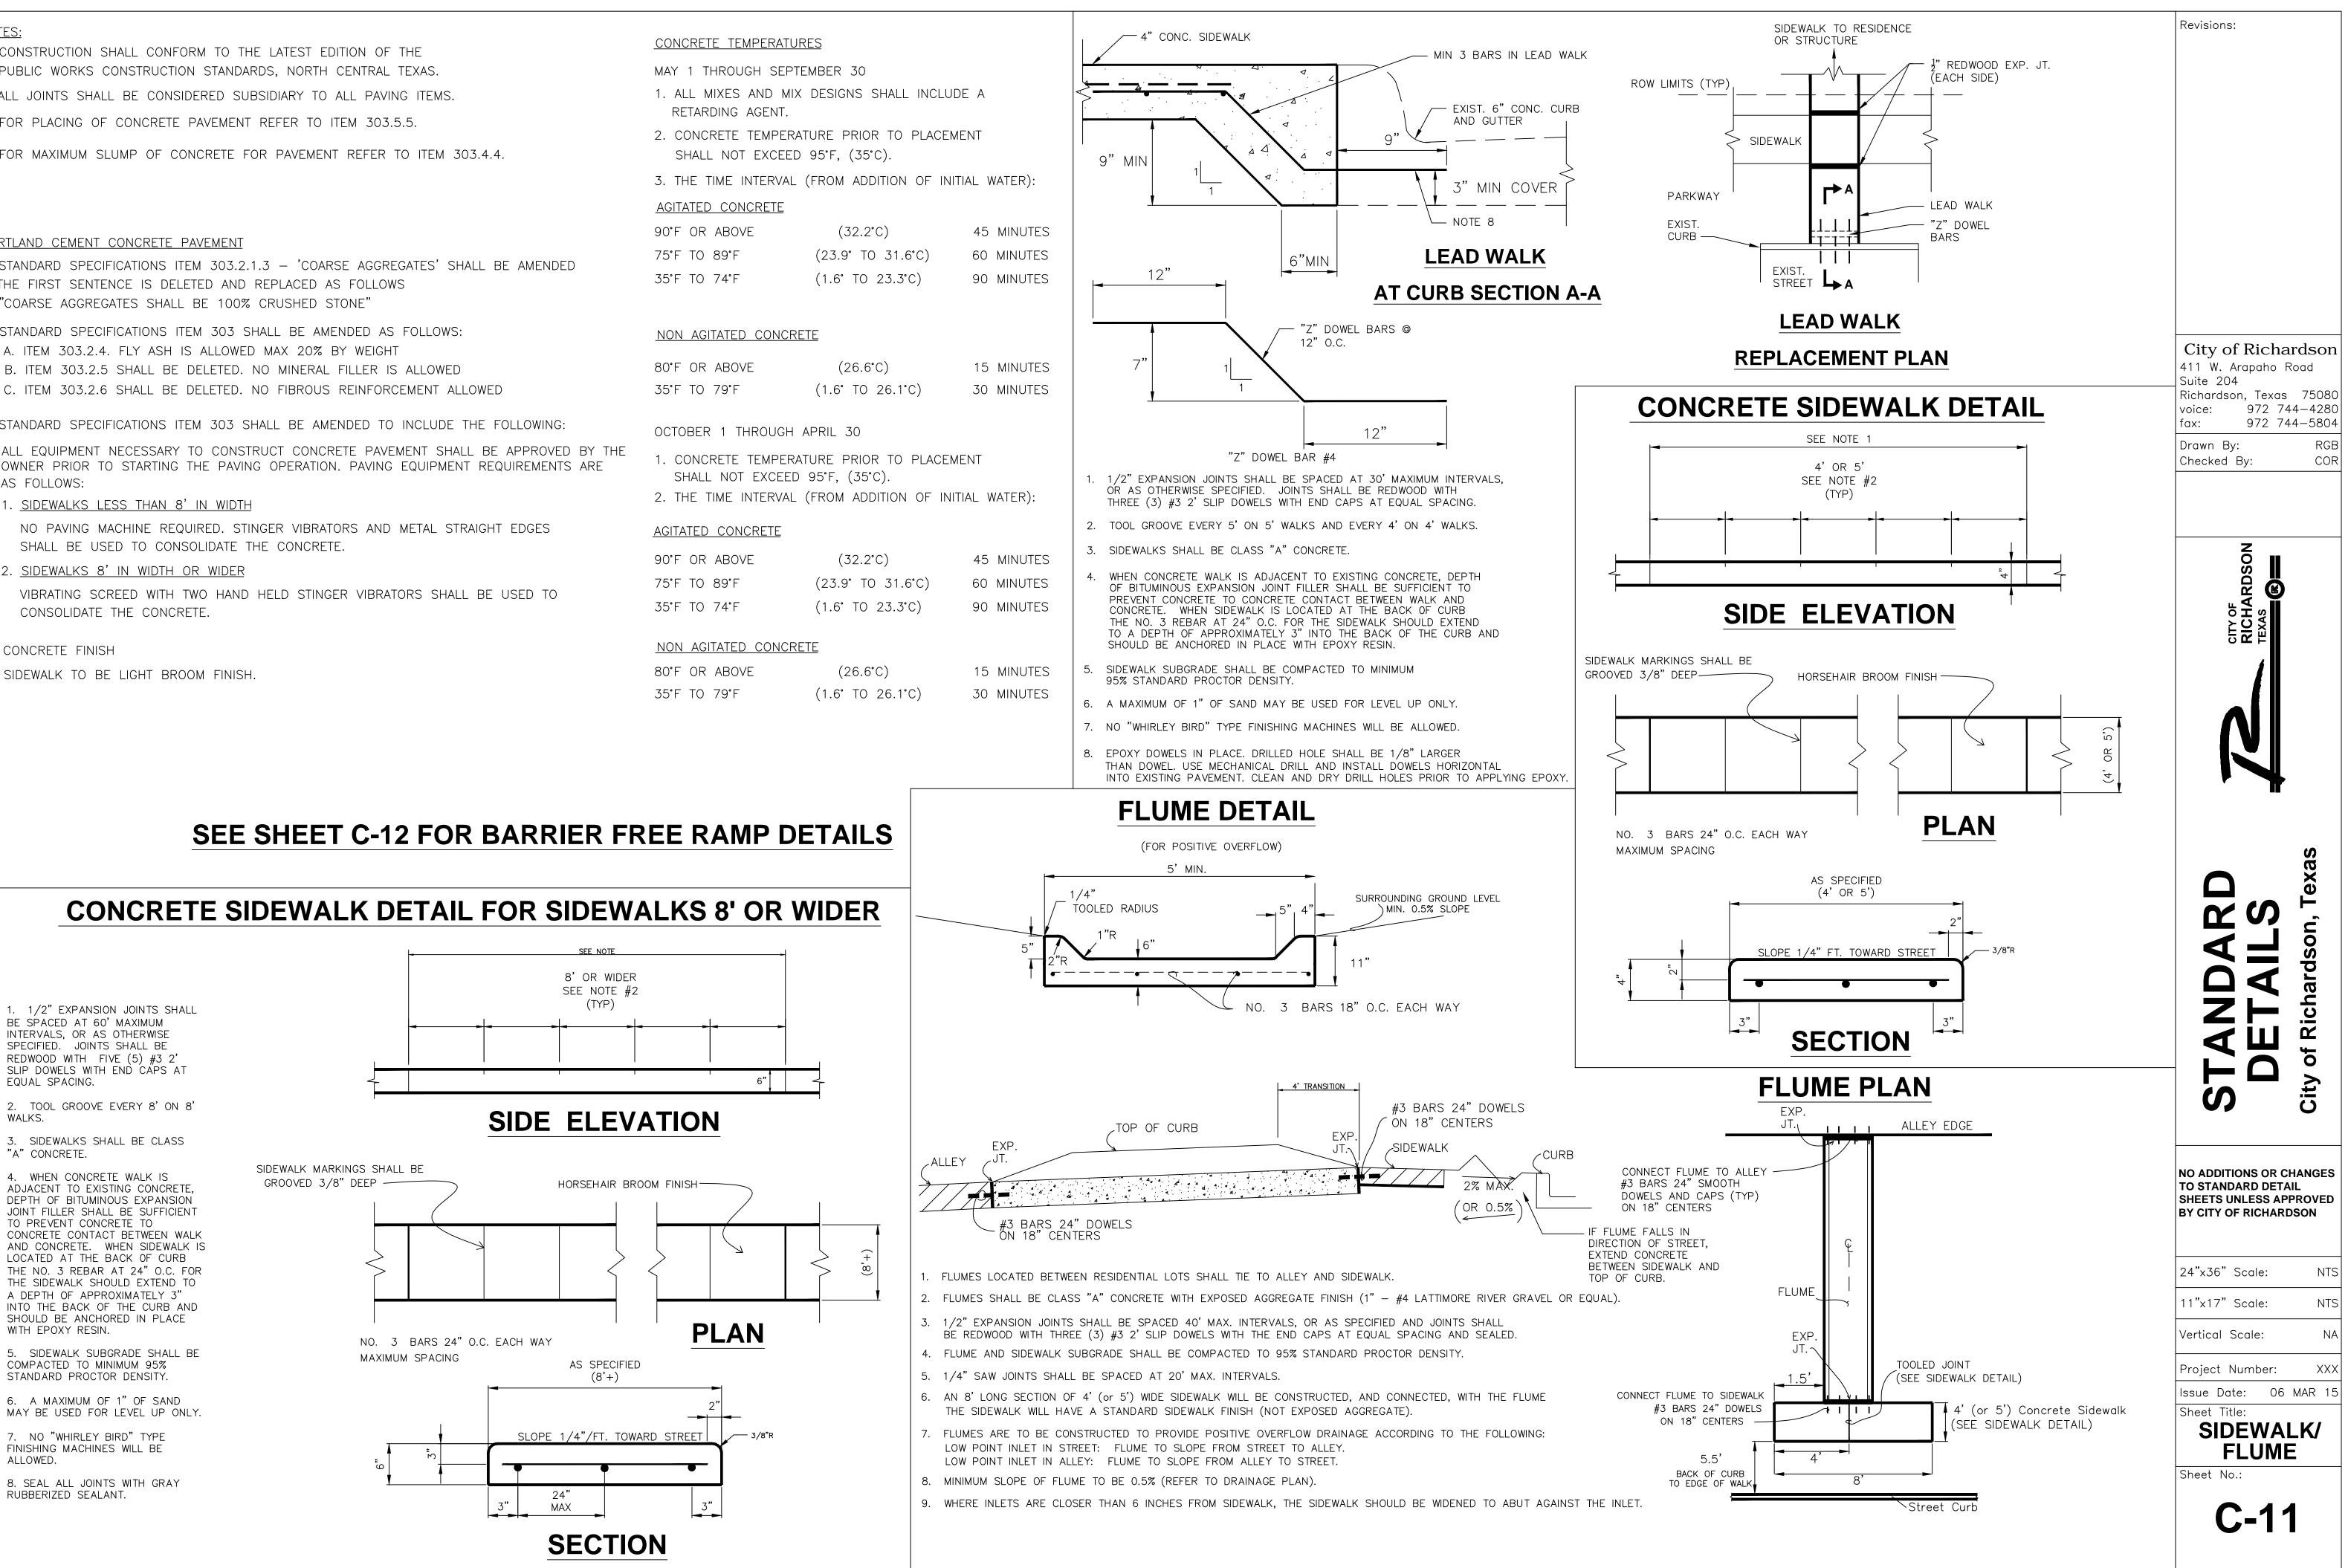


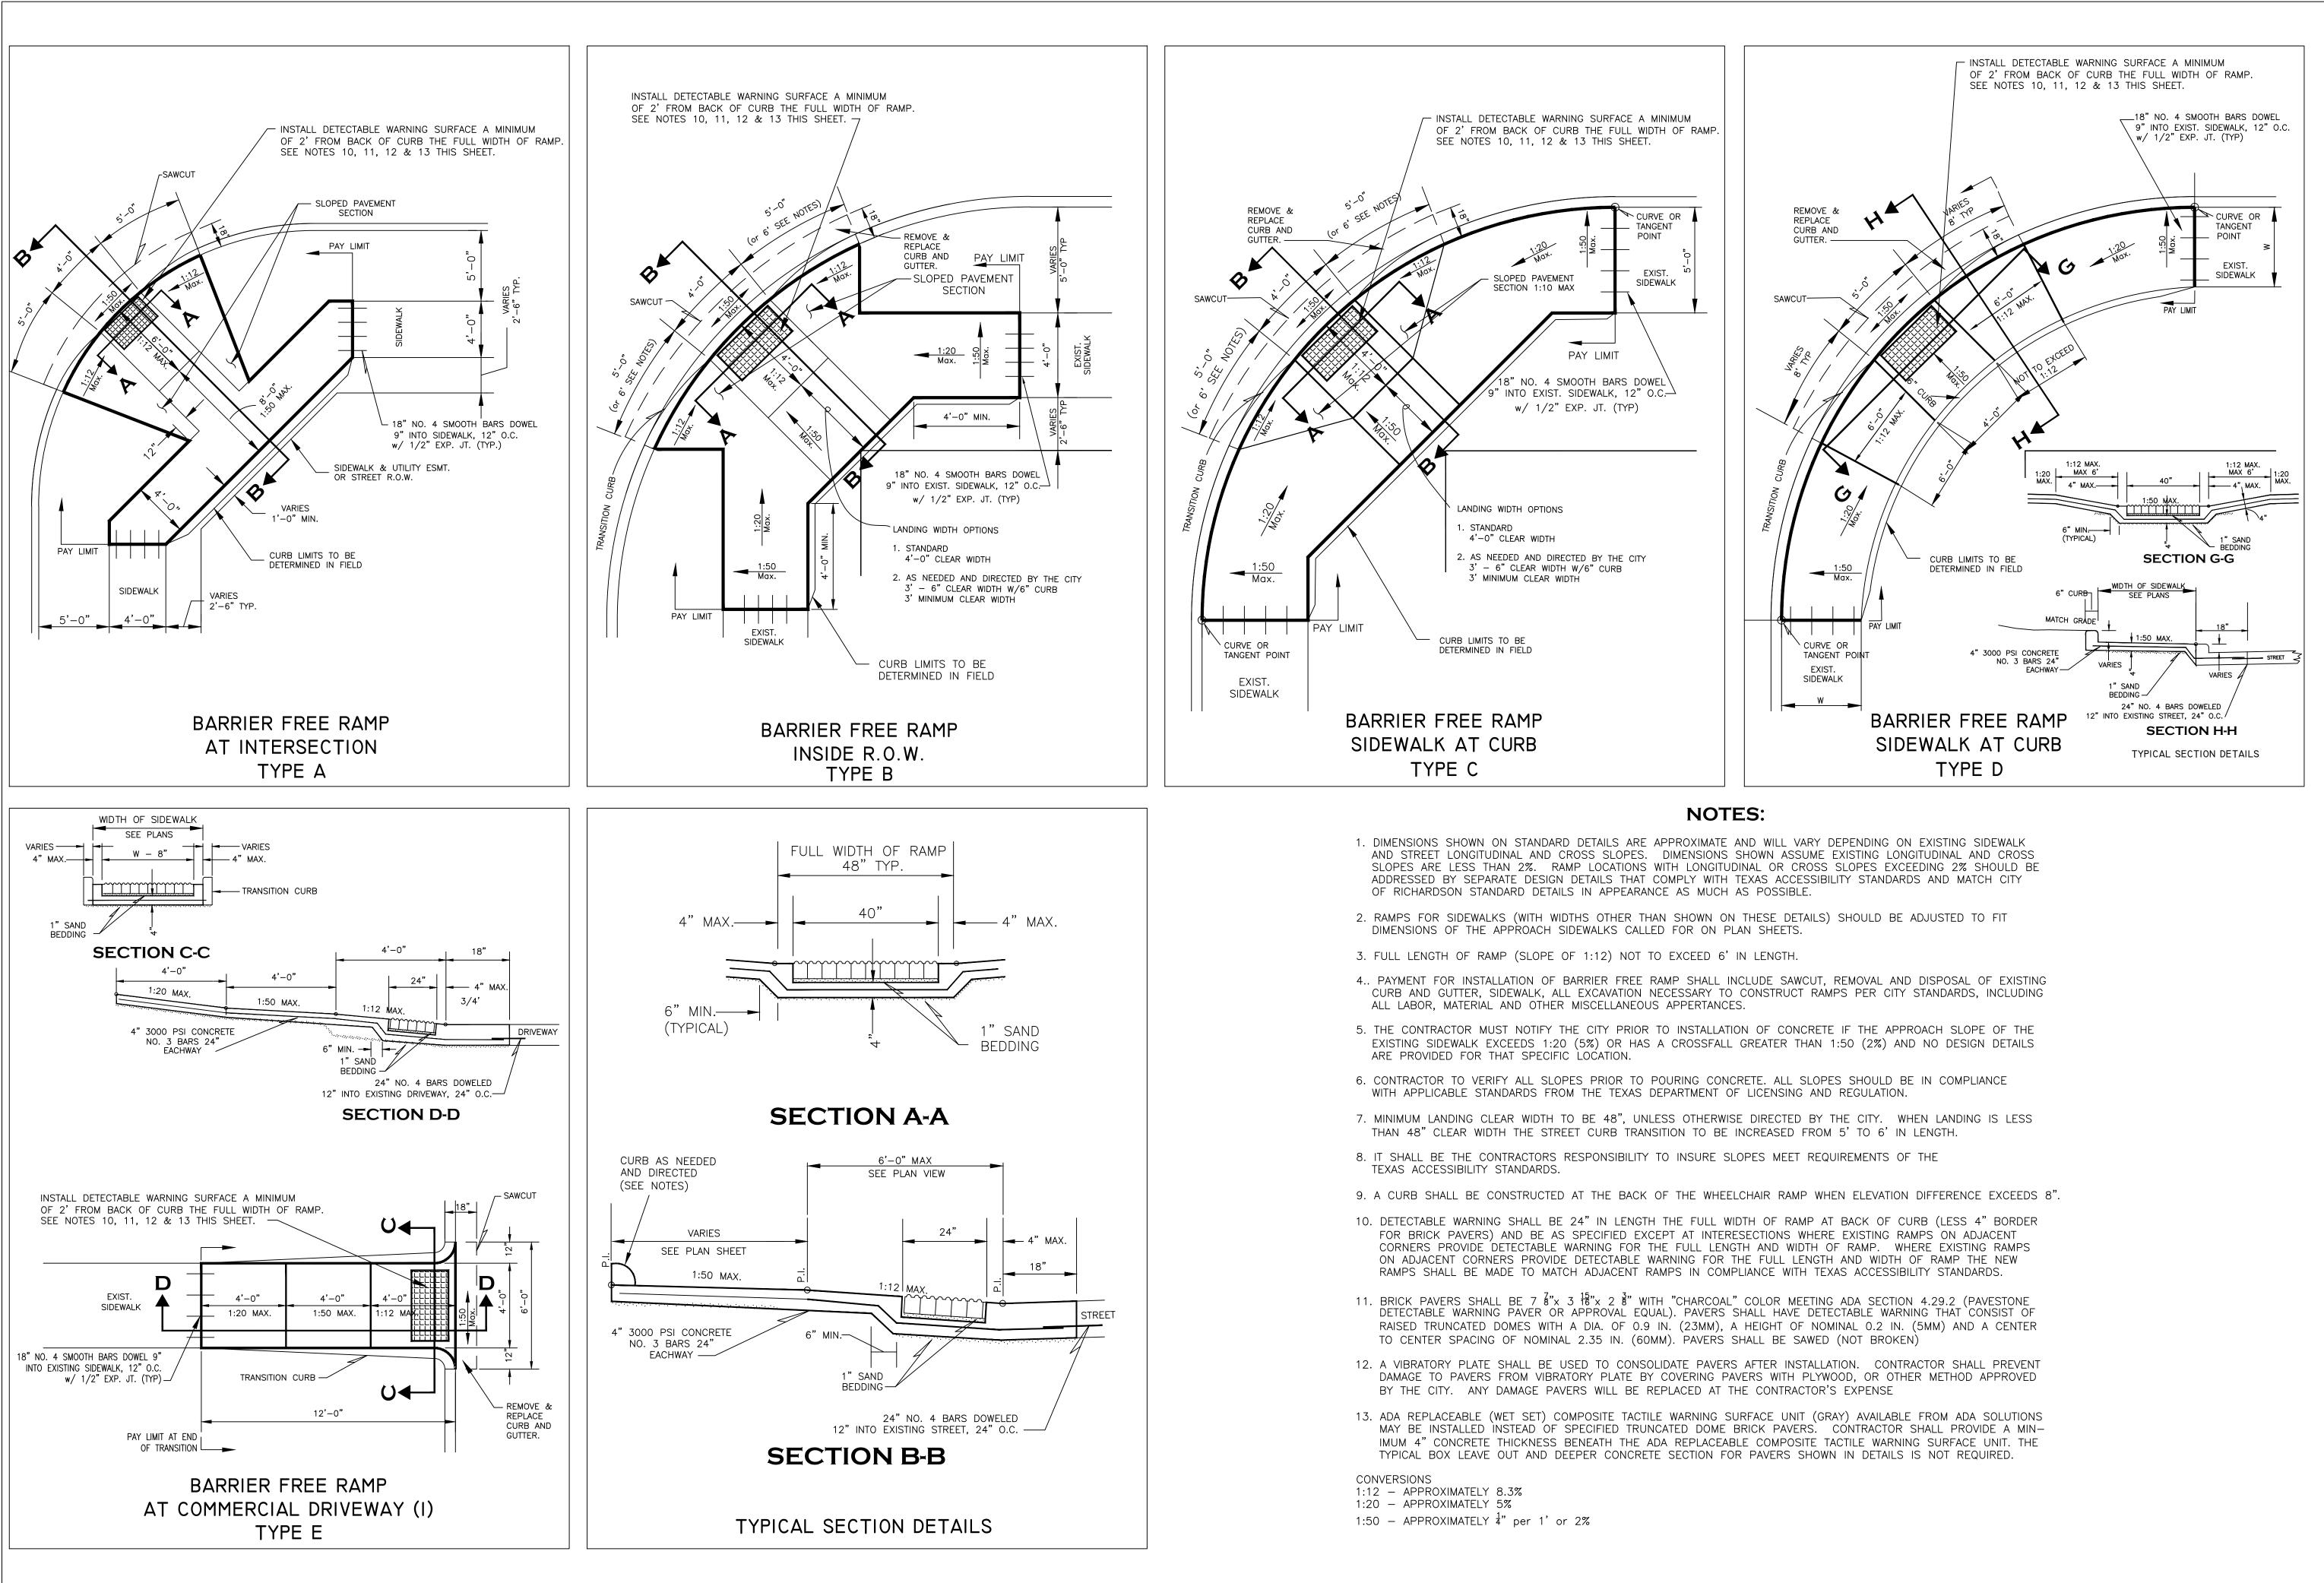




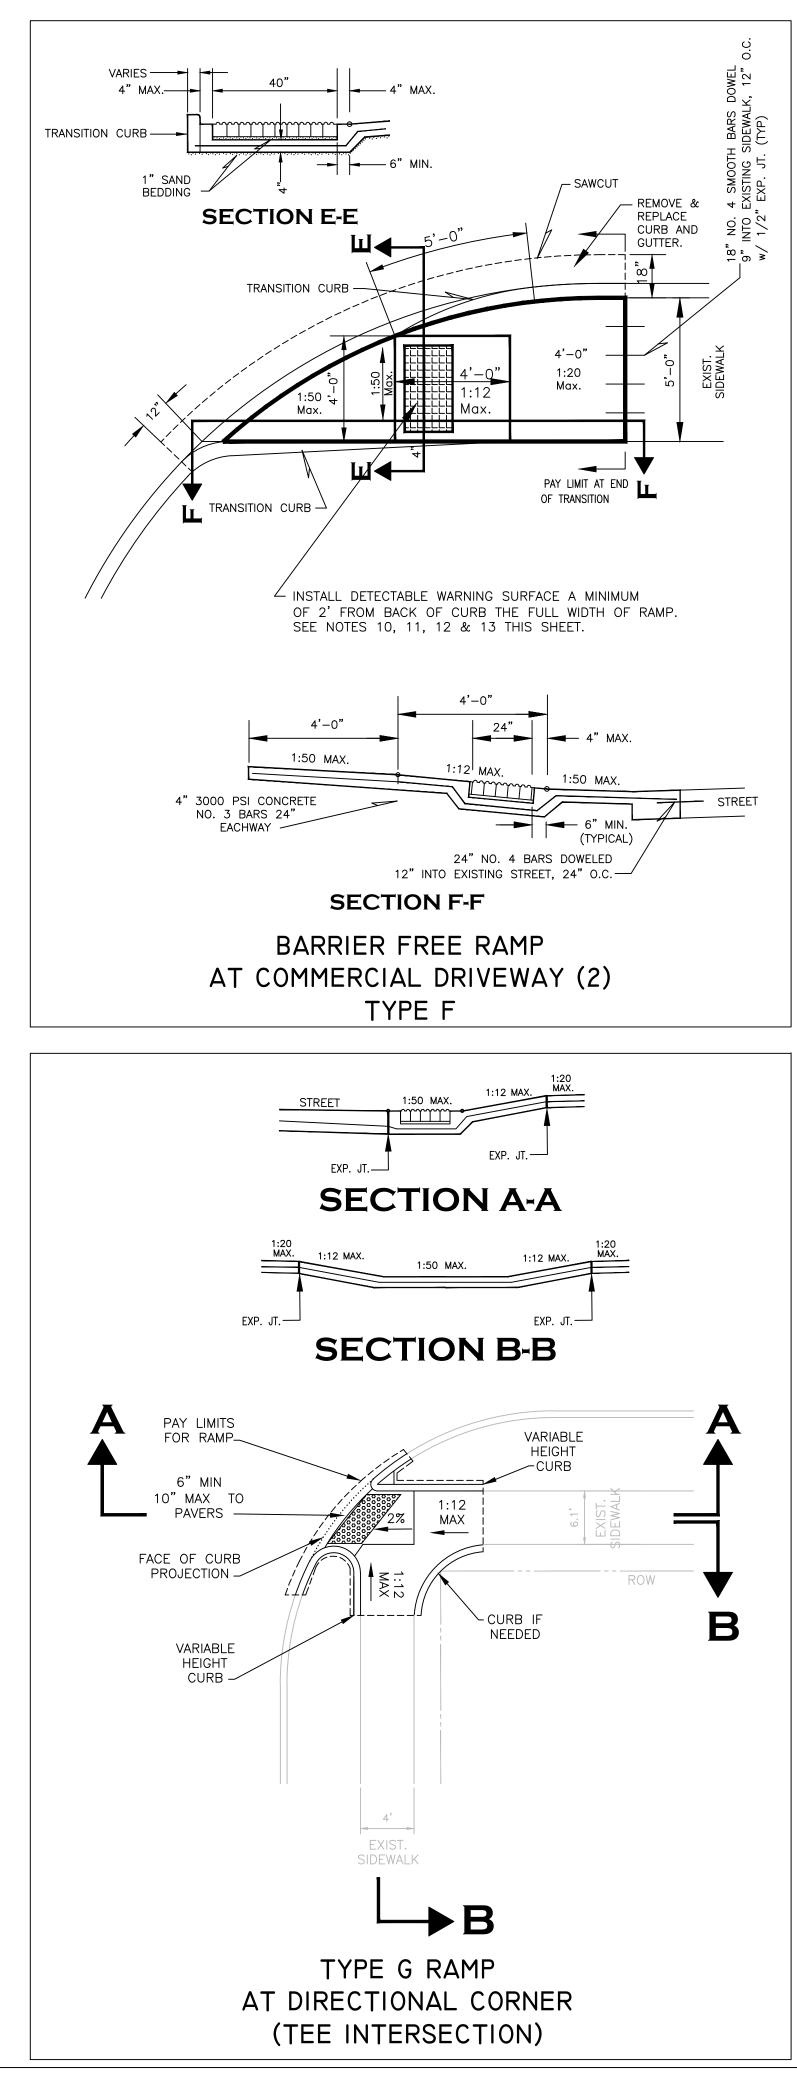


<u>NOTES:</u> 1. CONSTRUCTION SHALL CONFORM TO THE LATEST EDITION OF THE	CONCRETE
PUBLIC WORKS CONSTRUCTION STANDARDS, NORTH CENTRAL TEXAS.	MAY 1 THF
2. ALL JOINTS SHALL BE CONSIDERED SUBSIDIARY TO ALL PAVING ITEMS.	1. ALL MIX
3. FOR PLACING OF CONCRETE PAVEMENT REFER TO ITEM 303.5.5.	RETARDI
4. FOR MAXIMUM SLUMP OF CONCRETE FOR PAVEMENT REFER TO ITEM 303.4.4.	2. CONCRE SHALL
	3. THE TIM
	AGITATED (
PORTLAND CEMENT CONCRETE PAVEMENT	90°F OR A
1. STANDARD SPECIFICATIONS ITEM 303.2.1.3 – 'COARSE AGGREGATES' SHALL BE AMENDED	75°F TO 8
THE FIRST SENTENCE IS DELETED AND REPLACED AS FOLLOWS "COARSE AGGREGATES SHALL BE 100% CRUSHED STONE"	35°F TO 7
2. STANDARD SPECIFICATIONS ITEM 303 SHALL BE AMENDED AS FOLLOWS:	<u>NON AGITA</u>
A. ITEM 303.2.4. FLY ASH IS ALLOWED MAX 20% BY WEIGHT B. ITEM 303.2.5 SHALL BE DELETED. NO MINERAL FILLER IS ALLOWED	80°F or a
C. ITEM 303.2.6 SHALL BE DELETED. NO FIBROUS REINFORCEMENT ALLOWED	35°F TO 7
3. STANDARD SPECIFICATIONS ITEM 303 SHALL BE AMENDED TO INCLUDE THE FOLLOWING:	OCTOBER
A. ALL EQUIPMENT NECESSARY TO CONSTRUCT CONCRETE PAVEMENT SHALL BE APPROVED BY THE OWNER PRIOR TO STARTING THE PAVING OPERATION. PAVING EQUIPMENT REQUIREMENTS ARE AS FOLLOWS:	1. CONCRE SHALL I
1. <u>SIDEWALKS LESS THAN 8' IN WIDTH</u>	2. THE TIM
NO PAVING MACHINE REQUIRED. STINGER VIBRATORS AND METAL STRAIGHT EDGES	<u>AGITATED</u>
SHALL BE USED TO CONSOLIDATE THE CONCRETE.	90°F OR A
2. <u>SIDEWALKS 8' IN WIDTH OR WIDER</u> VIBRATING SCREED WITH TWO HAND HELD STINGER VIBRATORS SHALL BE USED TO	75°F TO 8
CONSOLIDATE THE CONCRETE.	35°F TO 7
B. CONCRETE FINISH	<u>NON AGITA</u>
SIDEWALK TO BE LIGHT BROOM FINISH.	80°F OR A
	35°F TO 7





Revisions:
City of Richardson
411 W. Arapaho Road Suite 204 Richardson, Texas 75080 voice: 972 744-4280 fax: 972 744-5804 Drawn By: RGB Checked By: COR
CITY OF CITY OF RICHARDSON TEXAS
STANDARD DETAILS City of Richardson, Texas
NO ADDITIONS OR CHANGES TO STANDARD DETAIL SHEETS UNLESS APPROVED BY CITY OF RICHARDSON
24"x36" Scale: NTS 11"x17" Scale: NTS
Vertical Scale: NA Project Number: XXX Issue Date: 01 MAY 14 Sheet Title: BARRIER
FREE RAMPS Sheet No.: C-12



NOTES:

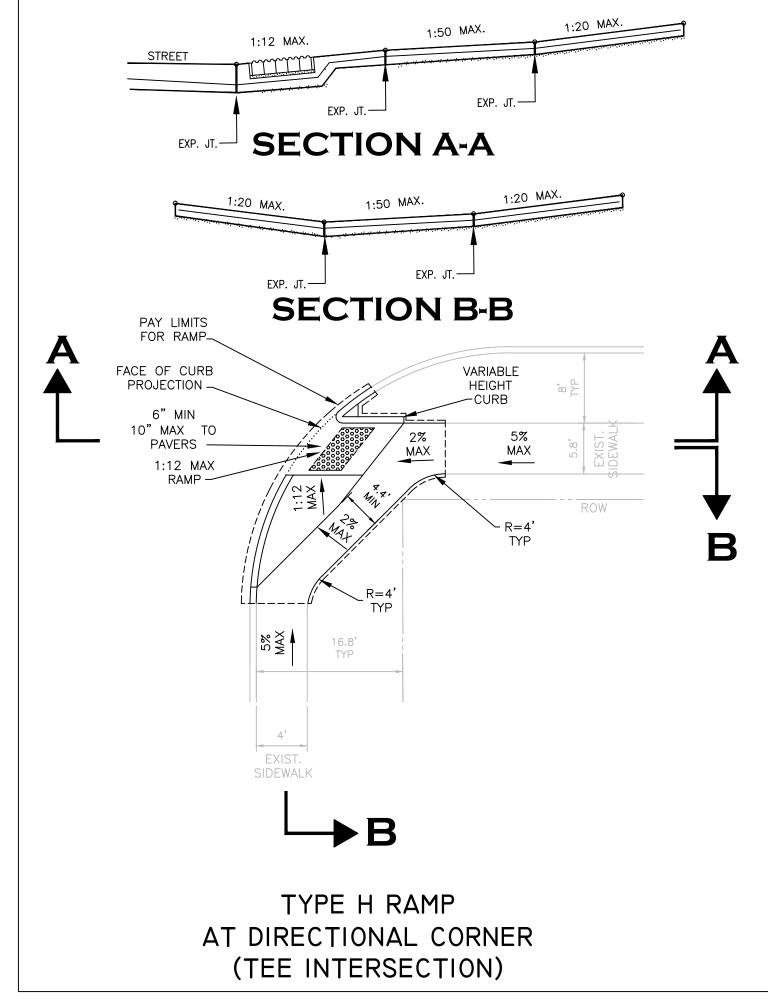
- 1. DIMENSIONS SHOWN ON STANDARD DETAILS ARE APPROXIMATE AND WILL VARY DEPENDING ON EXISTING SIDEWALK AND STREET LONGITUDINAL AND CROSS SLOPES. DIMENSIONS SHOWN ASSUME EXISTING LONGITUDINAL AND CROSS SLOPES ARE LESS THAN 2%. RAMP LOCATIONS WITH LONGITUDINAL OR CROSS SLOPES EXCEEDING 2% SHOULD BE ADDRESSED BY SEPARATE DESIGN DETAILS THAT COMPLY WITH TEXAS ACCESSIBILITY STANDARDS AND MATCH CITY OF RICHARDSON STANDARD DETAILS IN APPEARANCE AS MUCH AS POSSIBLE.
- 2. RAMPS FOR SIDEWALKS (WITH WIDTHS OTHER THAN SHOWN ON THESE DETAILS) SHOULD BE ADJUSTED TO FIT DIMENSIONS OF THE APPROACH SIDEWALKS CALLED FOR ON PLAN SHEETS.
- 3. FULL LENGTH OF RAMP (SLOPE OF 1:12) NOT TO EXCEED 6' IN LENGTH.
- 4.. PAYMENT FOR INSTALLATION OF BARRIER FREE RAMP SHALL INCLUDE SAWCUT, REMOVAL AND DISPOSAL OF EXISTING CURB AND GUTTER, SIDEWALK, ALL EXCAVATION NECESSARY TO CONSTRUCT RAMPS PER CITY STANDARDS, INCLUDING ALL LABOR, MATERIAL AND OTHER MISCELLANEOUS APPERTANCES.
- 5. THE CONTRACTOR MUST NOTIFY THE CITY PRIOR TO INSTALLATION OF CONCRETE IF THE APPROACH SLOPE OF THE EXISTING SIDEWALK EXCEEDS 1:20 (5%) OR HAS A CROSSFALL GREATER THAN 1:50 (2%) AND NO DESIGN DETAILS ARE PROVIDED FOR THAT SPECIFIC LOCATION.
- 6. CONTRACTOR TO VERIFY ALL SLOPES PRIOR TO POURING CONCRETE. ALL SLOPES SHOULD BE IN COMPLIANCE WITH APPLICABLE STANDARDS FROM THE TEXAS DEPARTMENT OF LICENSING AND REGULATION.
- 7. MINIMUM LANDING CLEAR WIDTH TO BE 48", UNLESS OTHERWISE DIRECTED BY THE CITY. WHEN LANDING IS LESS THAN 48" CLEAR WIDTH THE STREET CURB TRANSITION TO BE INCREASED FROM 5' TO 6' IN LENGTH.
- 8. IT SHALL BE THE CONTRACTORS RESPONSIBILITY TO INSURE SLOPES MEET REQUIREMENTS OF THE TEXAS ACCESSIBILITY STANDARDS.

9. A CURB SHALL BE CONSTRUCTED AT THE BACK OF THE WHEELCHAIR RAMP WHEN ELEVATION DIFFERENCE EXCEEDS 8".

- 10. DETECTABLE WARNING SHALL BE 24" IN LENGTH THE FULL WIDTH OF RAMP AT BACK OF CURB (LESS 4" BORDER FOR BRICK PAVERS) AND BE AS SPECIFIED EXCEPT AT INTERESECTIONS WHERE EXISTING RAMPS ON ADJACENT CORNERS PROVIDE DETECTABLE WARNING FOR THE FULL LENGTH AND WIDTH OF RAMP. WHERE EXISTING RAMPS ON ADJACENT CORNERS PROVIDE DETECTABLE WARNING FOR THE FULL LENGTH AND WIDTH OF RAMP THE NEW RAMPS SHALL BE MADE TO MATCH ADJACENT RAMPS IN COMPLIANCE WITH TEXAS ACCESSIBILITY STANDARDS.
- 11. BRICK PAVERS SHALL BE 7 8"x 3 15"x 2 3" WITH "CHARCOAL" COLOR MEETING ADA SECTION 4.29.2 (PAVESTONE DETECTABLE WARNING PAVER OR APPROVAL EQUAL). PAVERS SHALL HAVE DETECTABLE WARNING THAT CONSIST OF RAISED TRUNCATED DOMES WITH A DIA. OF 0.9 IN. (23MM), A HEIGHT OF NOMINAL 0.2 IN. (5MM) AND A CENTER TO CENTER SPACING OF NOMINAL 2.35 IN. (60MM). PAVERS SHALL BE SAWED (NOT BROKEN)
- 12. A VIBRATORY PLATE SHALL BE USED TO CONSOLIDATE PAVERS AFTER INSTALLATION. CONTRACTOR SHALL PREVENT DAMAGE TO PAVERS FROM VIBRATORY PLATE BY COVERING PAVERS WITH PLYWOOD, OR OTHER METHOD APPROVED BY THE CITY. ANY DAMAGE PAVERS WILL BE REPLACED AT THE CONTRACTOR'S EXPENSE
- 13. ADA REPLACEABLE (WET SET) COMPOSITE TACTILE WARNING SURFACE UNIT (GRAY) AVAILABLE FROM ADA SOLUTIONS MAY BE INSTALLED INSTEAD OF SPECIFIED TRUNCATED DOME BRICK PAVERS. CONTRACTOR SHALL PROVIDE A MIN-IMUM 4" CONCRETE THICKNESS BENEATH THE ADA REPLACEABLE COMPOSITE TACTILE WARNING SURFACE UNIT. THE TYPICAL BOX LEAVE OUT AND DEEPER CONCRETE SECTION FOR PAVERS SHOWN IN DETAILS IS NOT REQUIRED.

CONVERSIONS 1:12 - APPROXIMATELY 8.3% 1:20 – APPROXIMATELY 5%

1:50 – APPROXIMATELY 4" per 1' or 2%



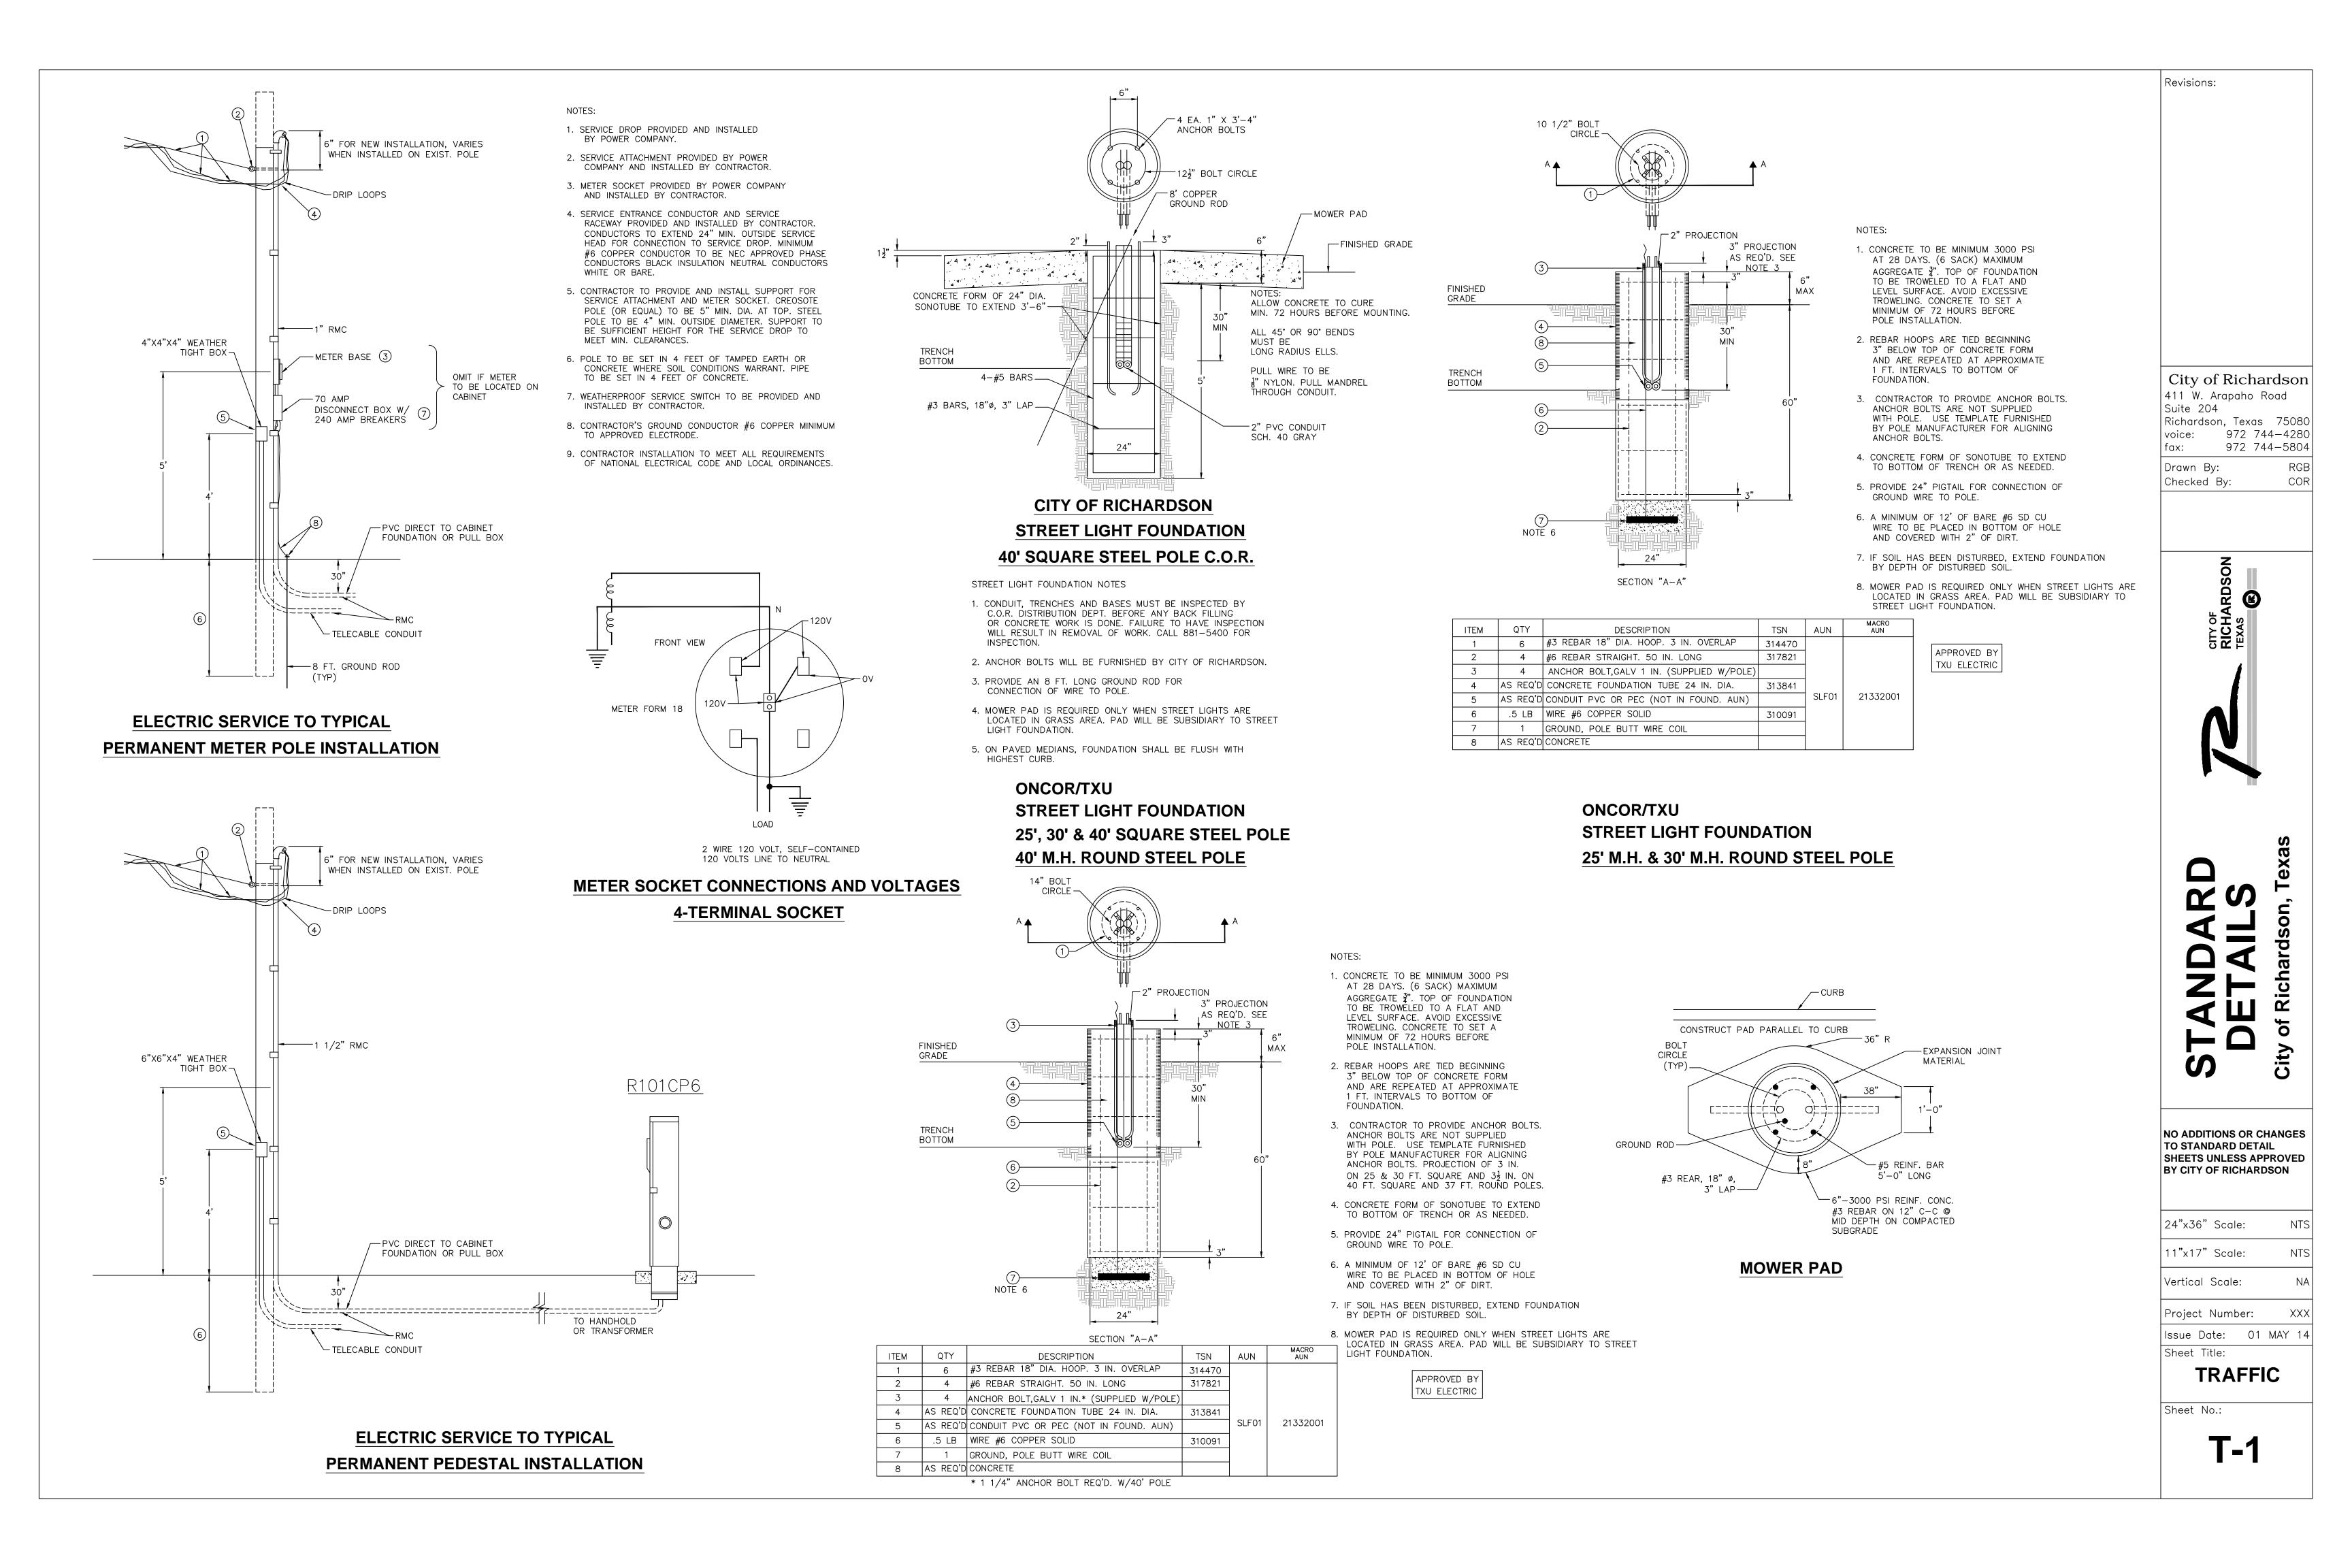
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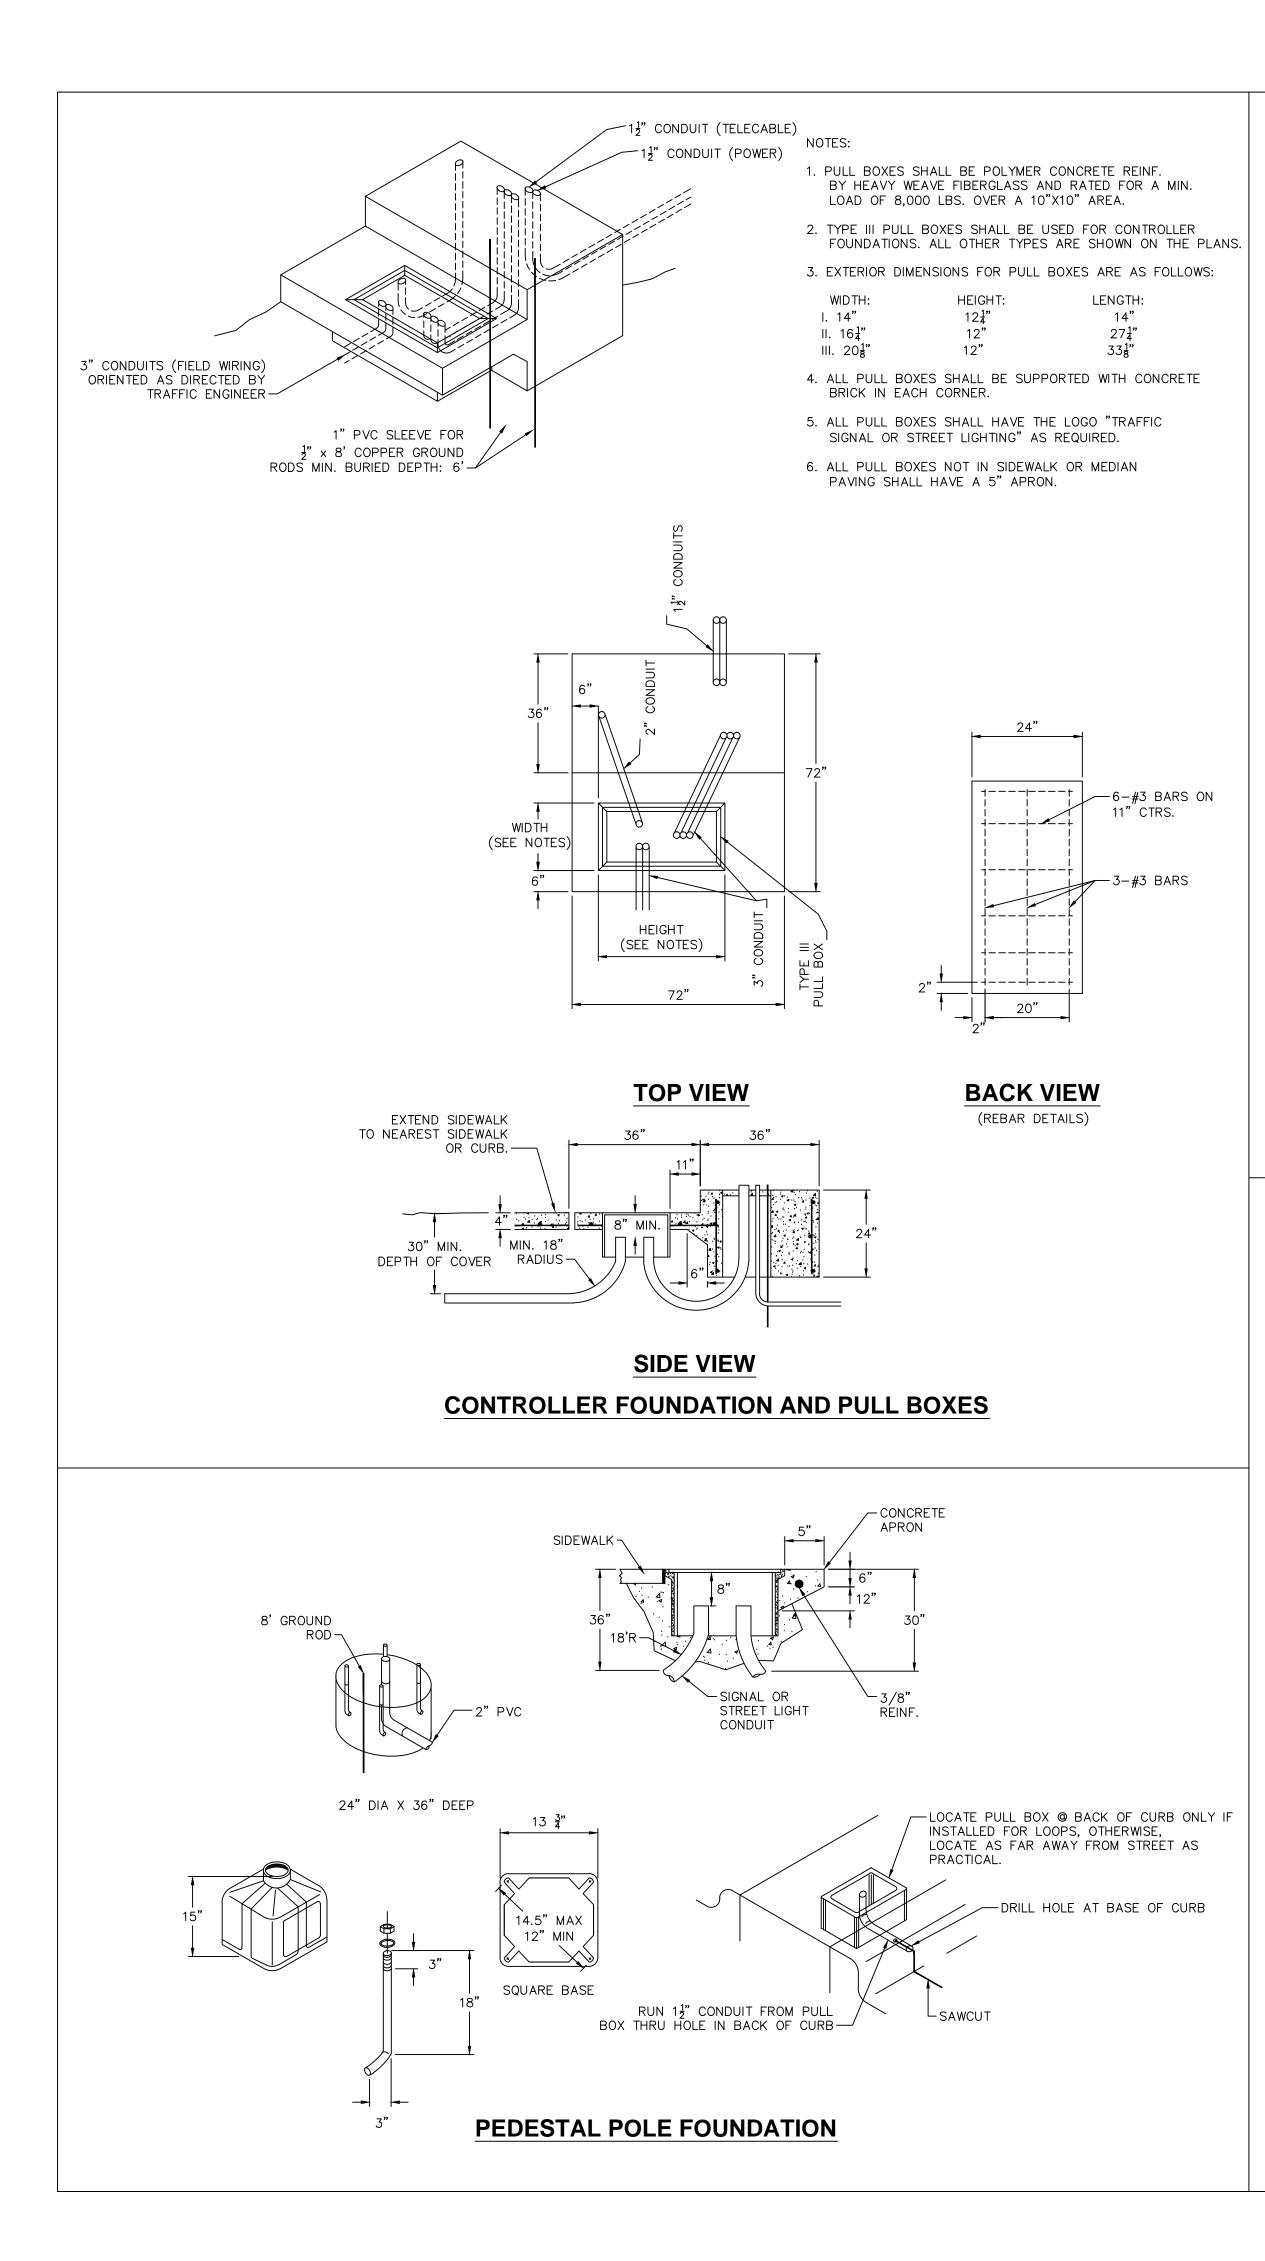
City of Richardson 411 W. Arapaho Road Suite 204 Richardson, Texas 75080 972 744-4280 voice: 972 744-5804 fax: Drawn By: RGB COR Checked By:

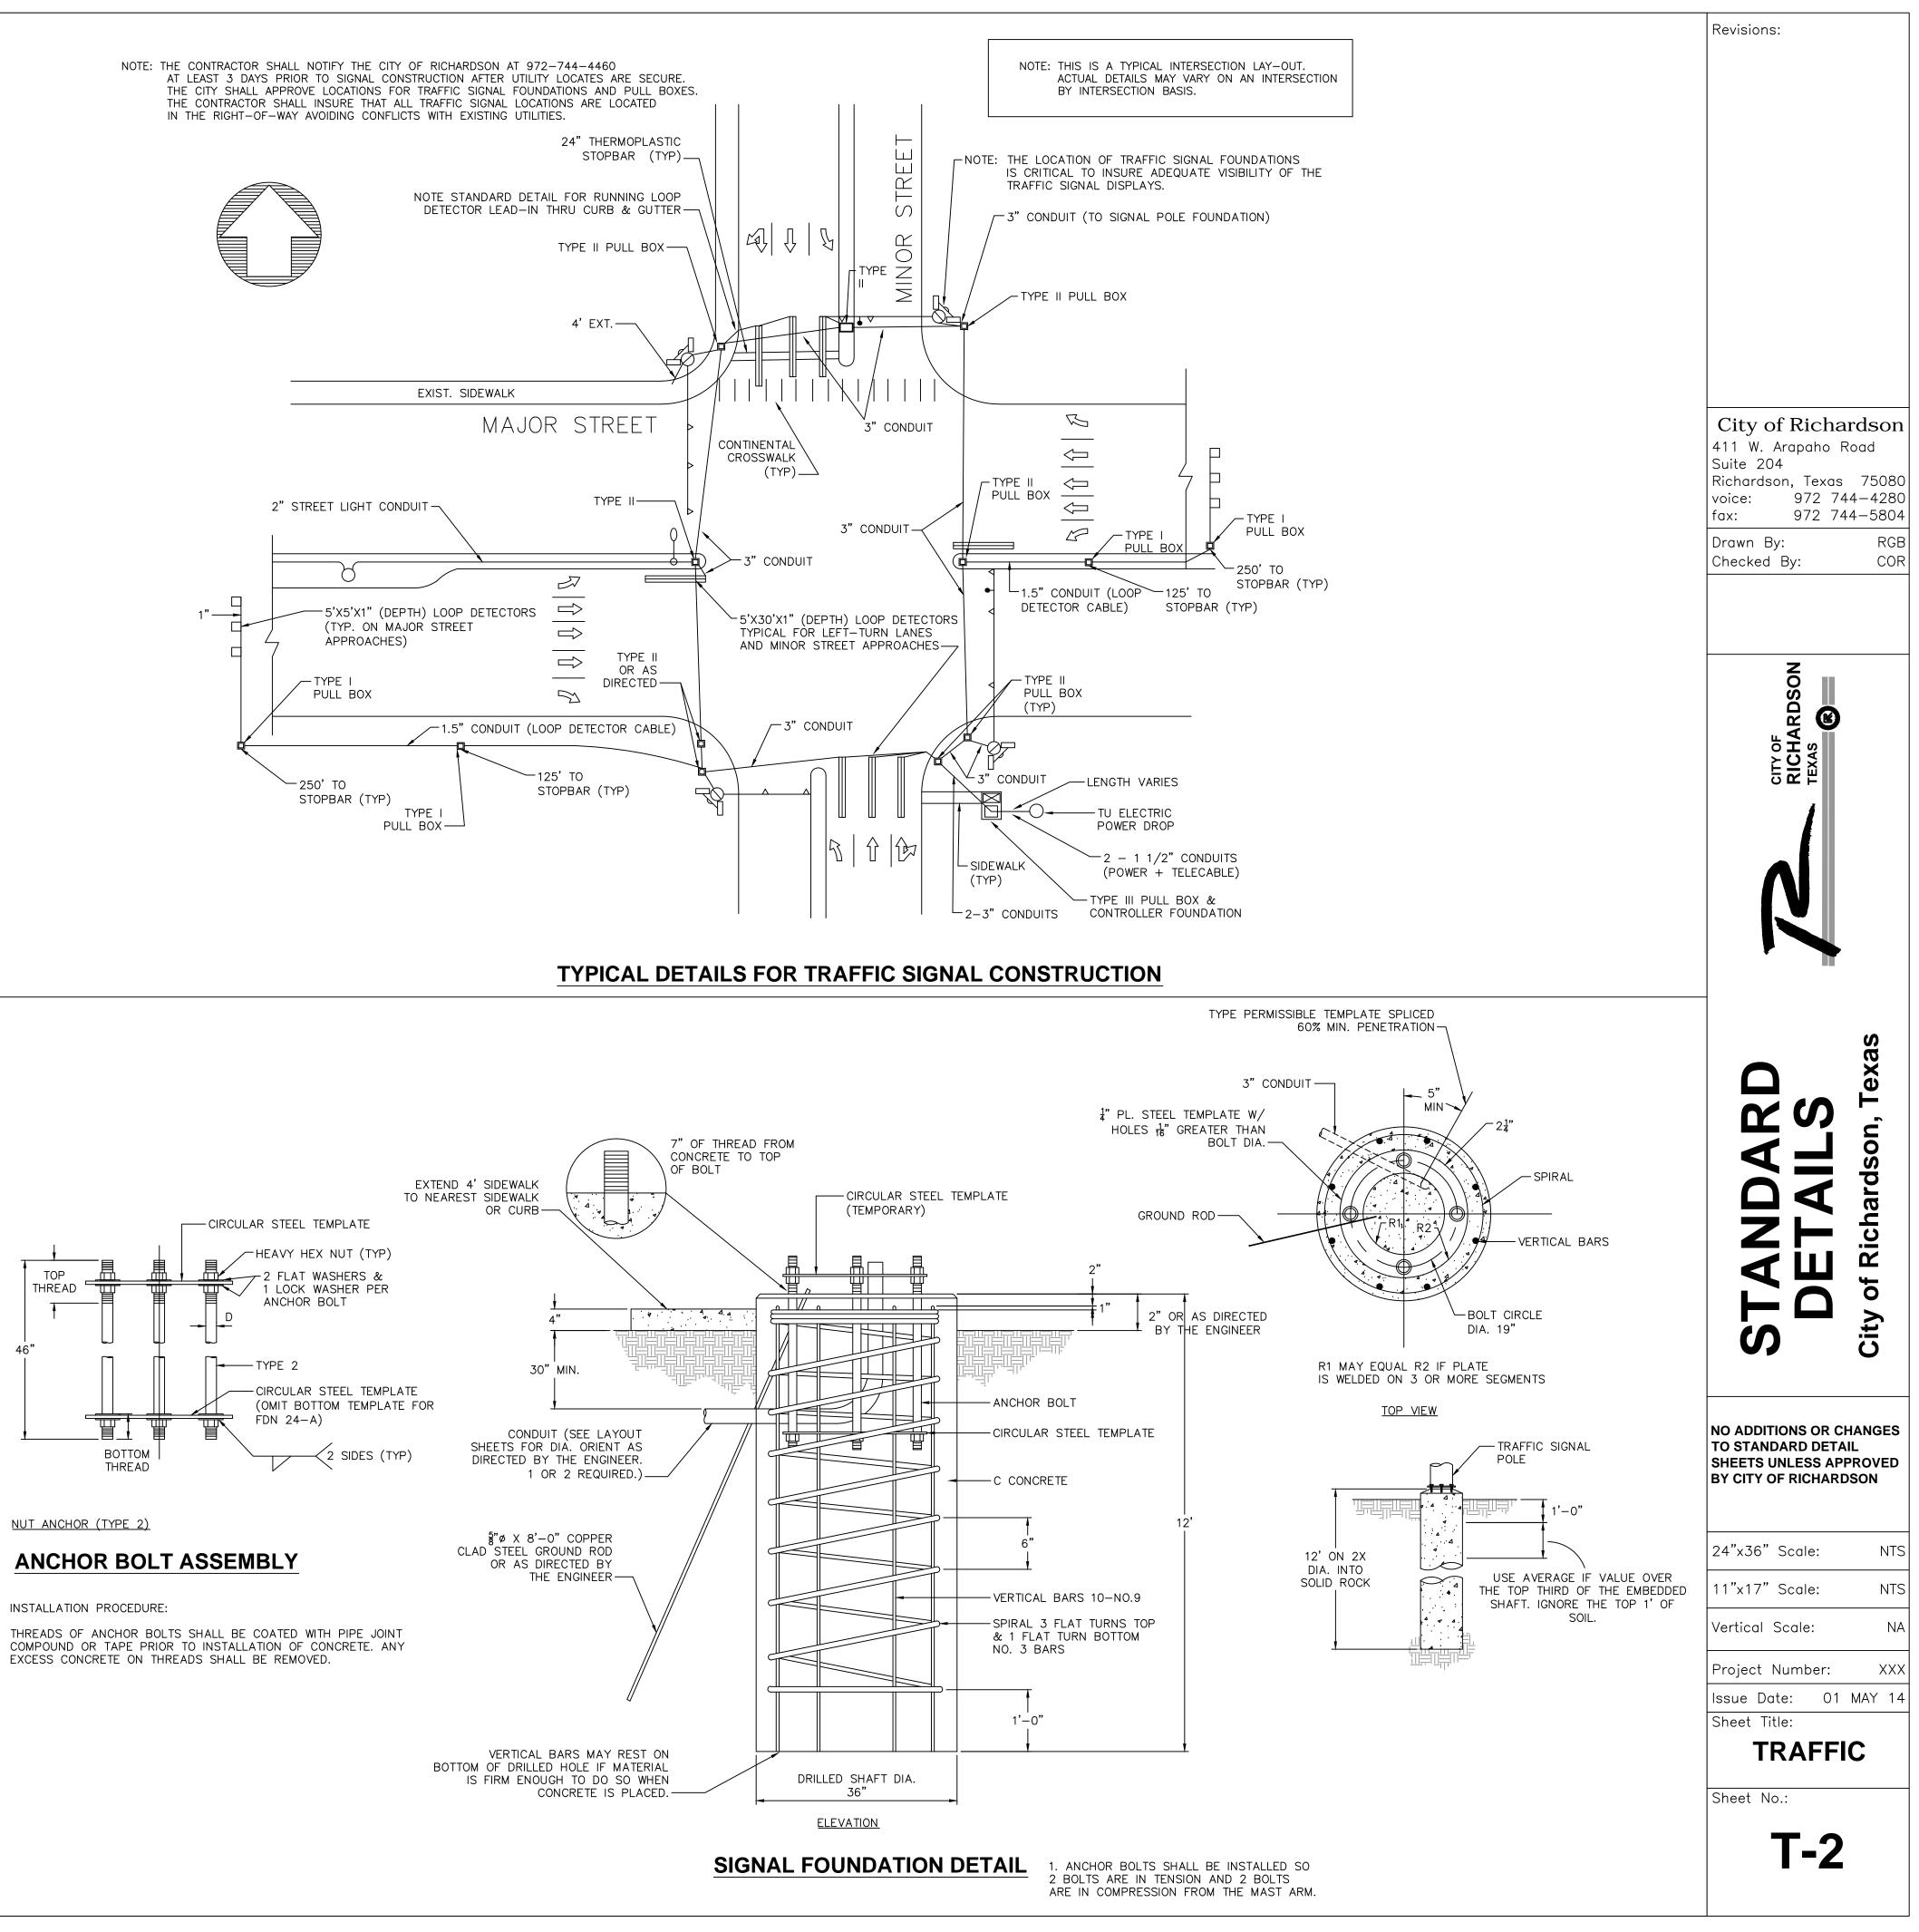


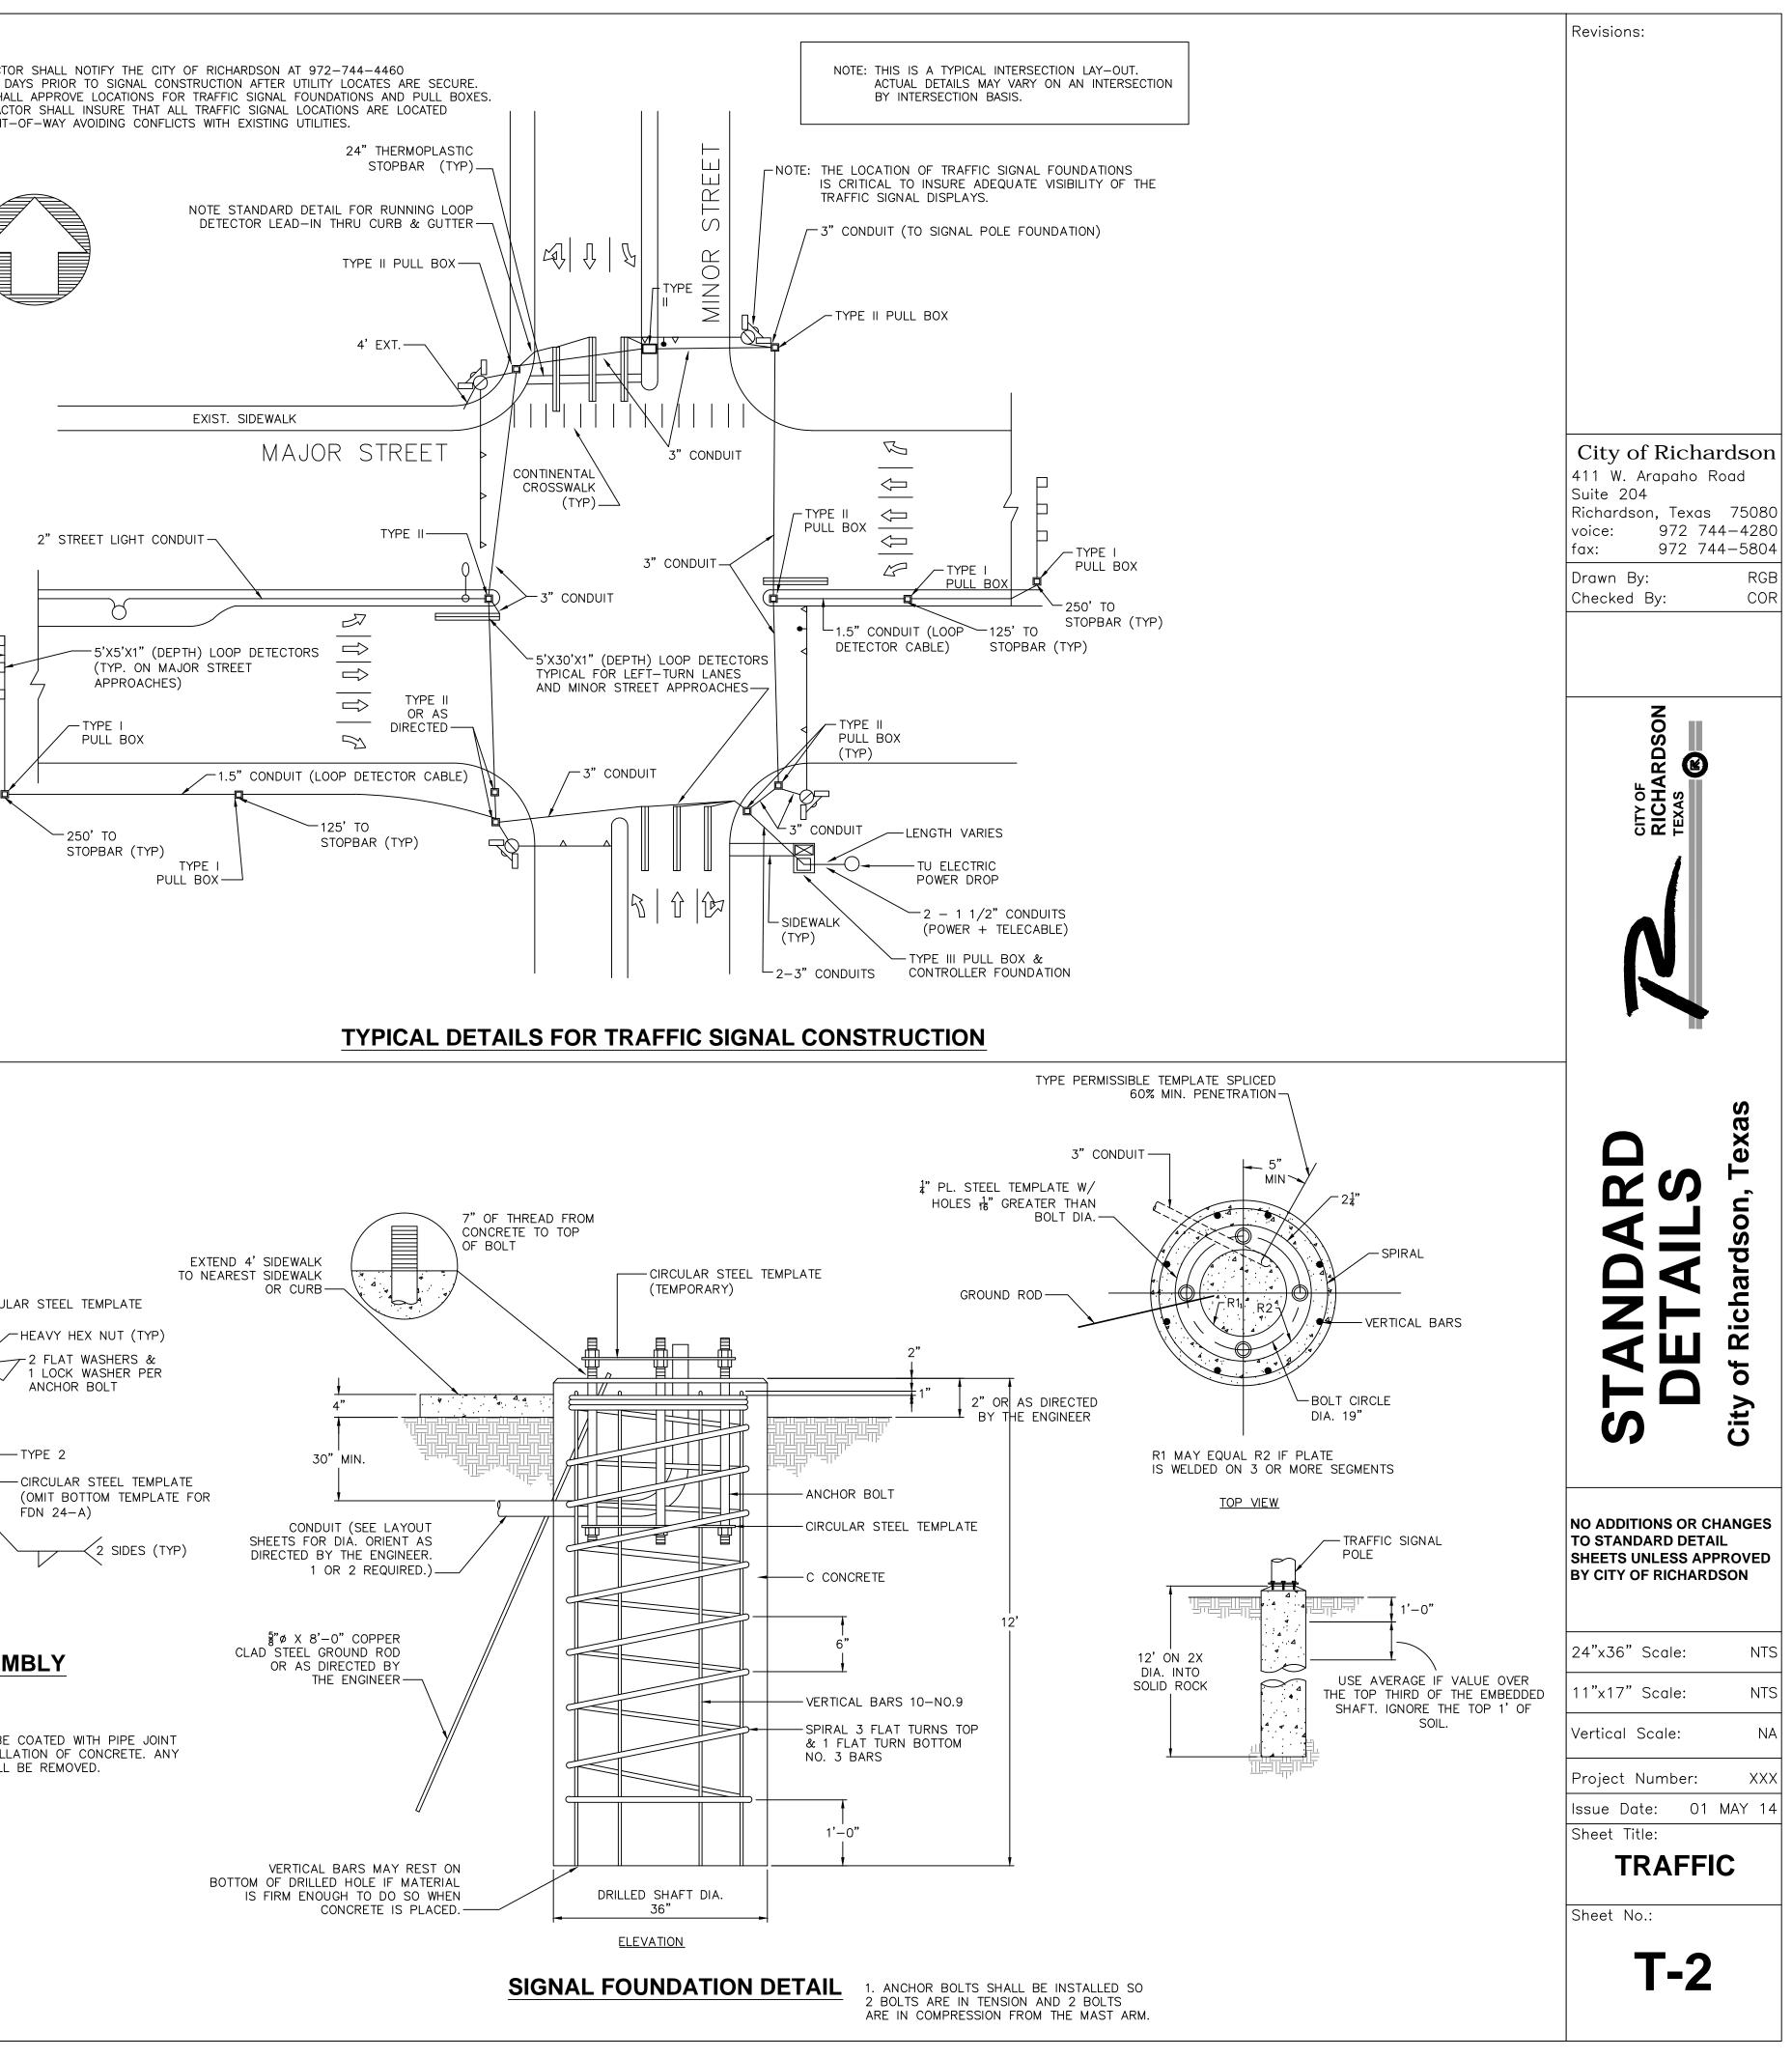
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NO ADDITIONS OR CHANG TO STANDARD DETAIL SHEETS UNLESS APPROV BY CITY OF RICHARDSON	
24"x36" Scale:	NTS
11"x17" Scale:	NTS
Vertical Scale:	NA
Project Number:	xxx
Issue Date: 01 MAY	14
Sheet Title: BARRIER FREE RAMPS Sheet No.:	S

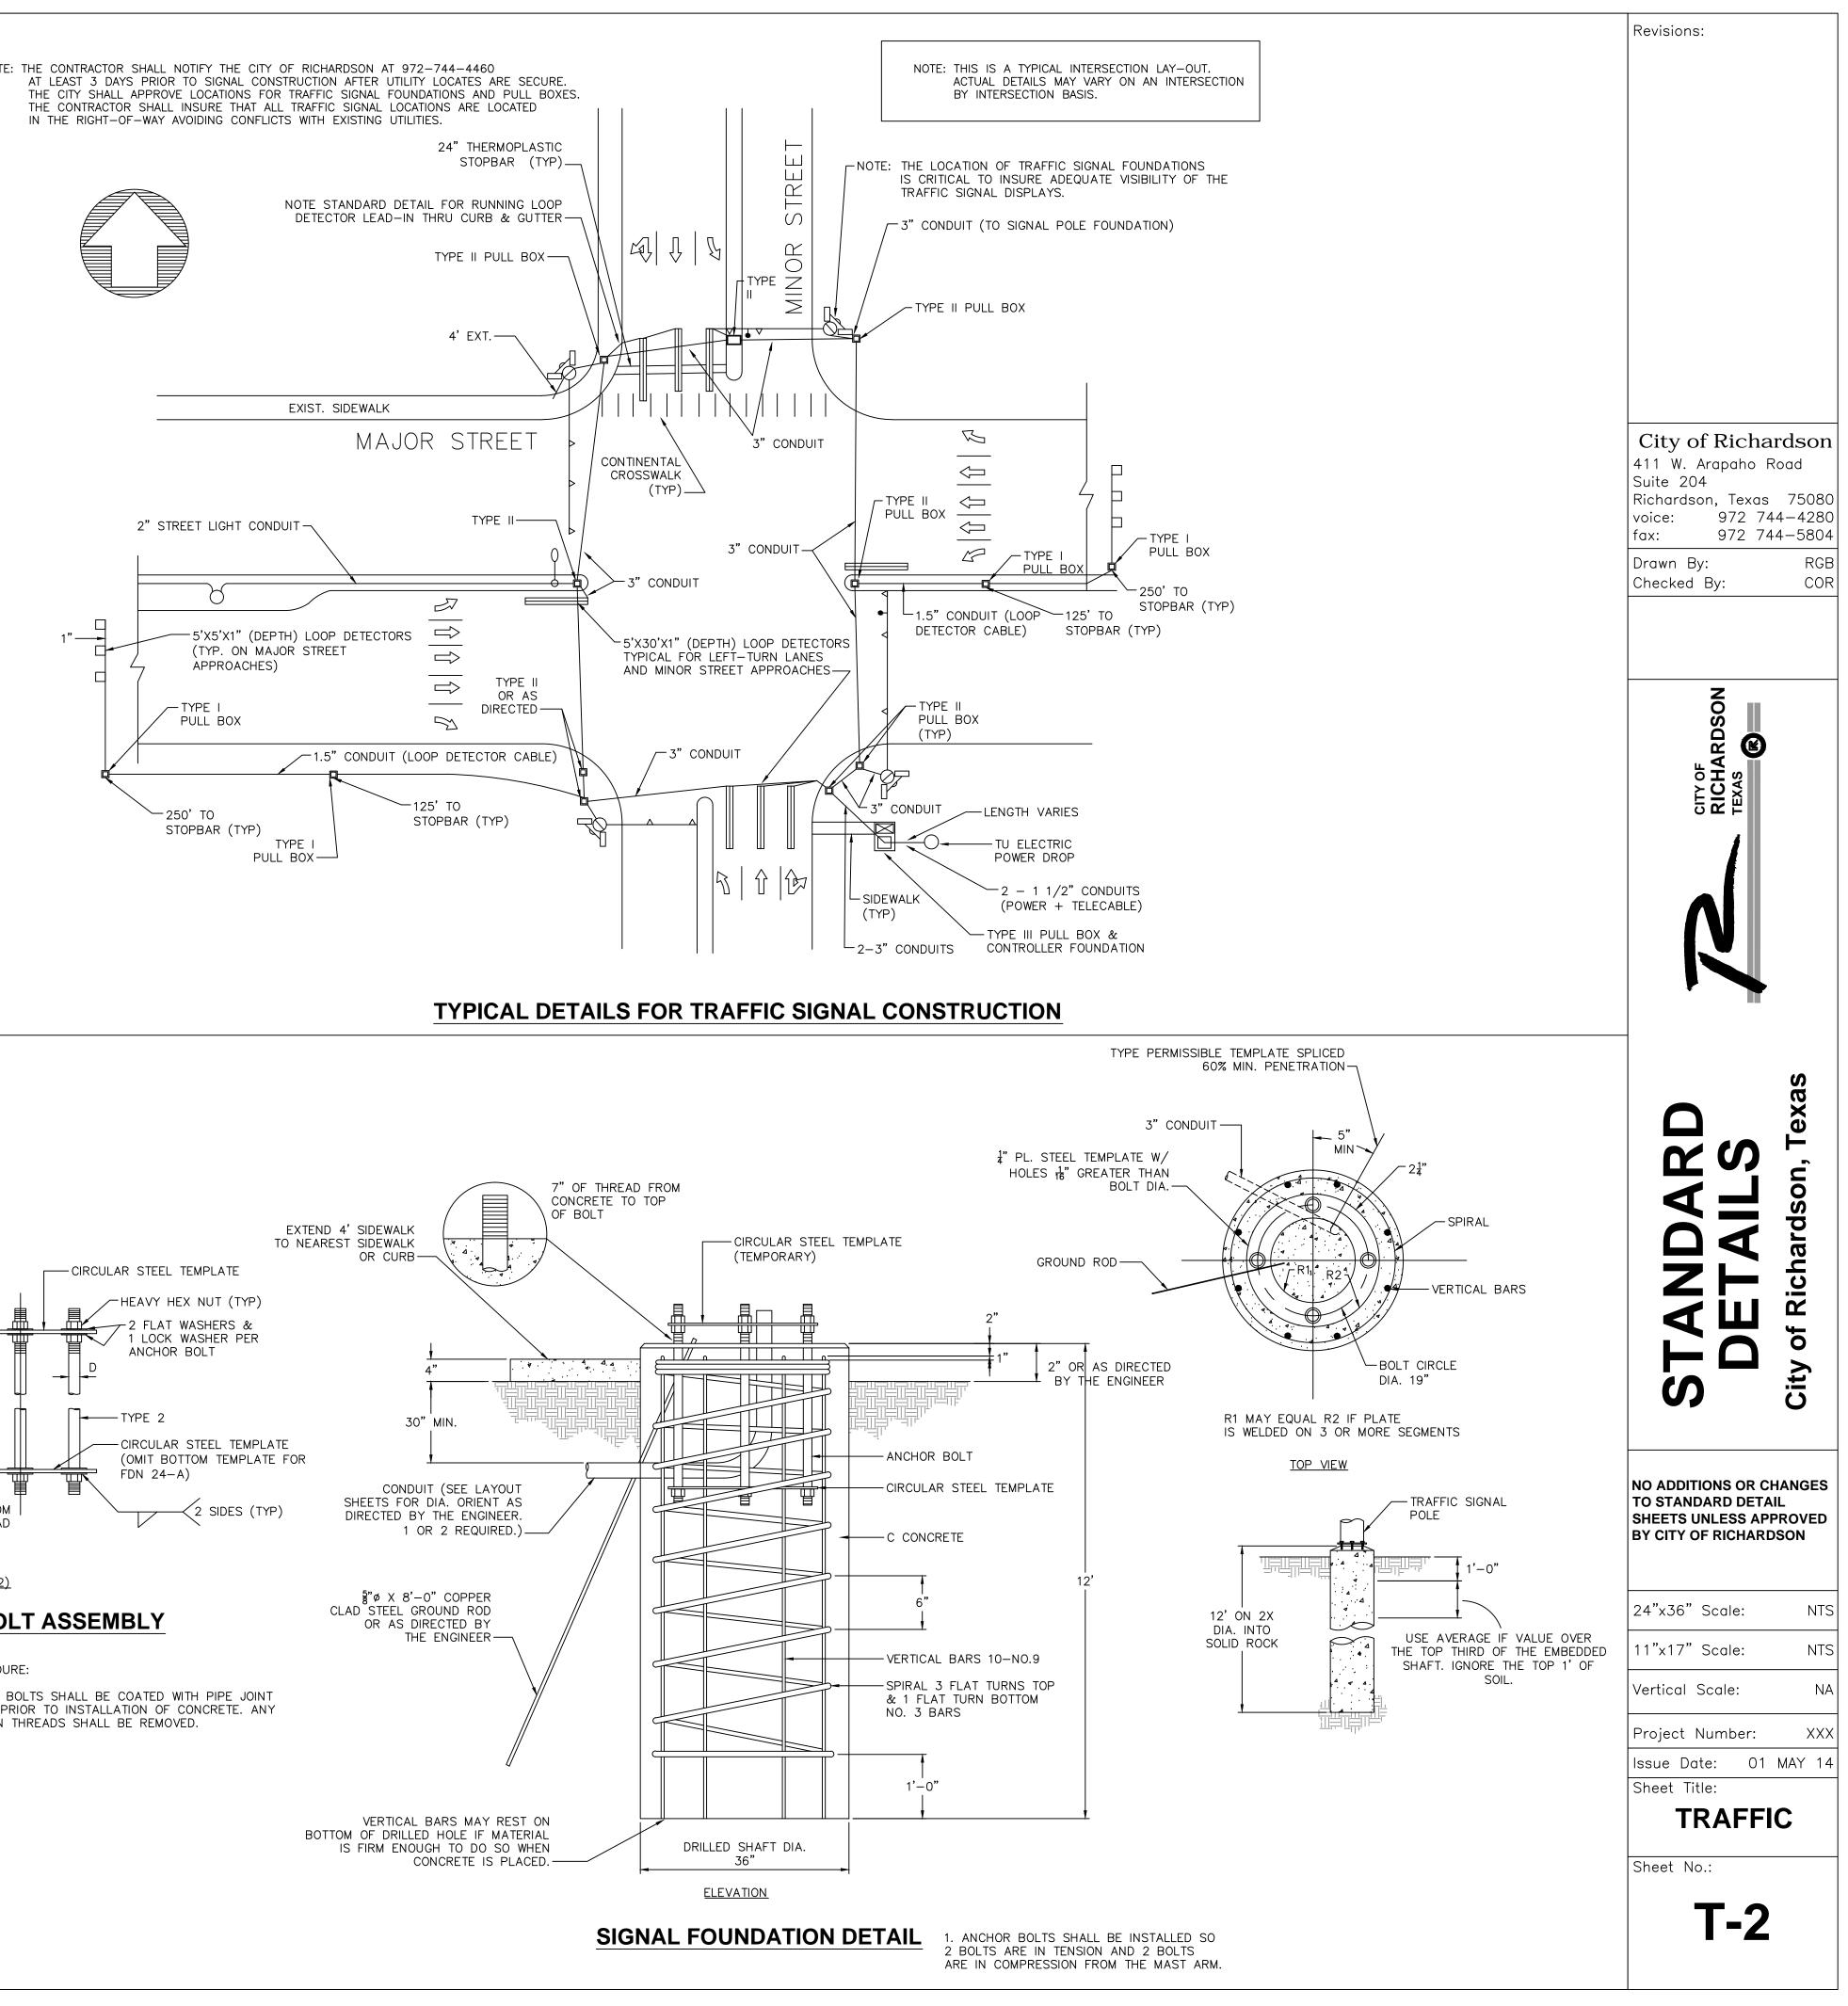
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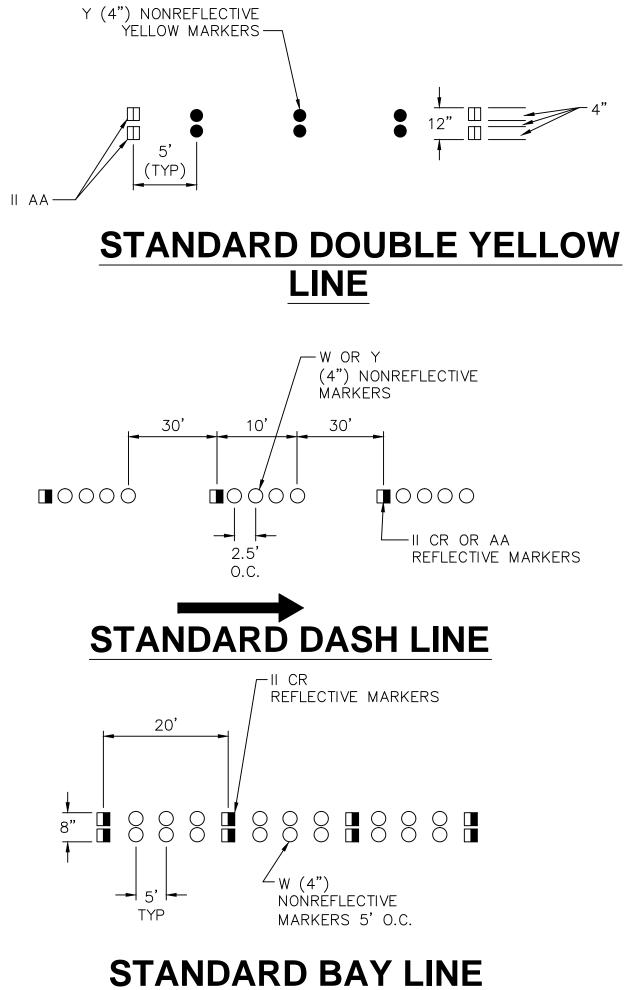


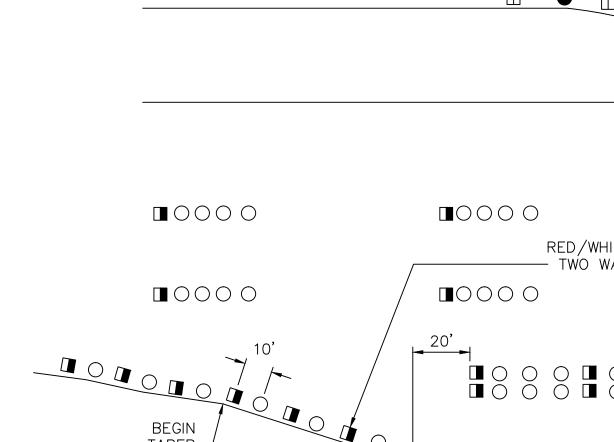










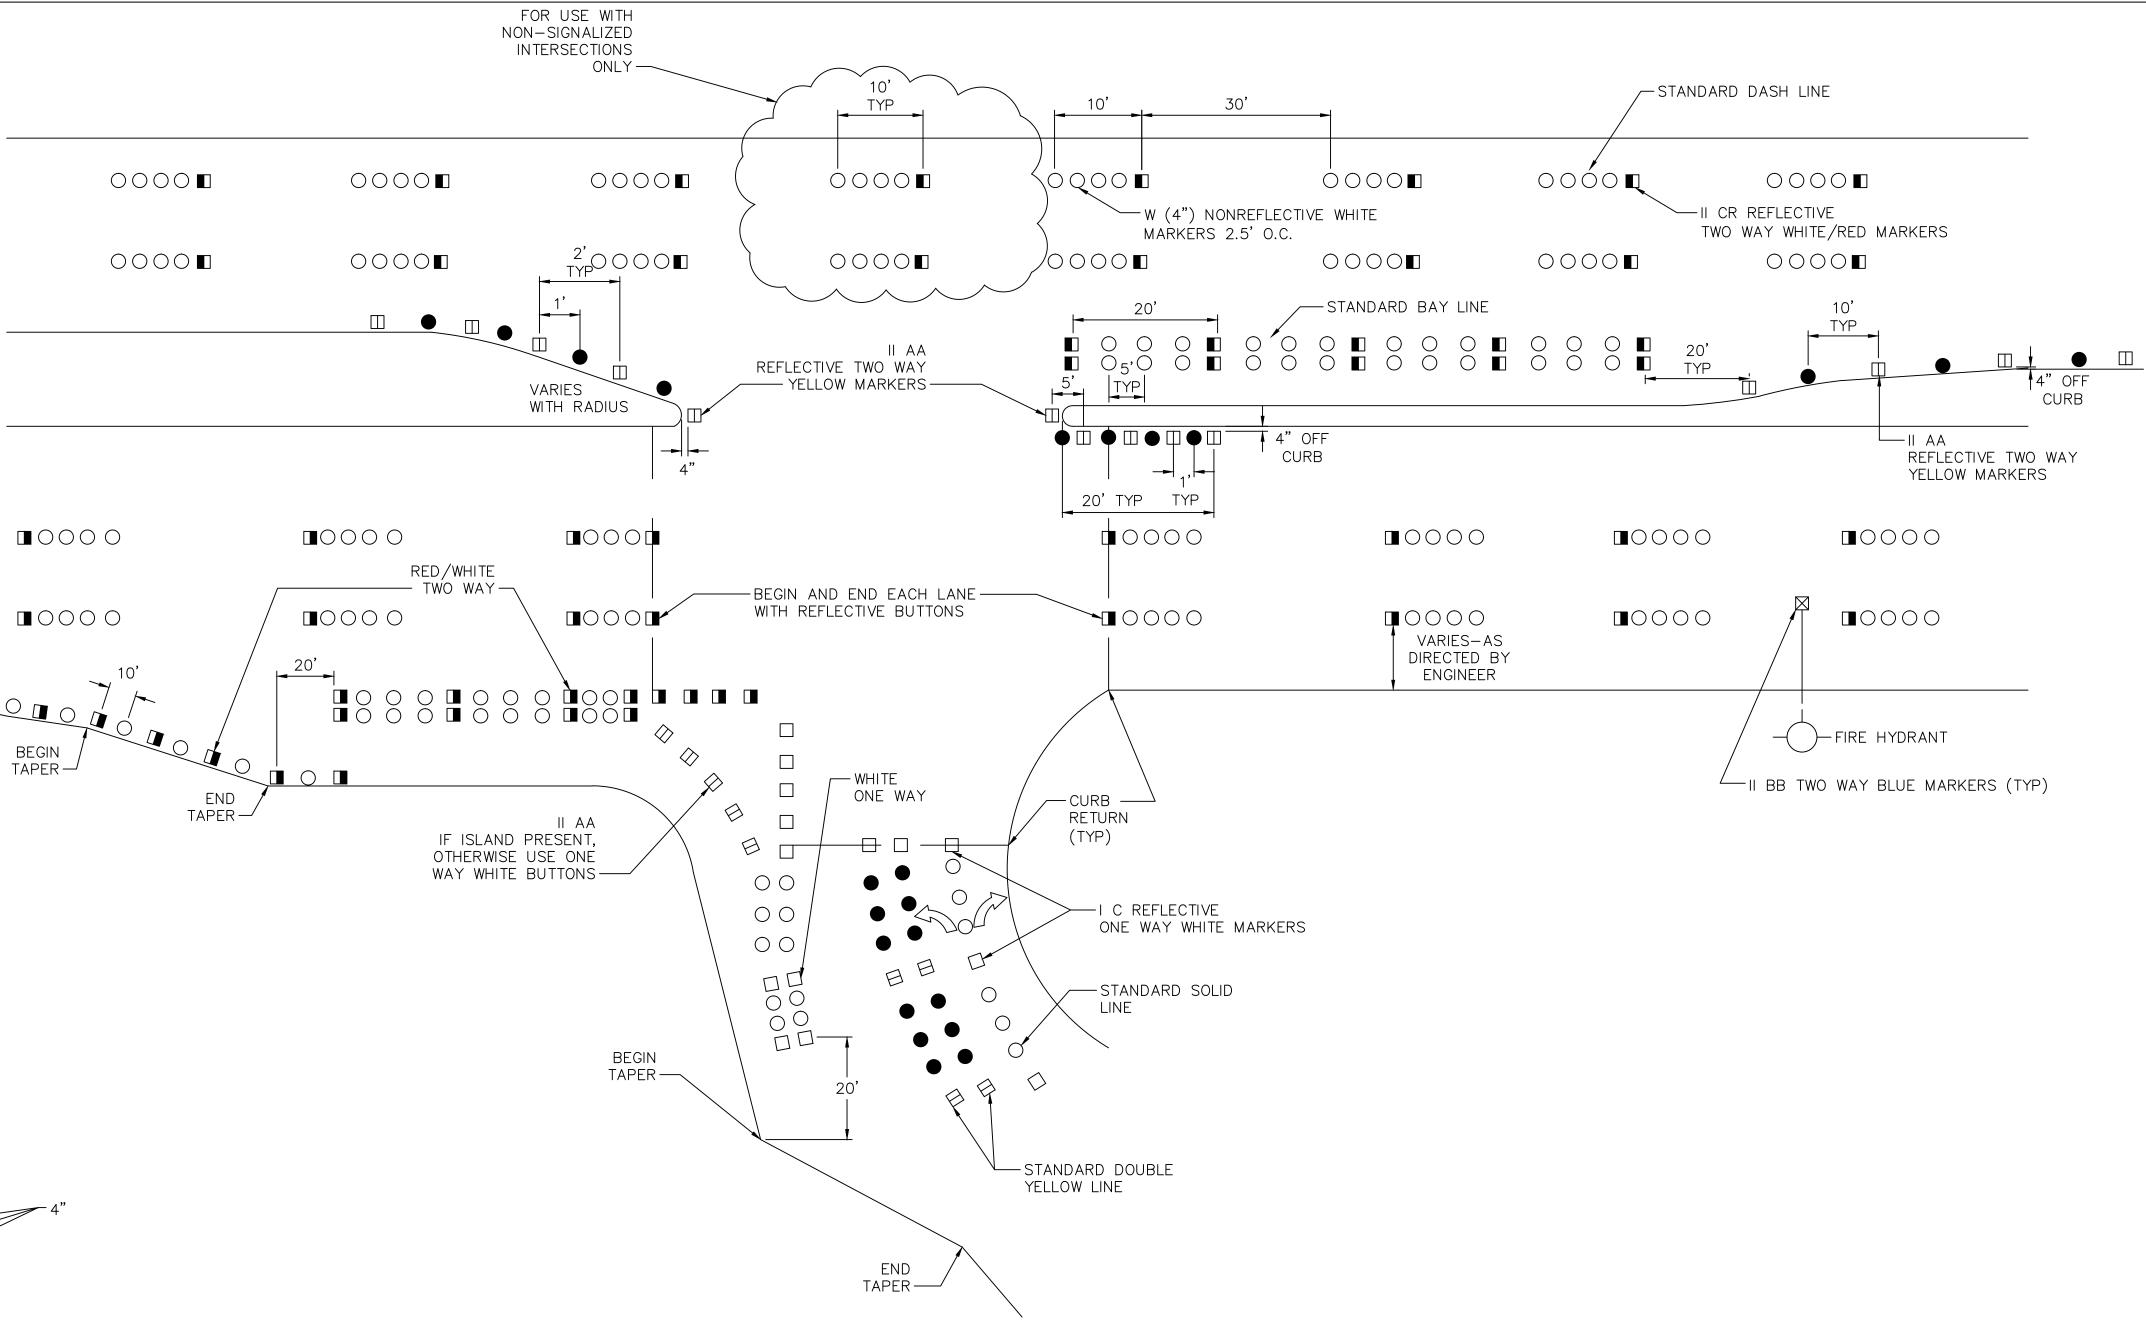


LEGEND

RED/WHITE MARKER

BLUE MARKER

YELLOW MARKER



(AS REQUIRED)

MATERIALS AS PER COR SPECIFICATIONS OR AS DIRECTED BY THE ENGINEER

C.O.R. WILL PROVIDE INITIAL DETAIL ASSISTANCE IN

PAVING MARKING LAYOUT

■ II CR (4" SQUARE) TWO WAY REFLECTIVE

II AA (4" SQUARE) TWO WAY REFLECTIVE YELLOW MARKER

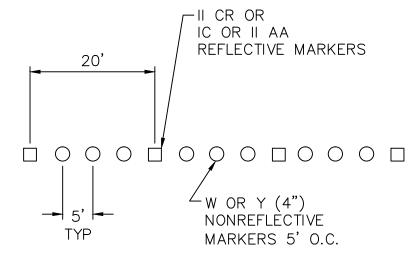
🛛 II BB (4" SQUARE) TWO WAY REFLECTIVE

☐ I C (4" SQUARE) ONE WAY REFLECTIVE WHITE MARKER

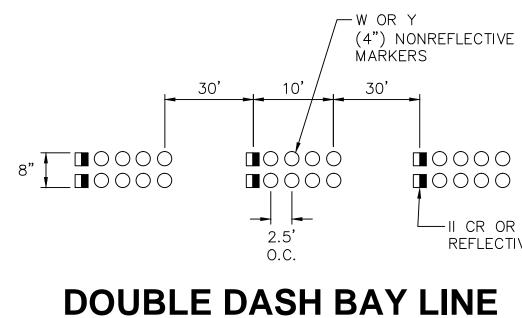
O W (4" ROUND) NON REFLECTIVE WHITE MARKER

● Y (4" ROUND) NON REFLECTIVE

CITY OF RICHARDSON RAISED MARKINGS STANDARD DETAIL



STANDARD SOLID LINE

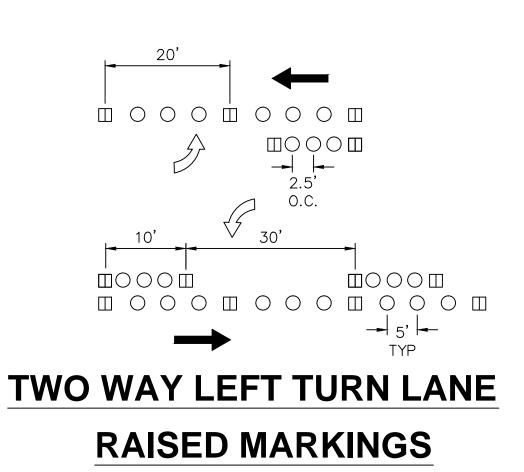


CATCH LANES

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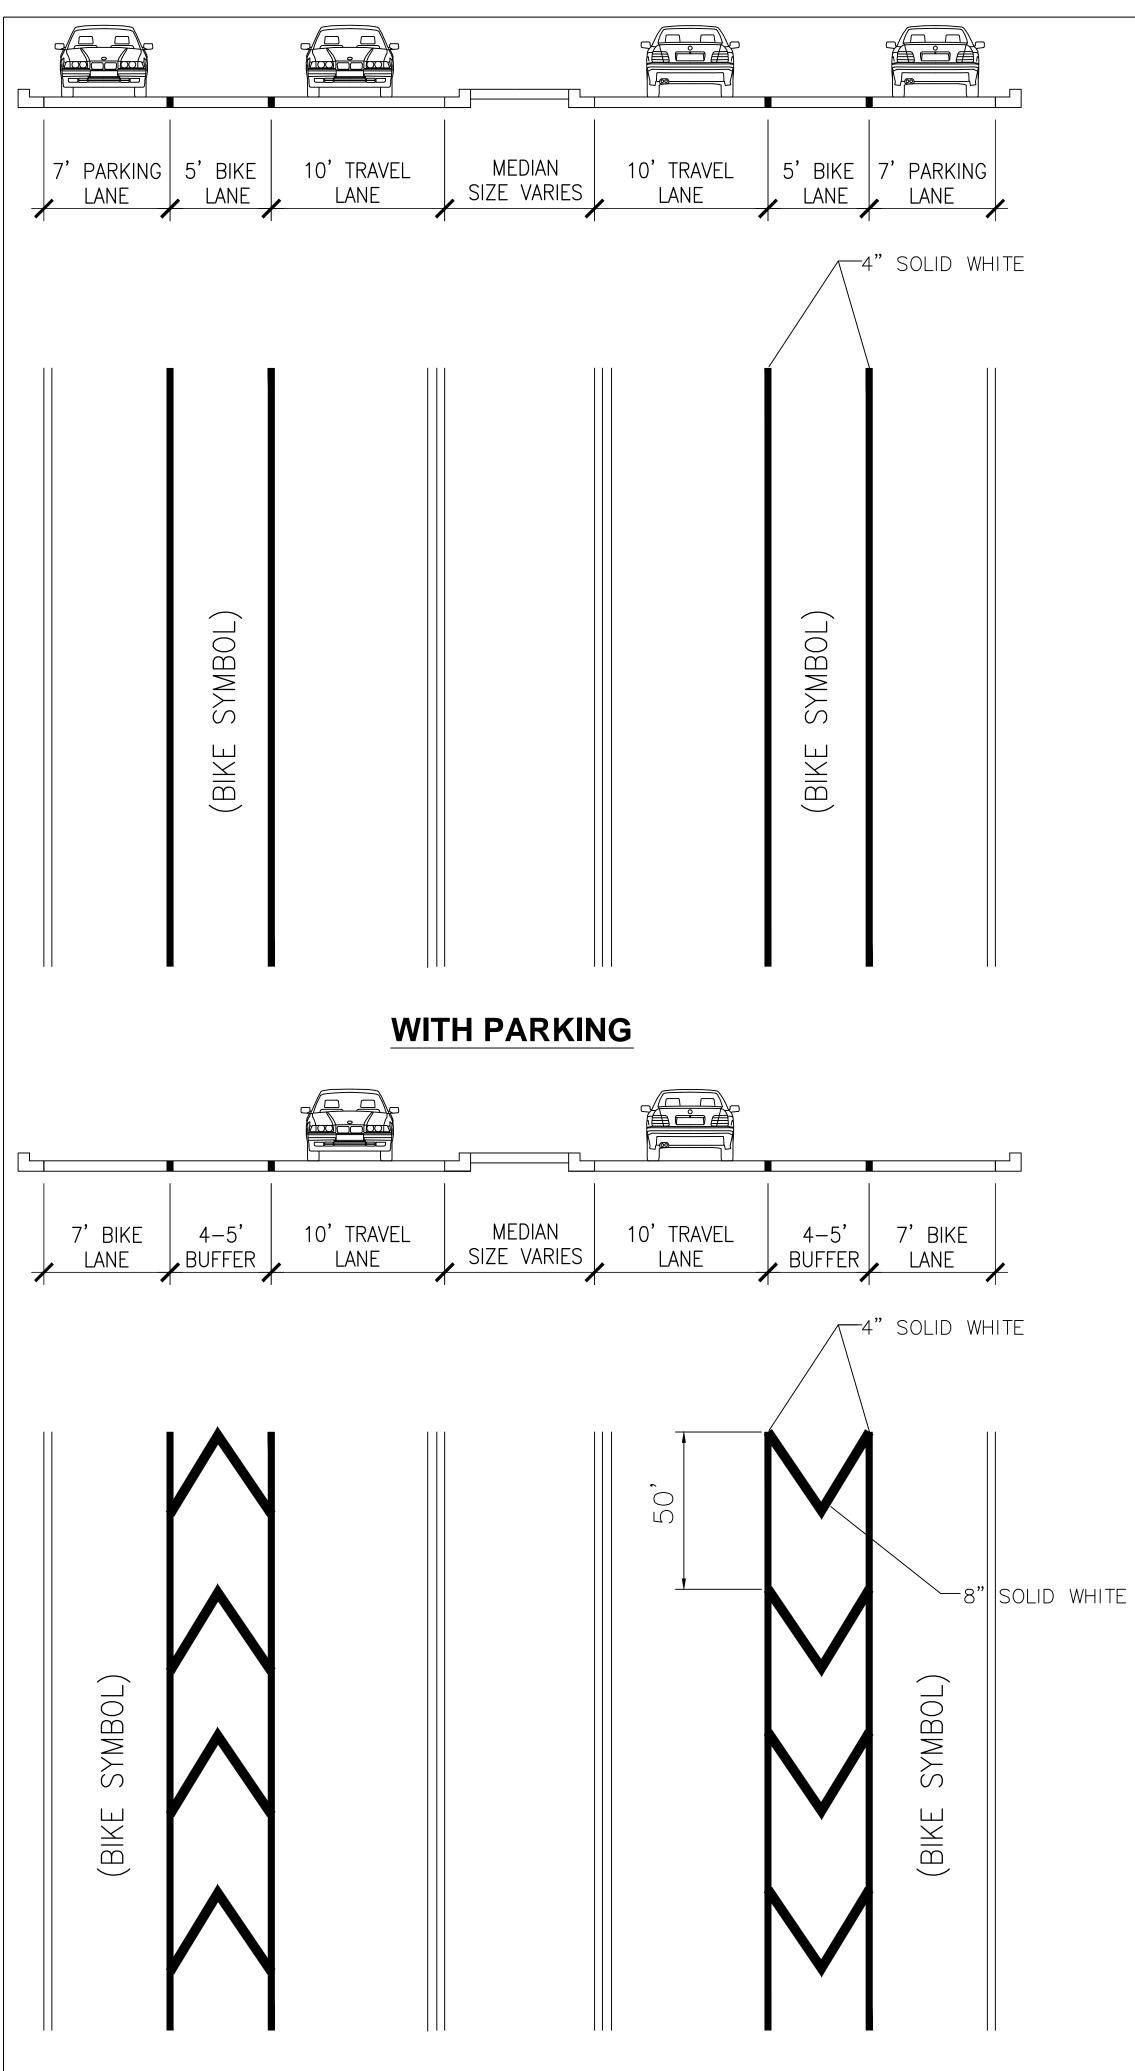
> REFLECTIVE MARKERS

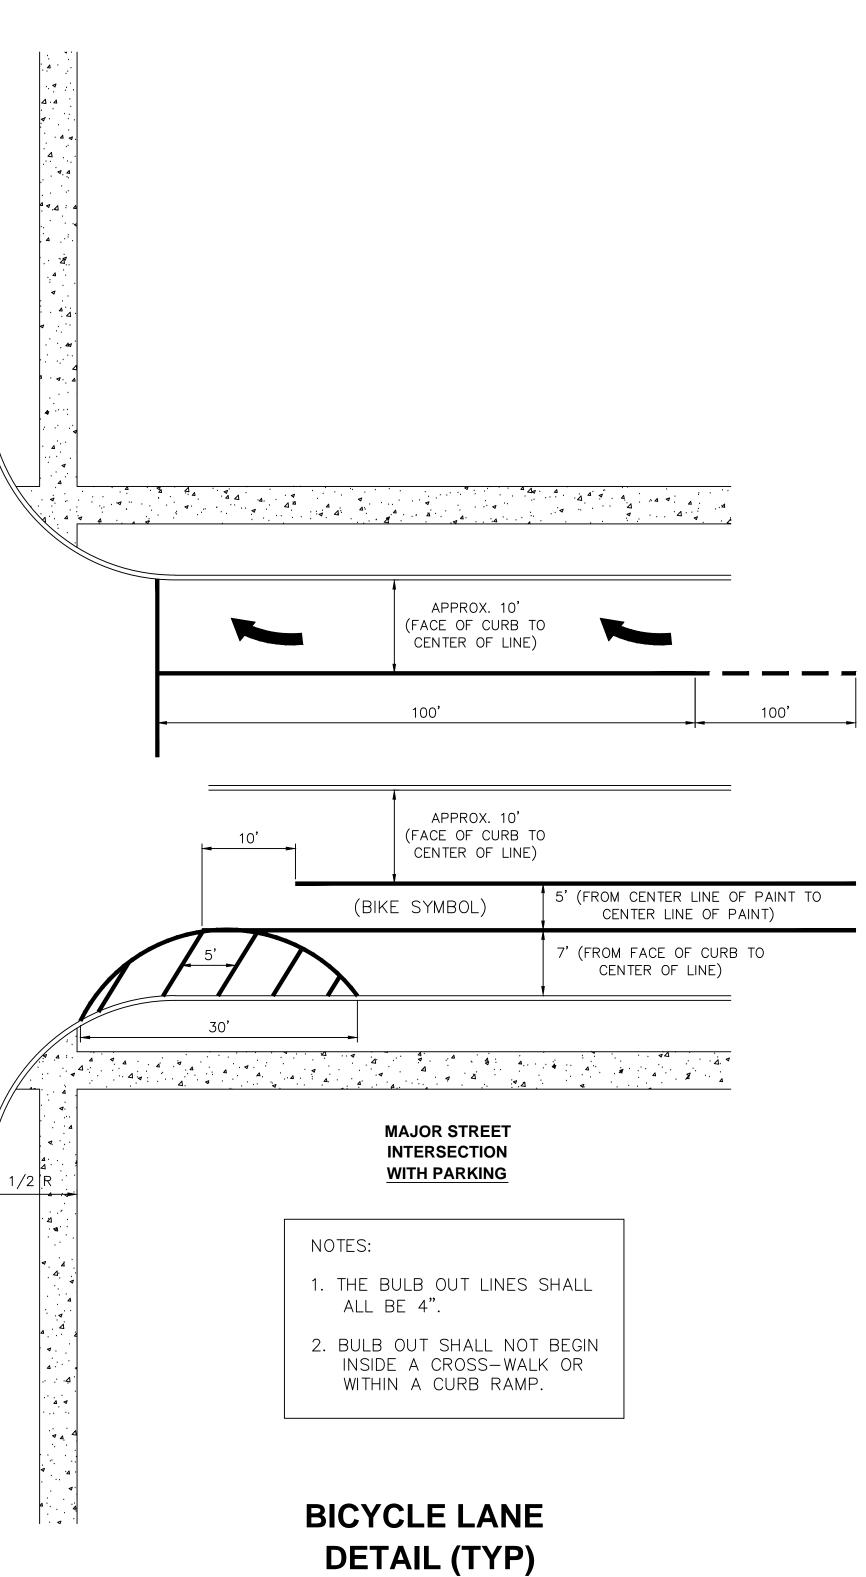




Revisions:	
City of Richar 411 W. Arapaho R	
Suite 204 Richardson, Texas voice: 972 74-	75080 4-4280
fax: 972 744 Drawn By: Checked By:	4-5804 RGB COR
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CITY OF RICHARDSON TEXAS	
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BY CITY OF RICHARD	SON
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	I

WITHOUT PARKING

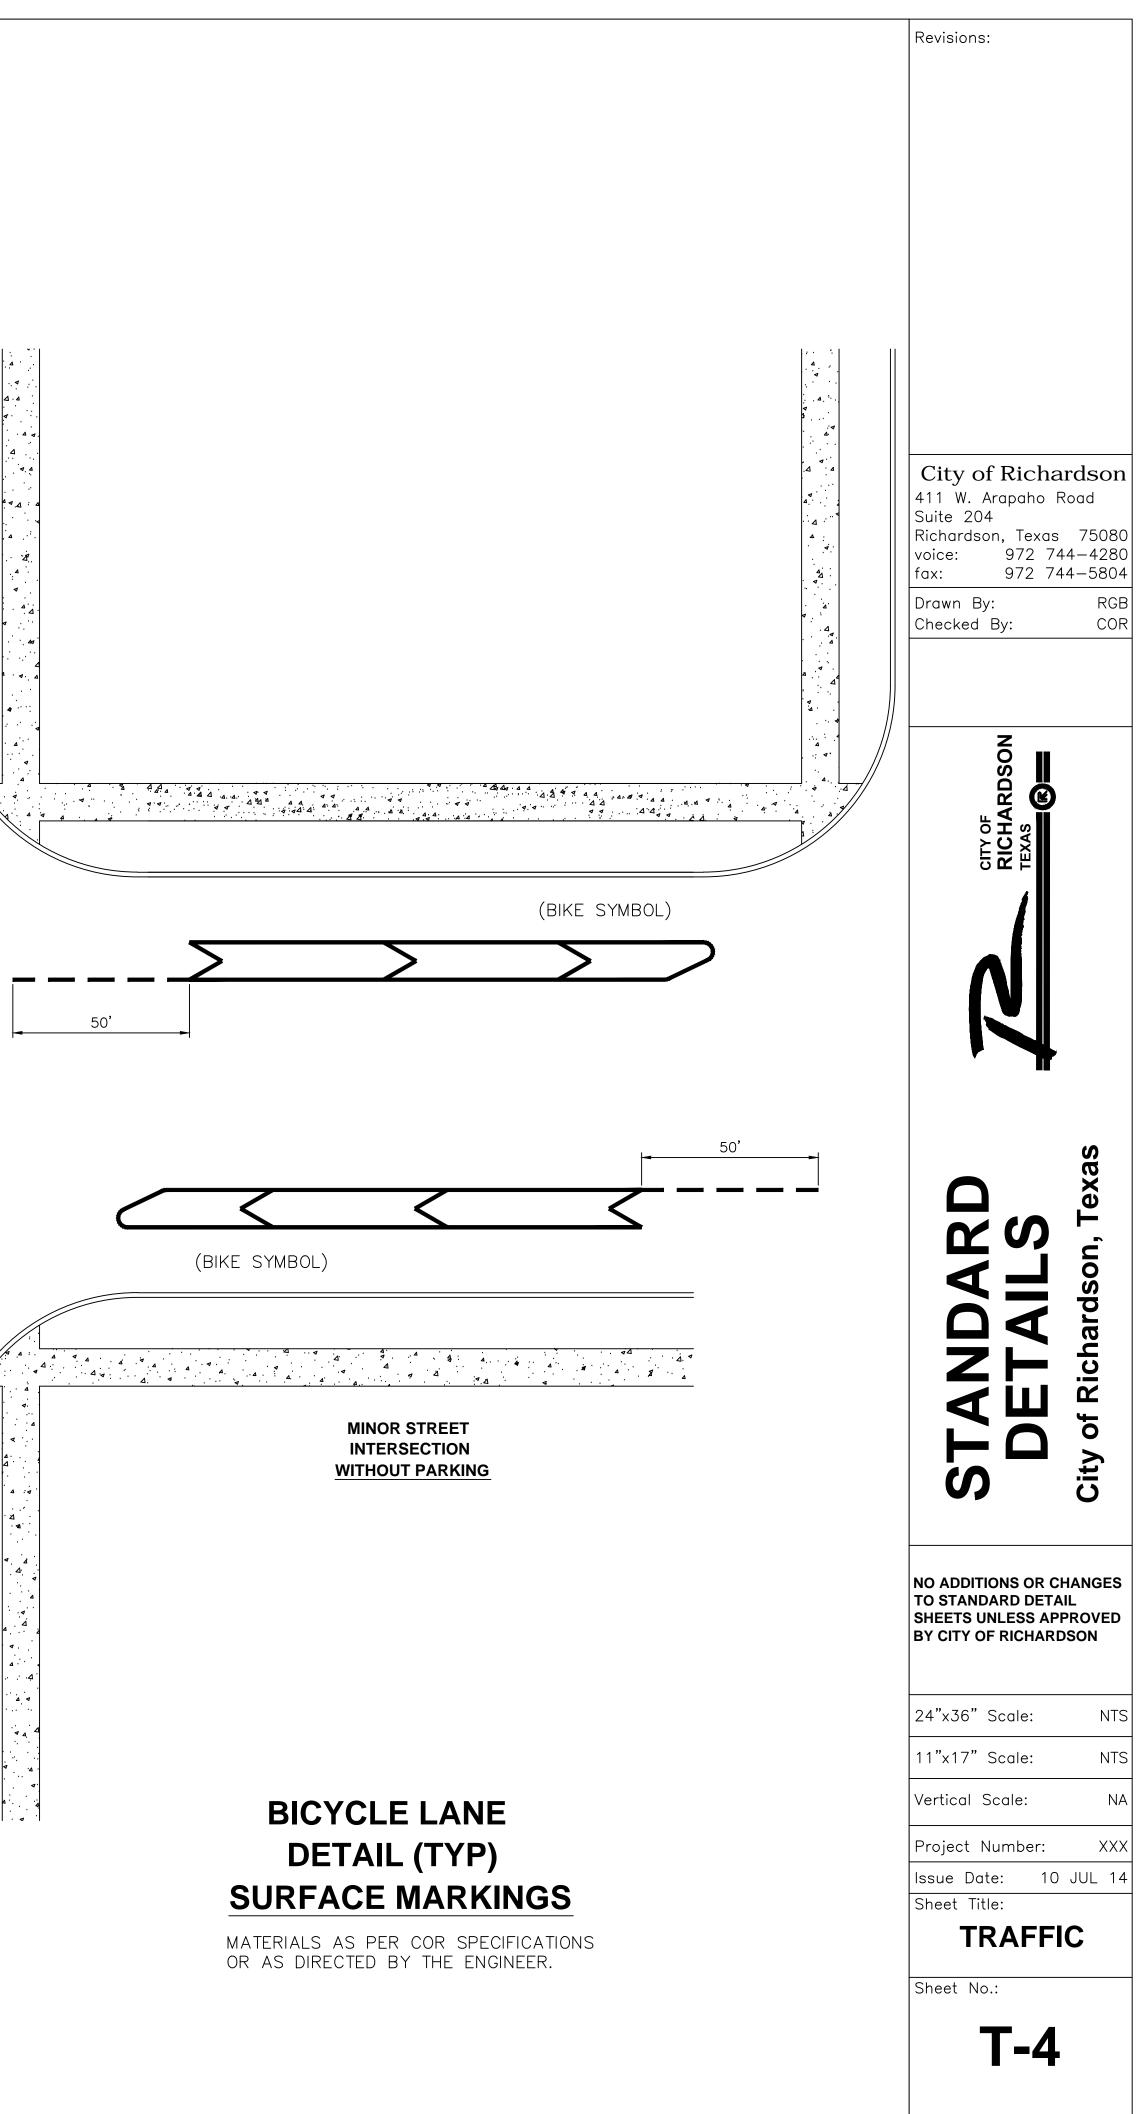


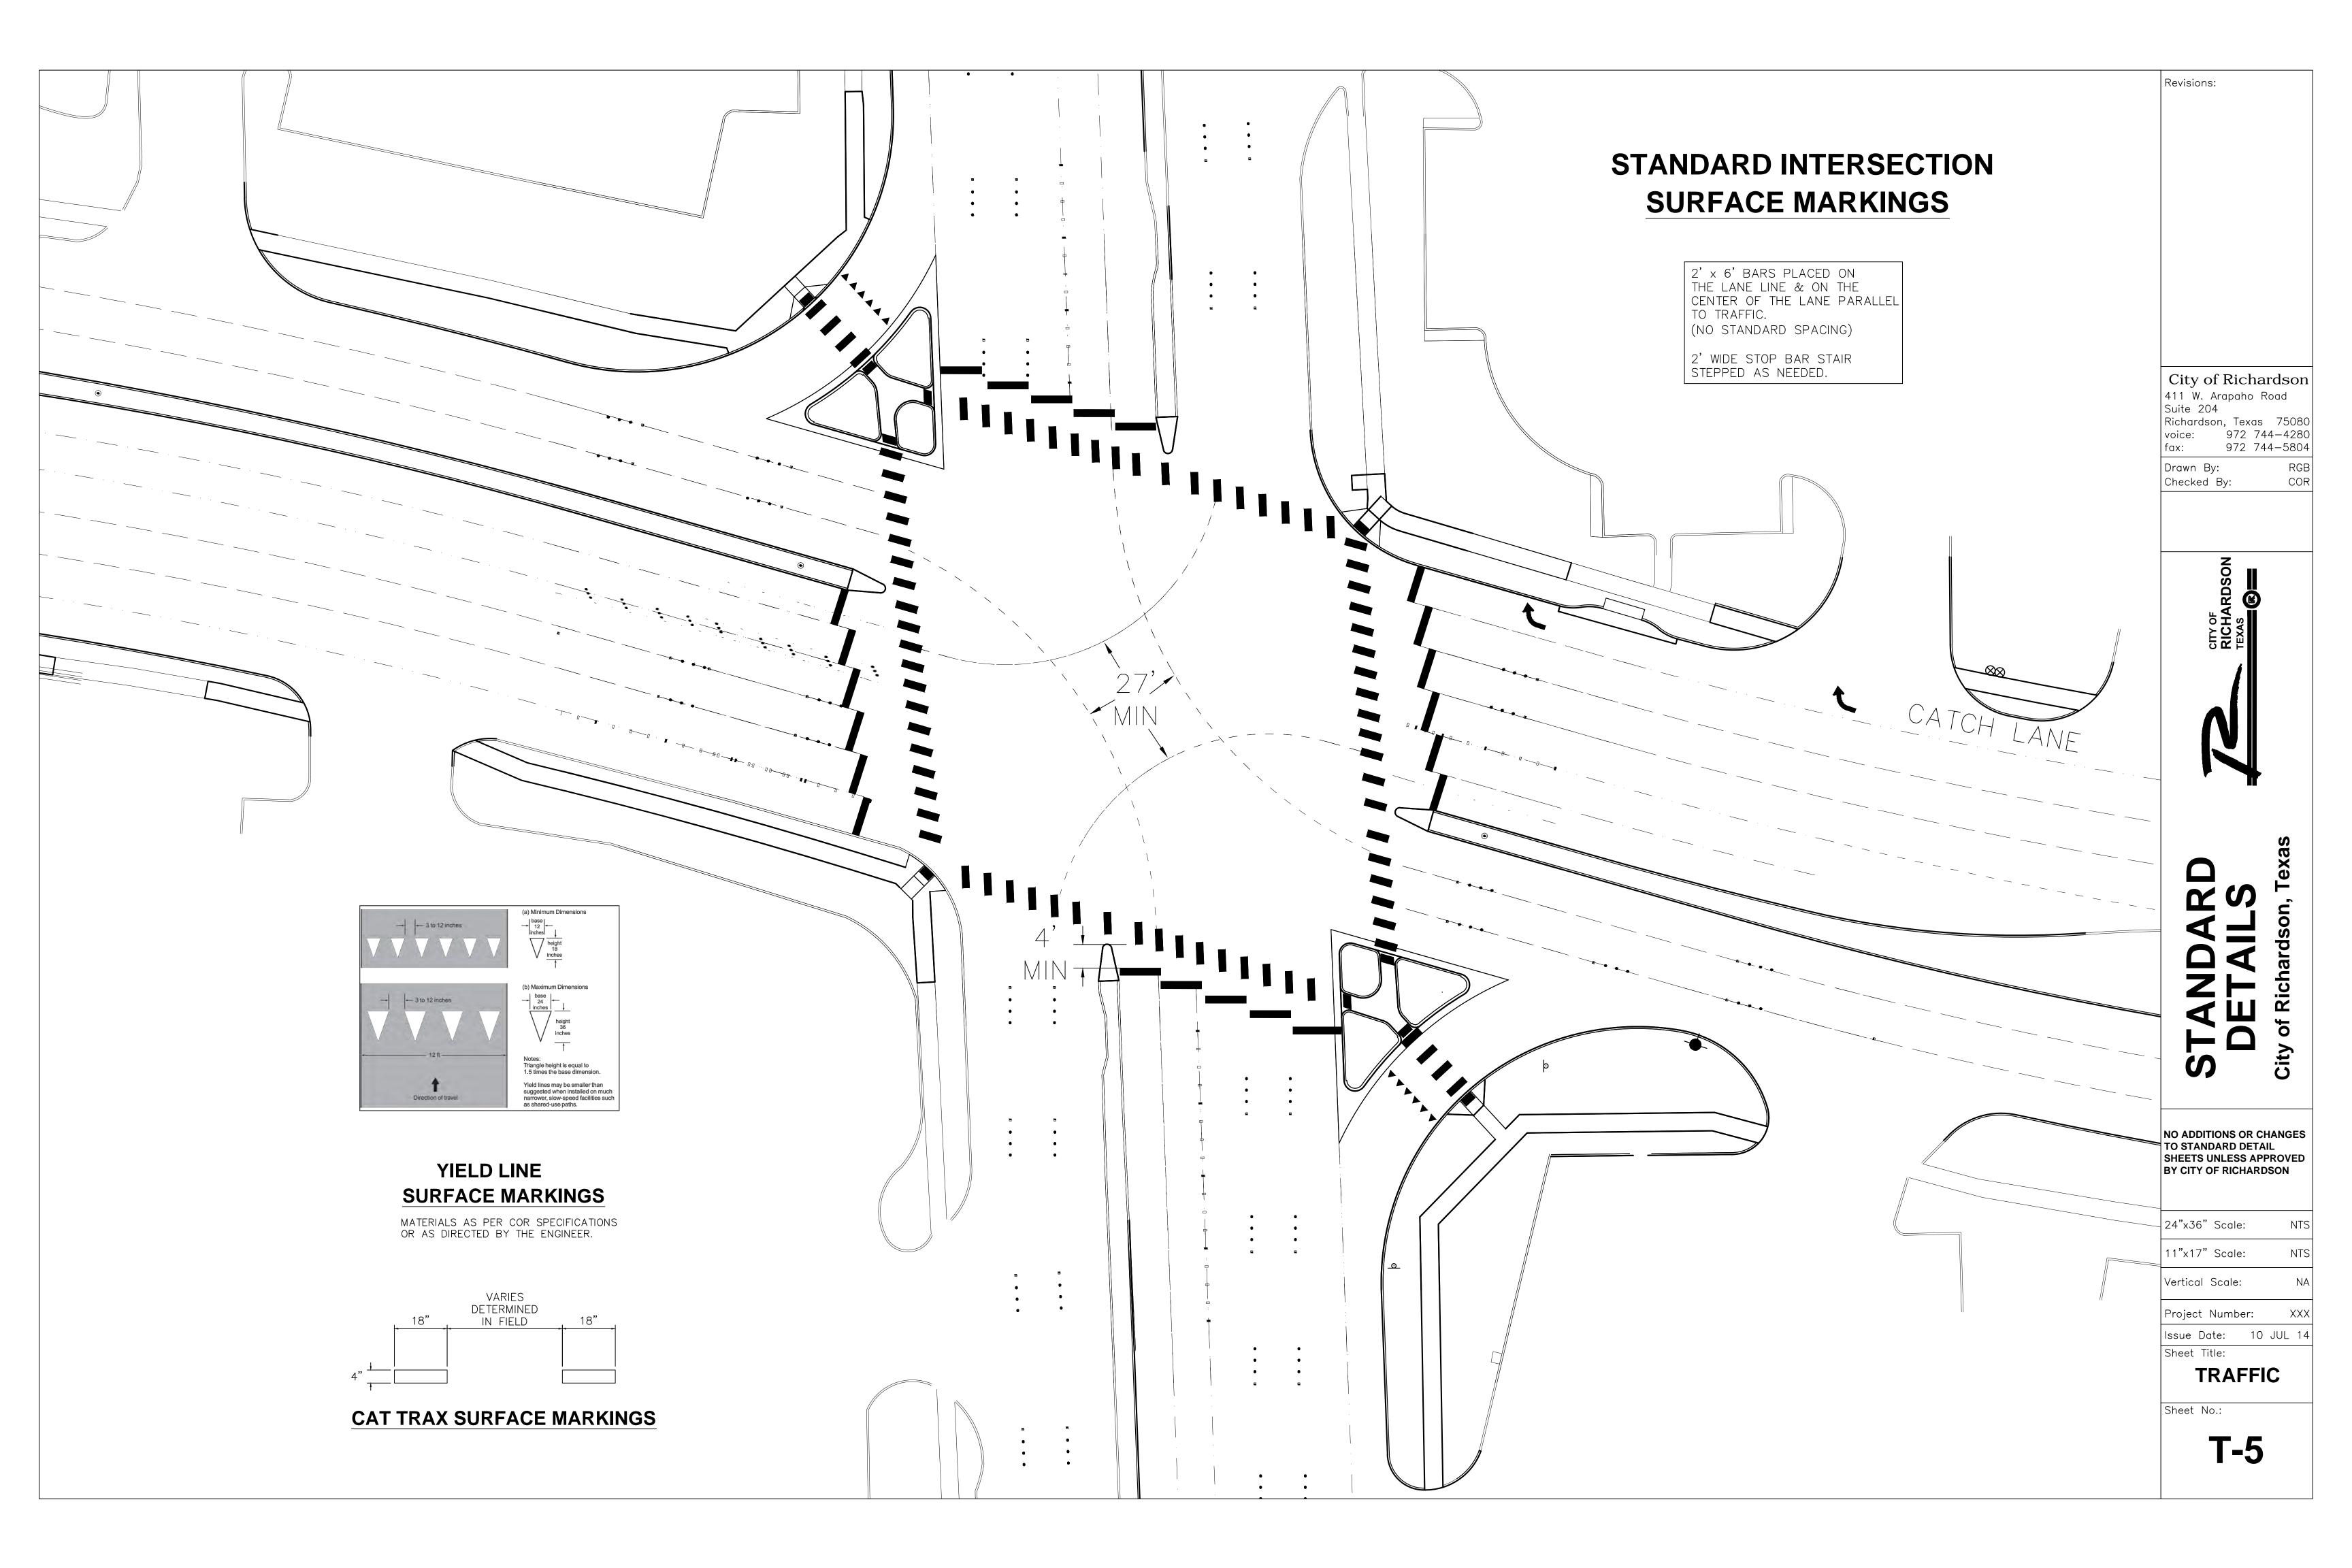


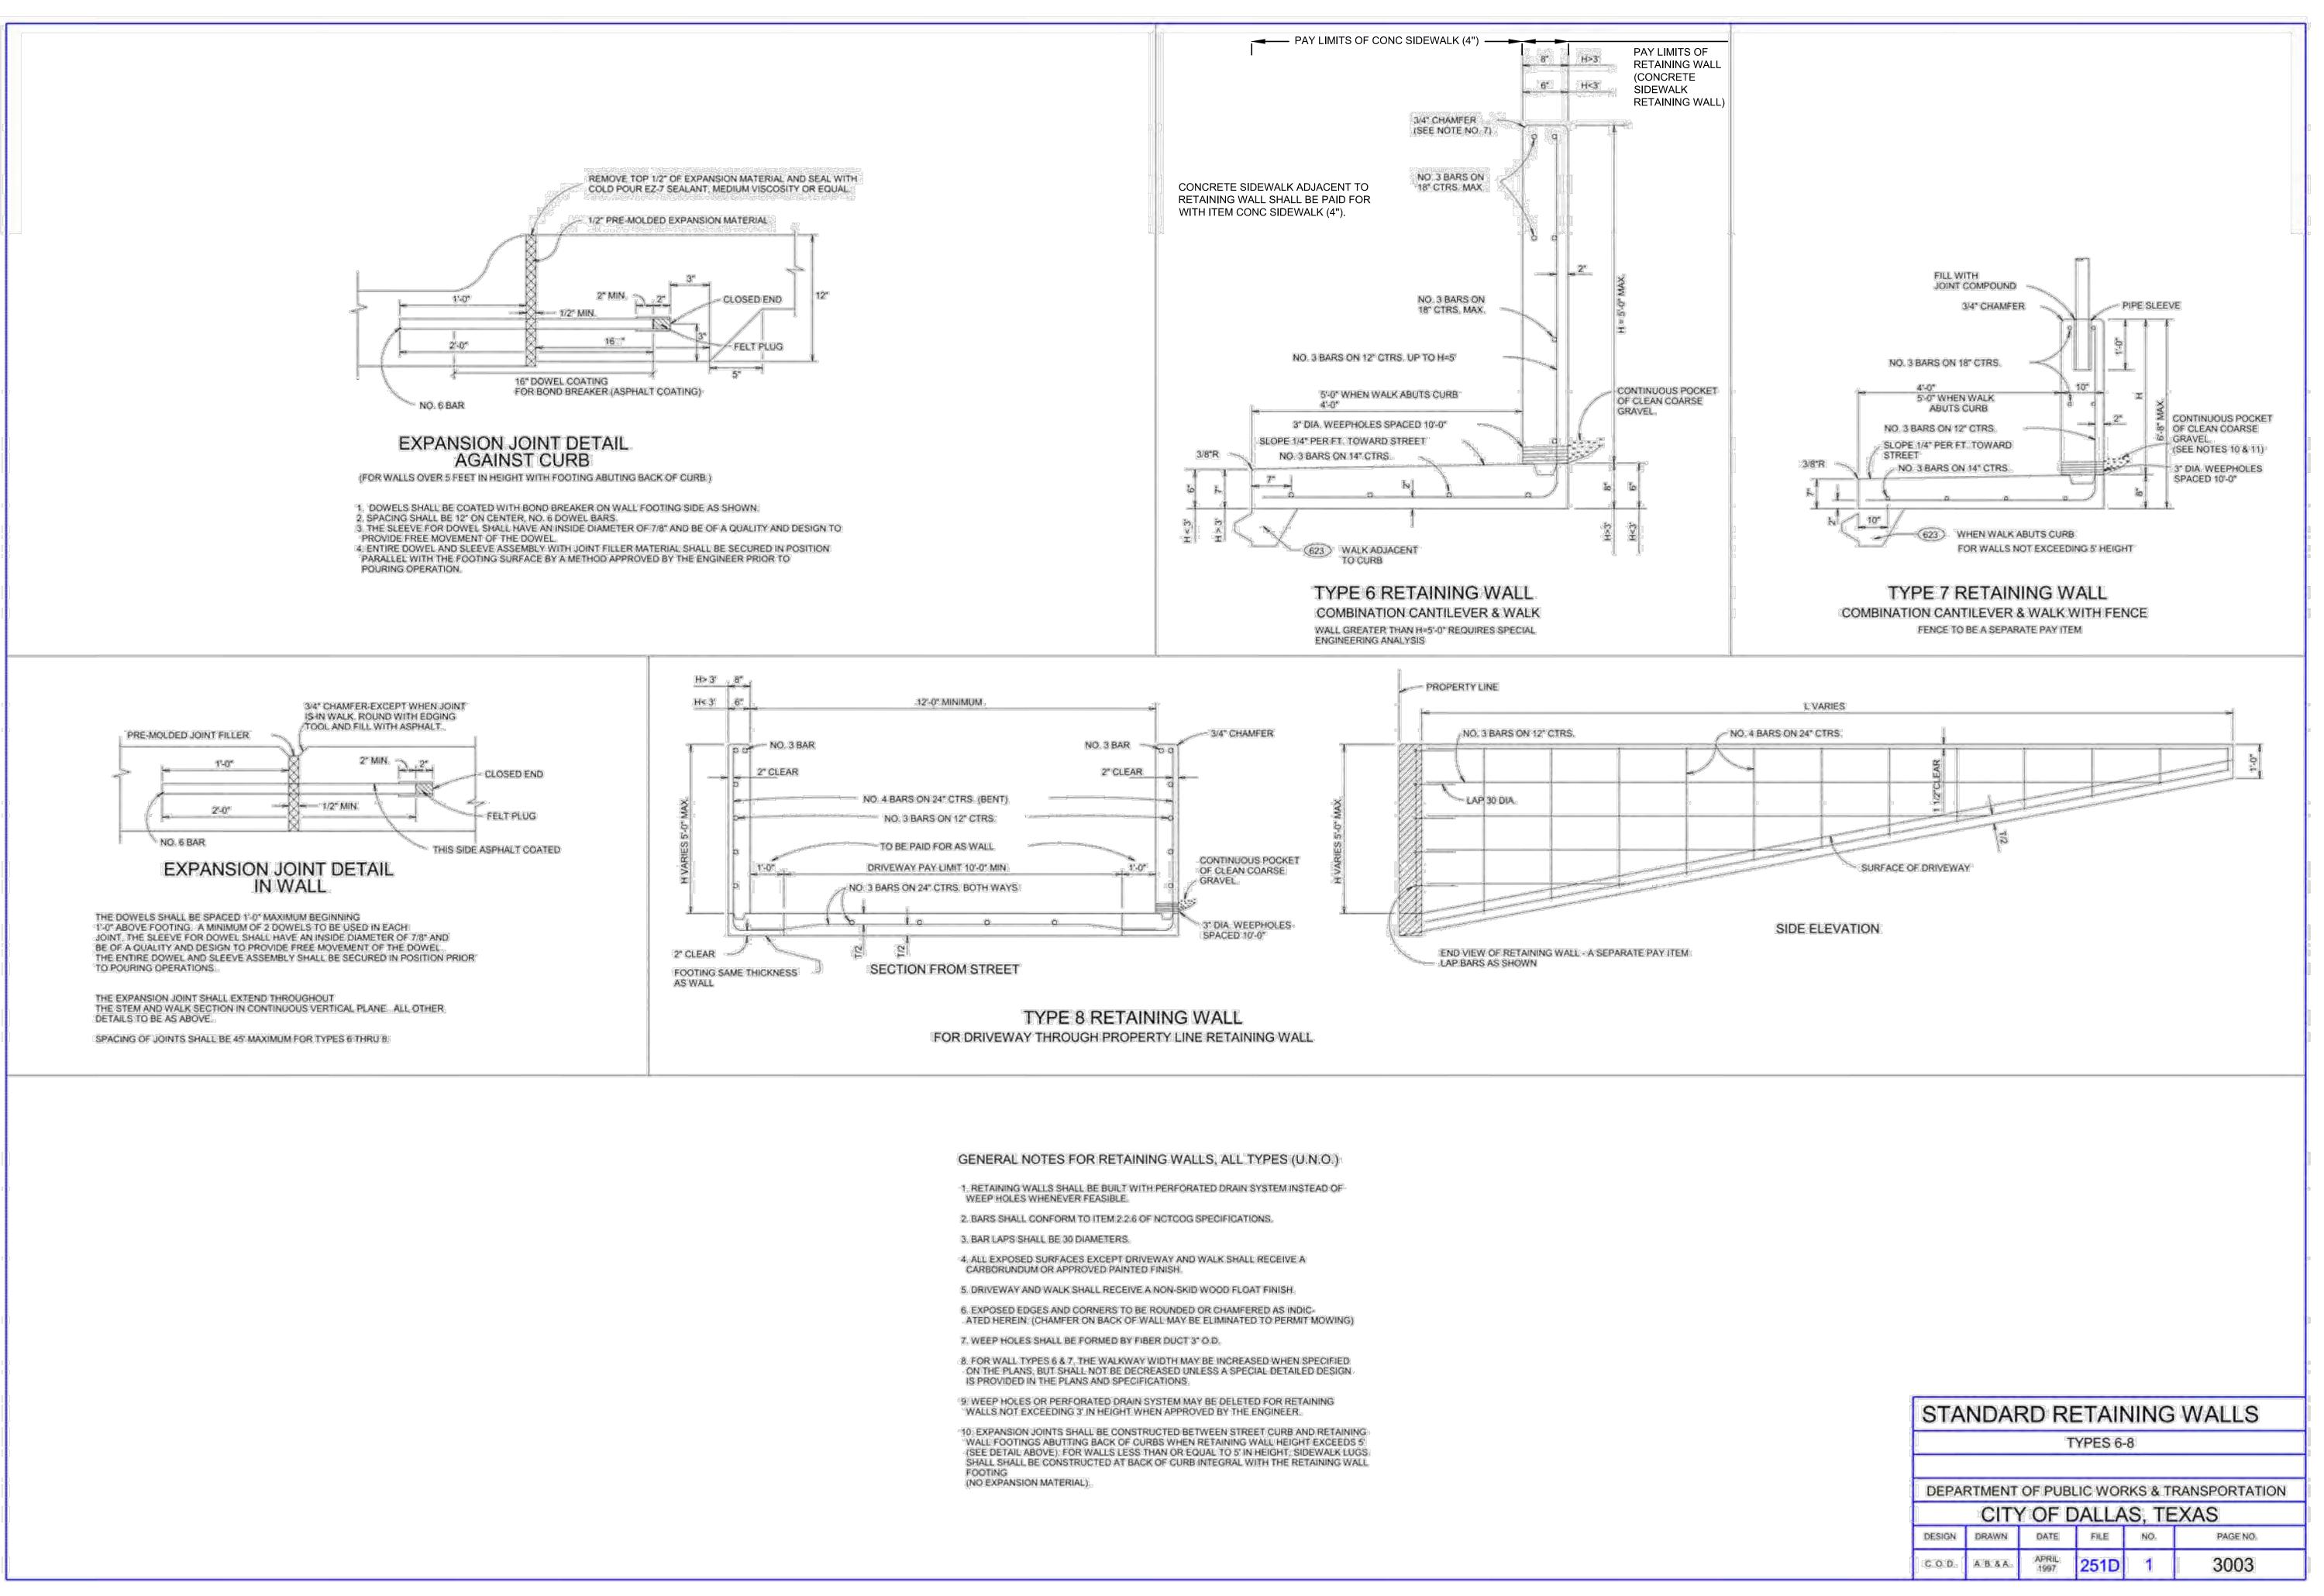
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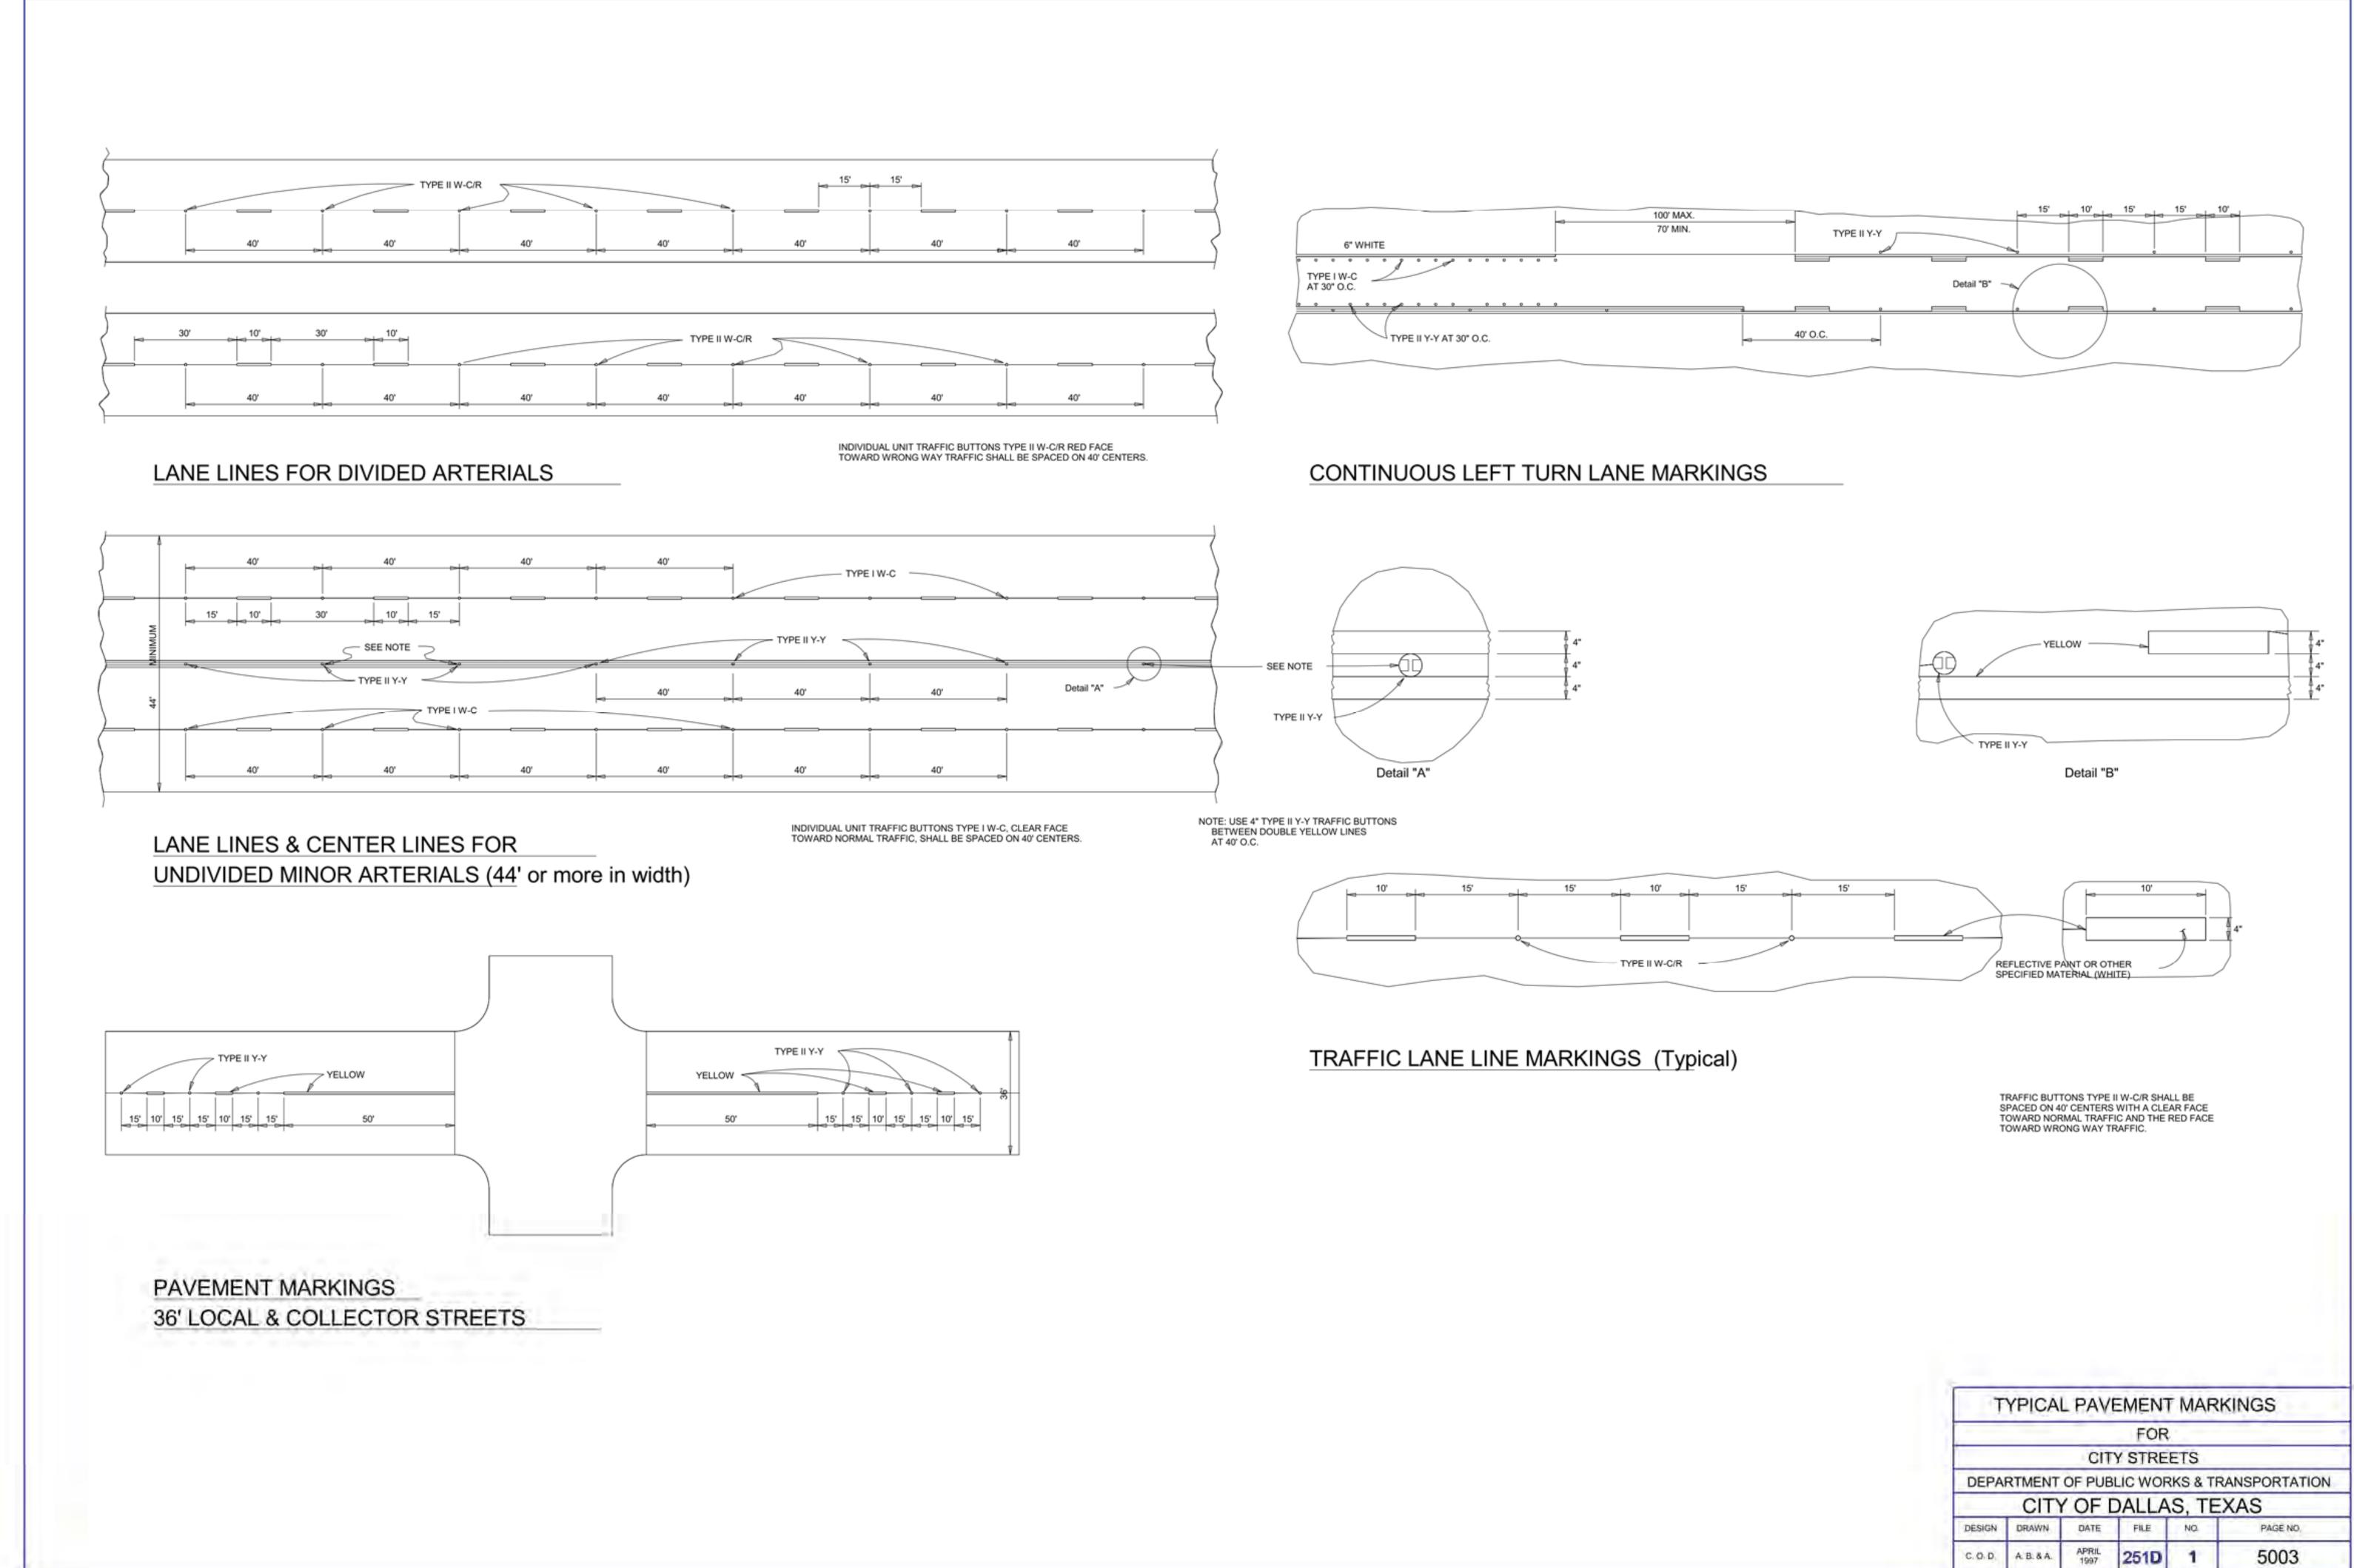
SURFACE MARKINGS

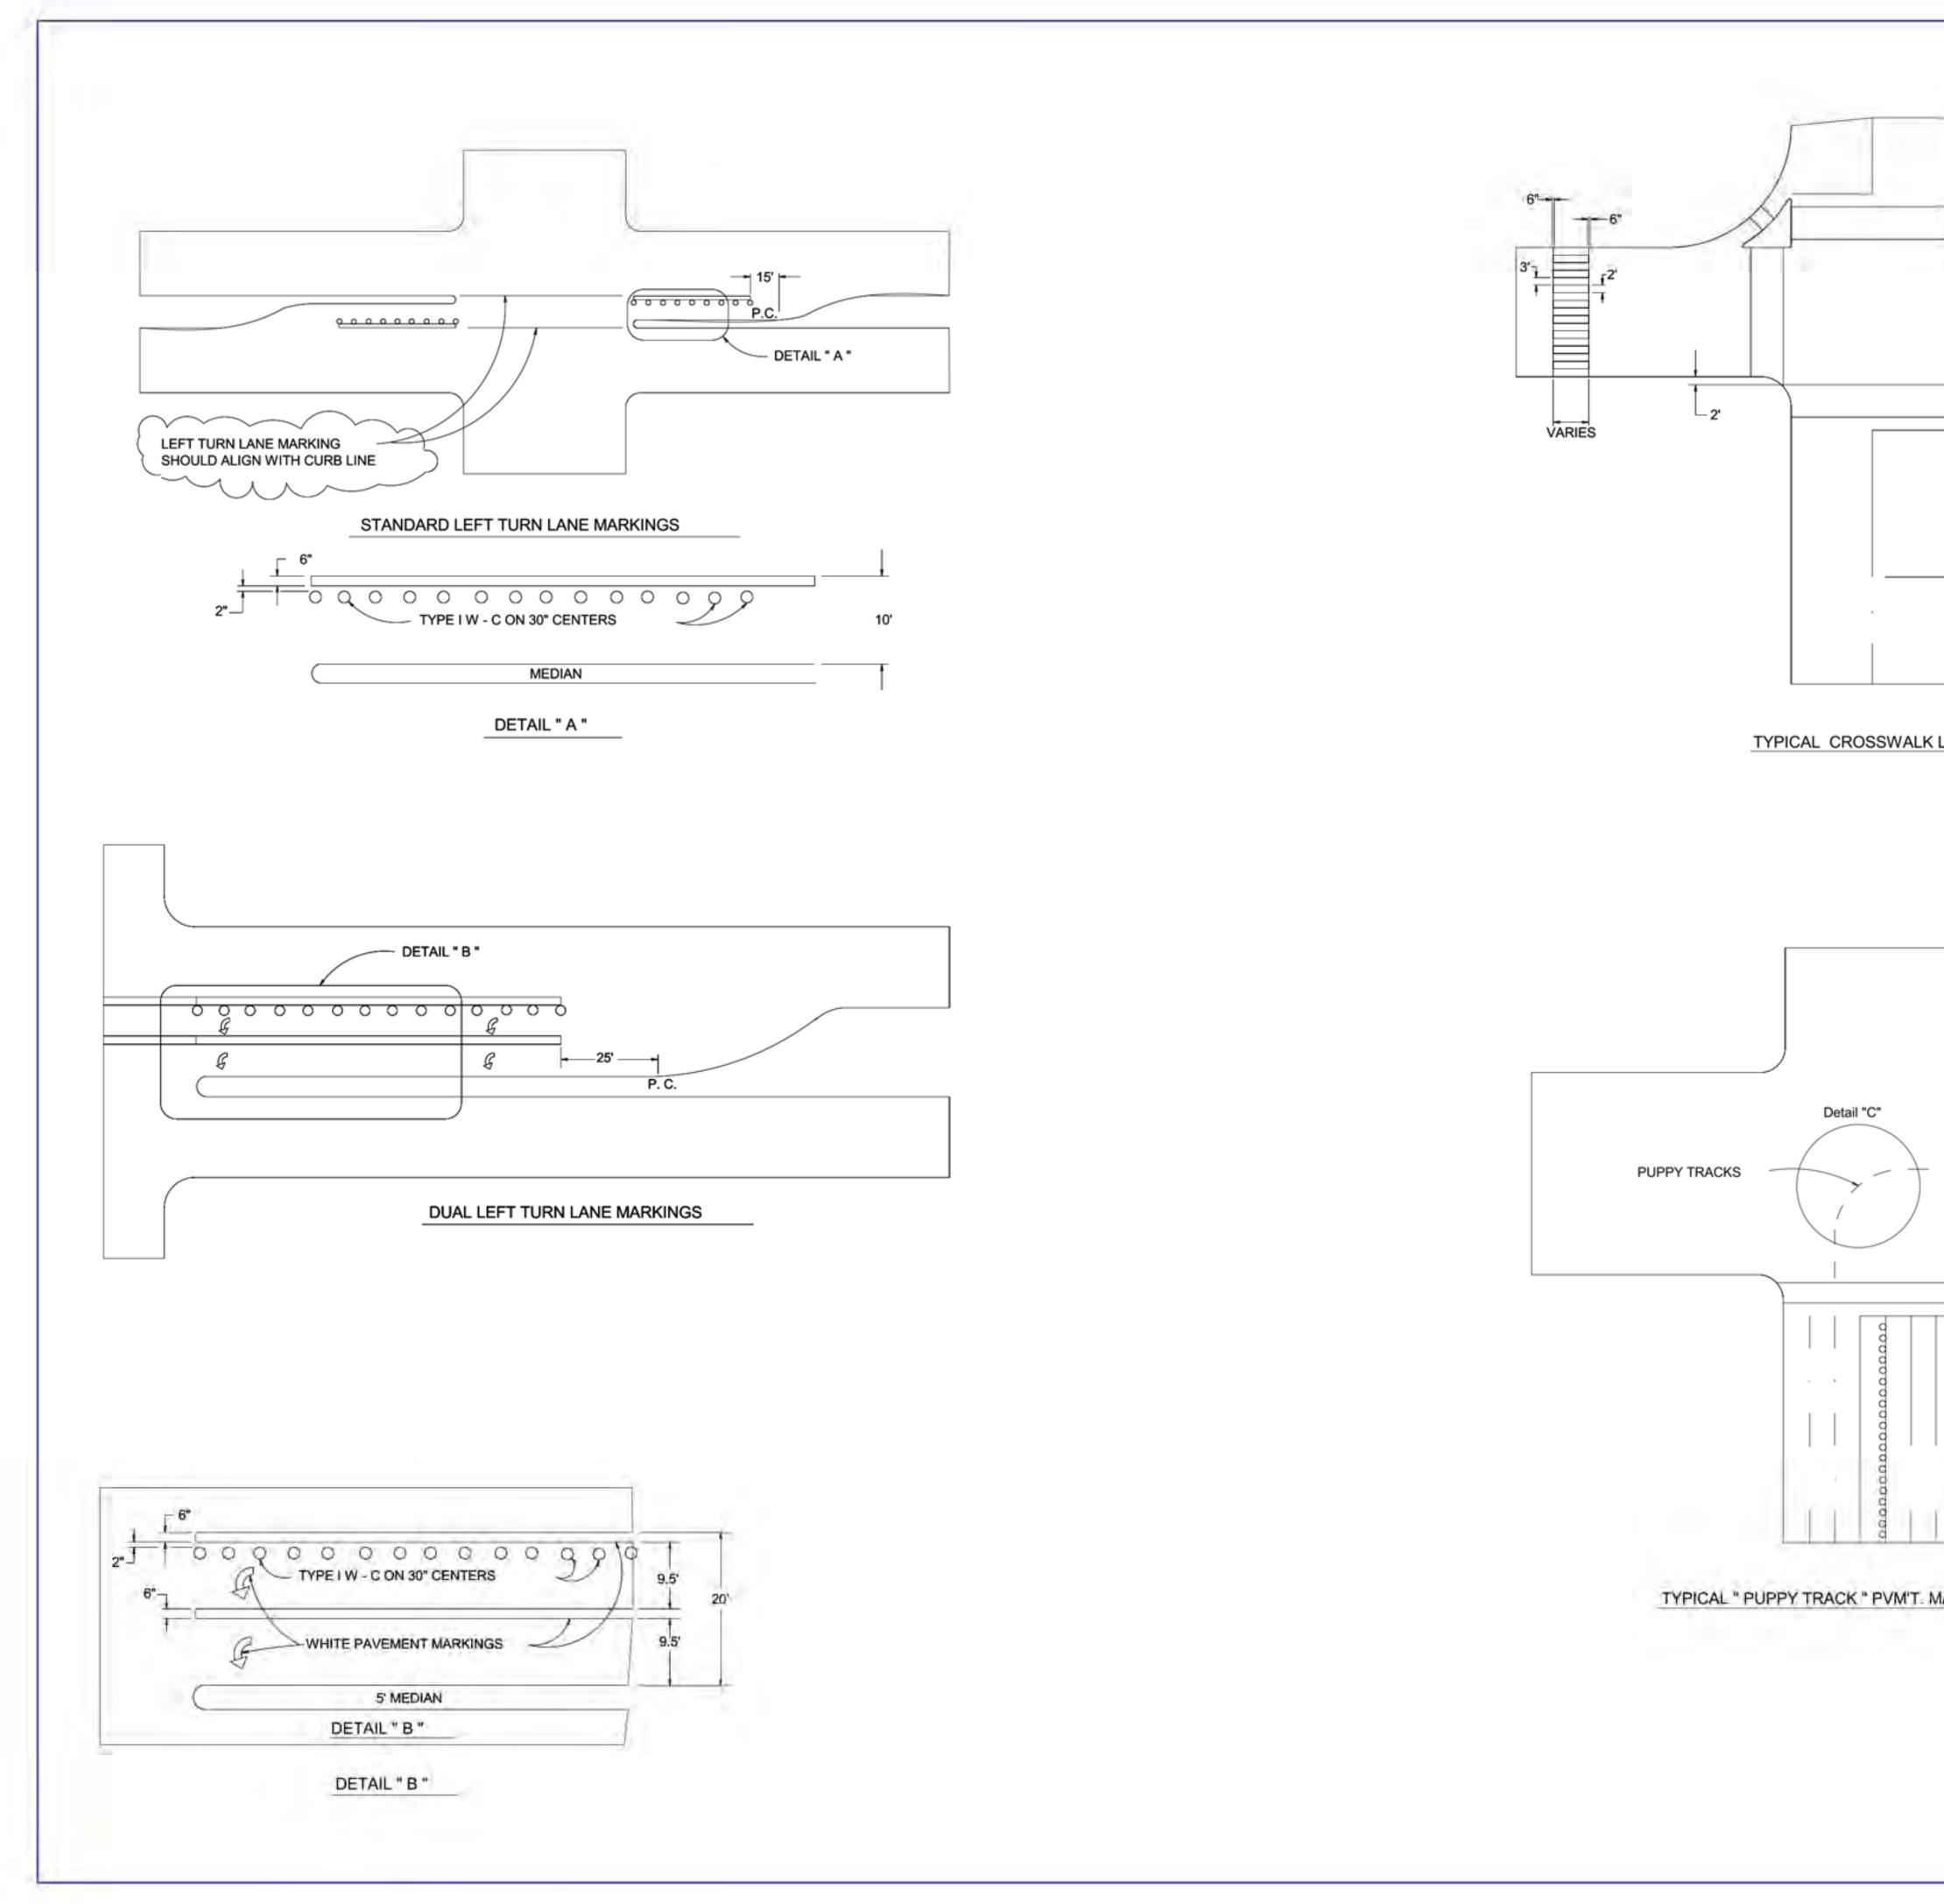
MATERIALS AS PER COR SPECIFICATIONS OR AS DIRECTED BY THE ENGINEER.



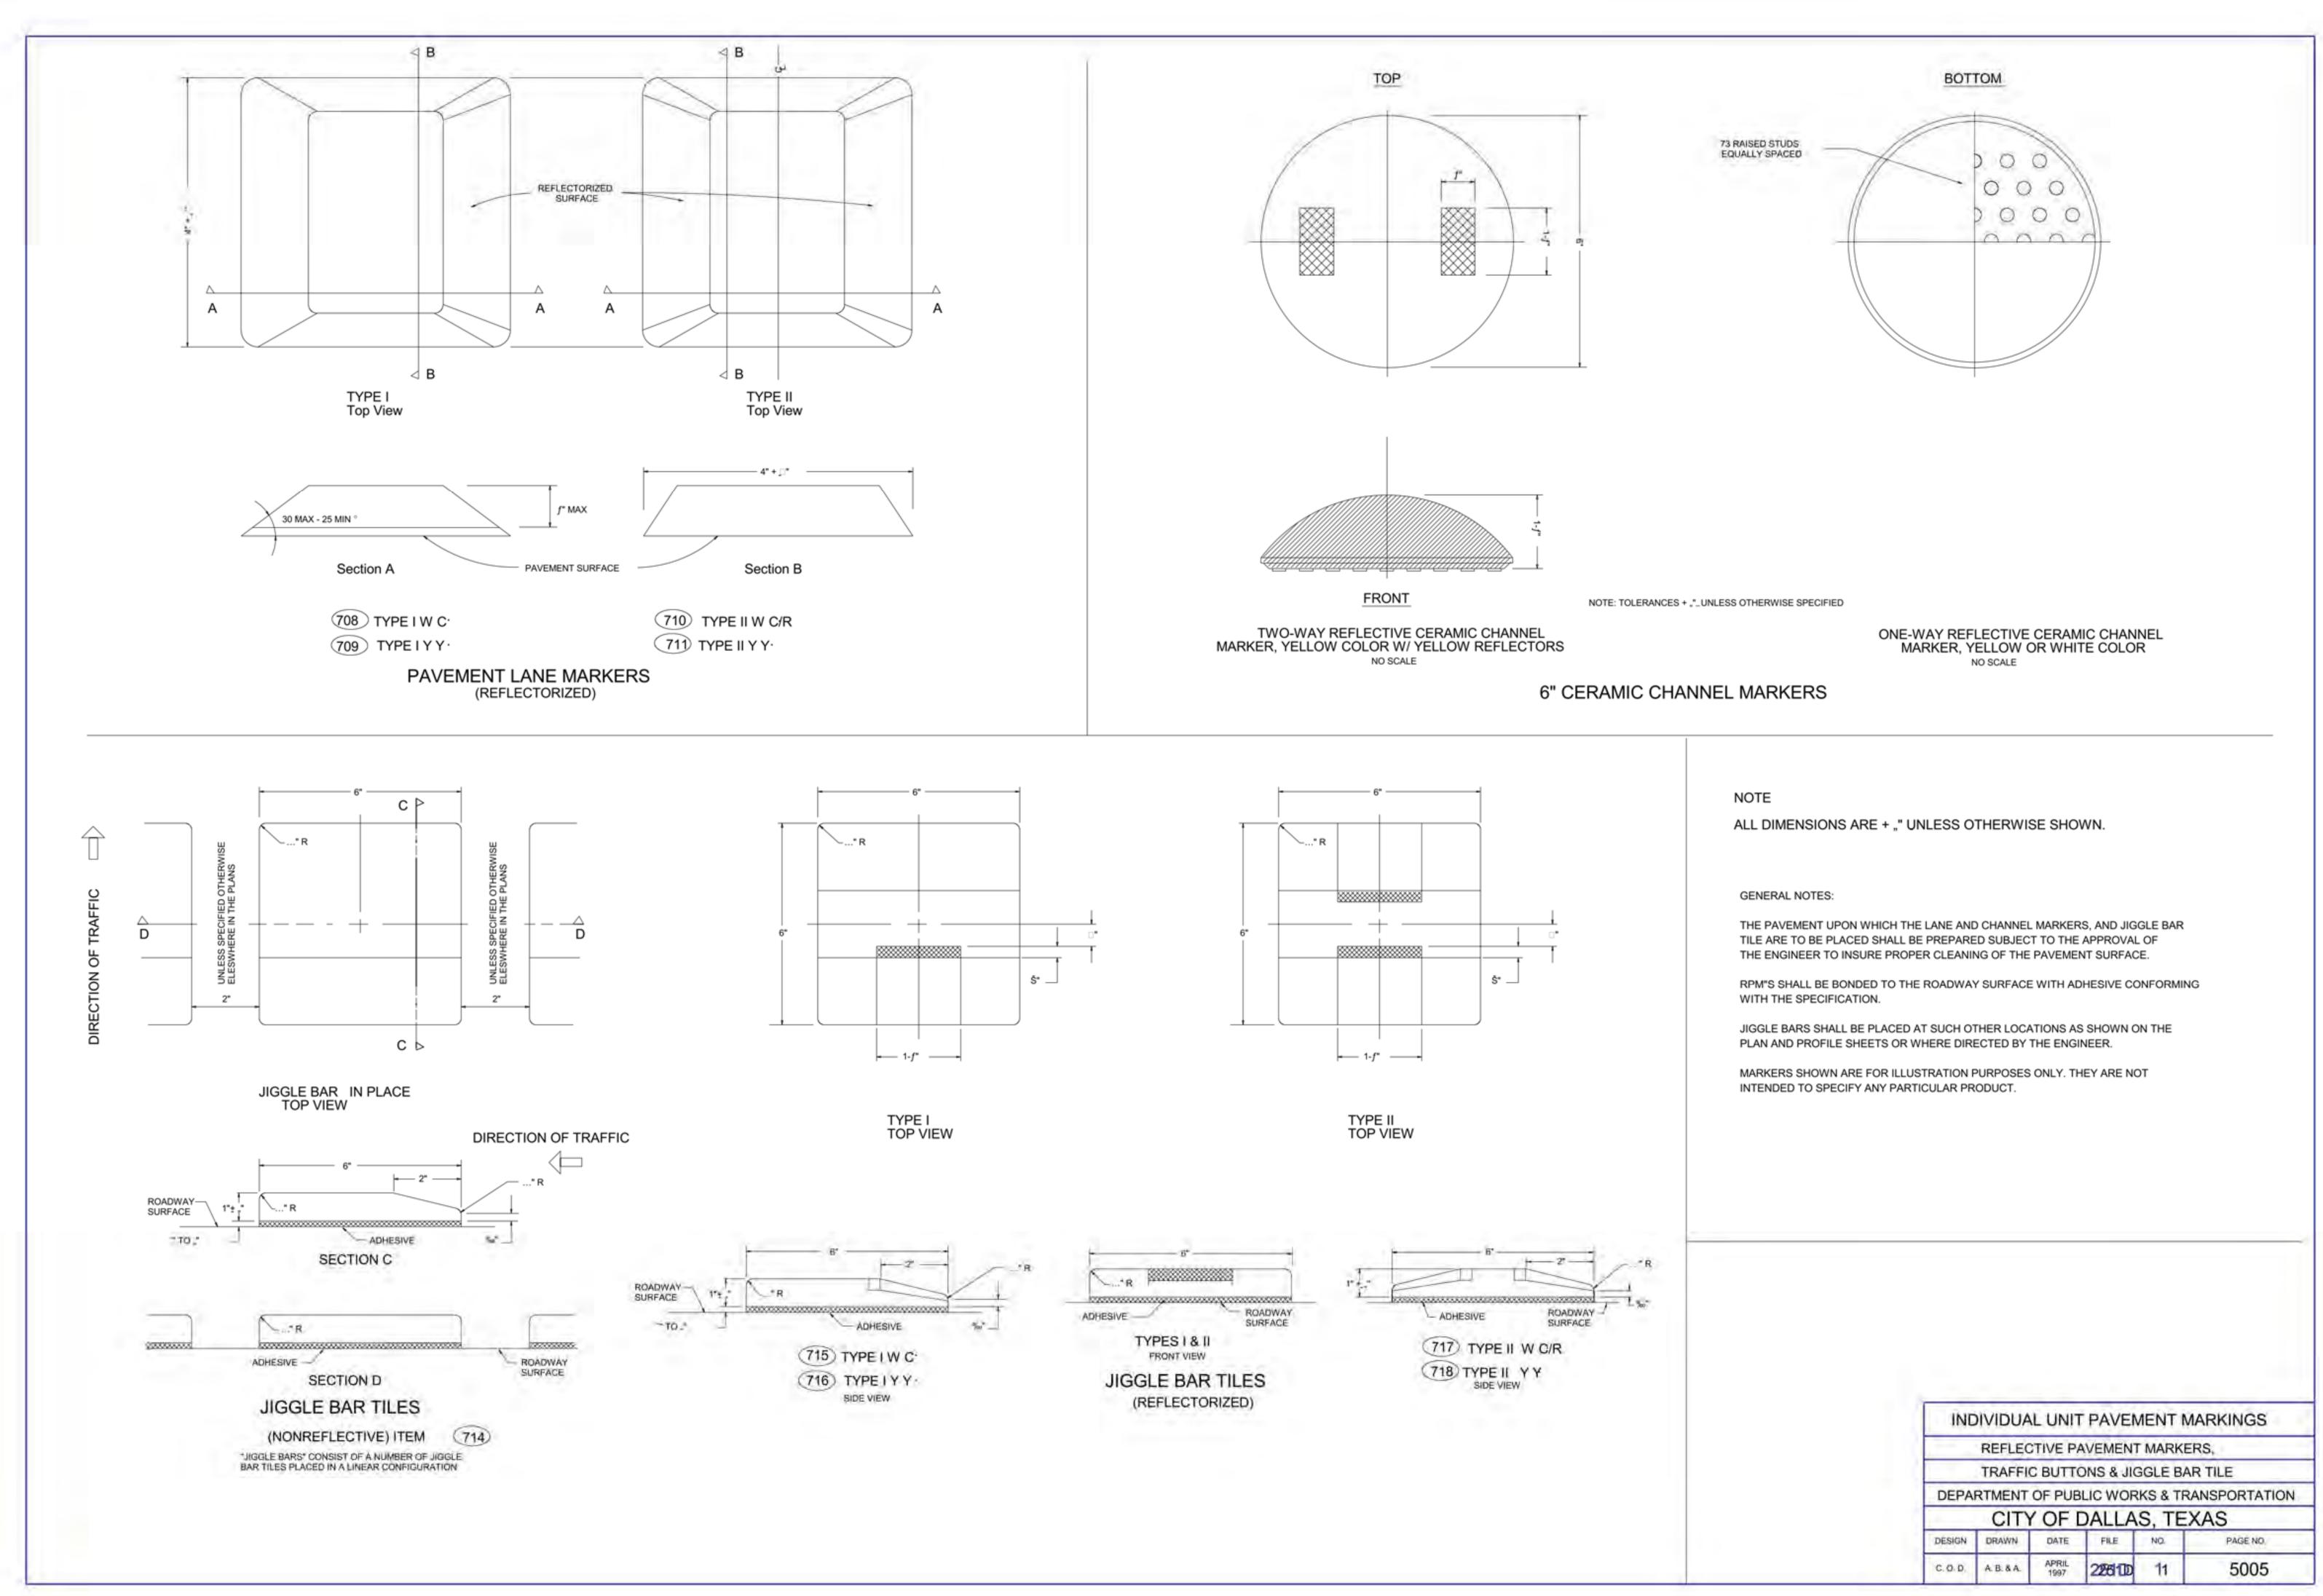


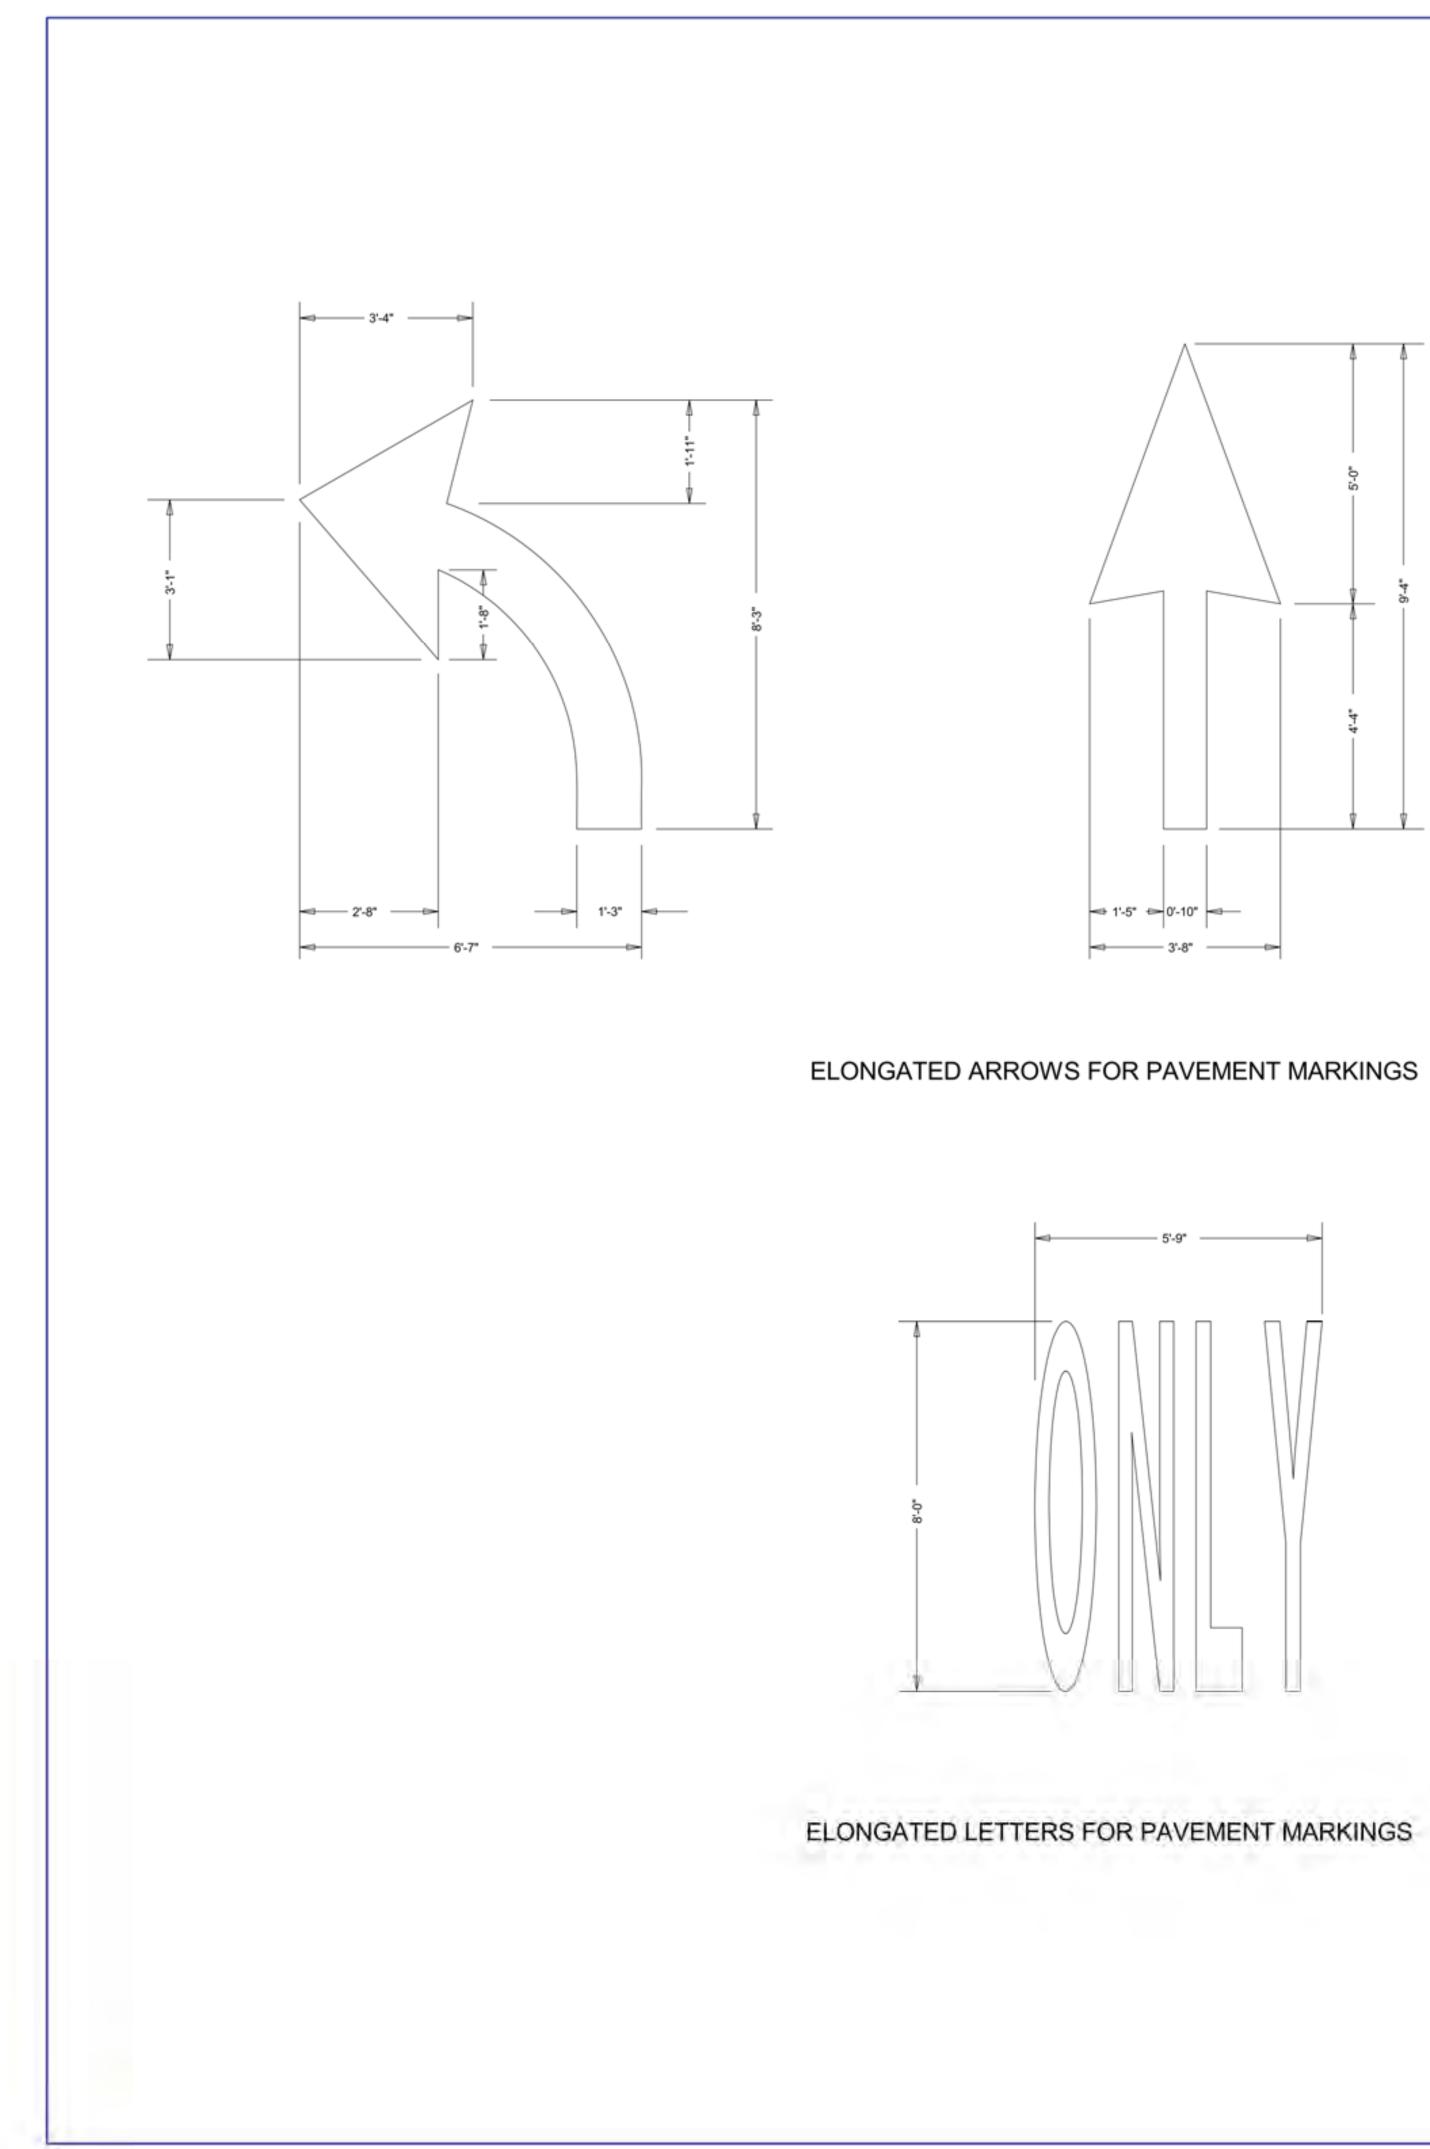


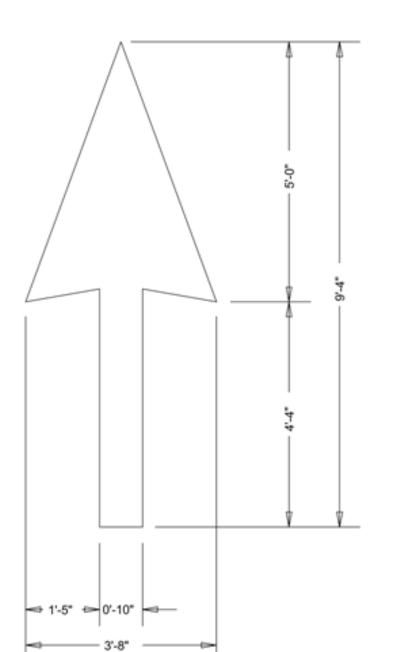


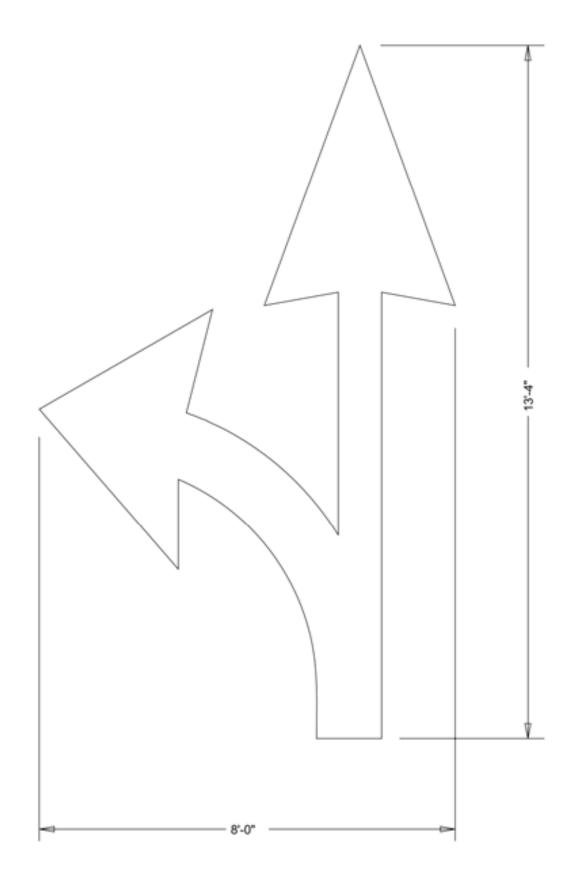


50						
50'						
		1				
		1				
10'						
50'	CROSSWALK (X. W.)	1" WHITE - Y E 6" WHITE 18 " WHITE WHITE				
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